GENERAL CONSTRUCTION NOTES:

- 1. NO SUBSURFACE INVESTIGATION HAS BEEN PERFORMED BY FOX & ASSOCIATES, INC. TO DETERMINE THE EXISTENCE OR LOCATION OF GROUND WATER, ROCK OR OTHER NATURAL OR MAN—MADE FEATURES. EXCEPT AS SPECIFICALLY INDICATED. NO ENVIRONMENTAL STUDIES HAVE BEEN CONDUCTED BY OUR FIRM
- 2. EXISTING UTILITY INFORMATION SHOWN HEREON IS FROM DRAWINGS AND/OR OTHER SOURCES PROVIDED BY OWNERS OF THE VARIOUS UTILITIES EXACT LOCATIONS SHALL BE DETERMINED IN THE FIELD BEFORE BEGINNING CONSTRUCTION. THE CONTRACTOR SHALL NOTIFY MISS UTILITY AT (1-800-257-7777) A MINIMUM OF 48 HOURS BEFORE BEGINNING ANY WORK SHOWN ON THESE DRAWINGS. ANY DAMAGE TO UTILITIES BY THE CONTRACTOR SHALL BE REPAIRED BY THE CONTRACTOR AT HIS EXPENSE AND TO THE SATISFACTION OF THE UTILITY OWNER. HAND PIT EXCAVATION SHALL BE PROVIDED AS NEEDED BY CONTRACTOR TO LOCATE EXISTING UNDERGROUND UTILITIES.
- 3. THE CONTRACTOR SHALL NOTIFY THE APPLICABLE MUNICIPAL, COUNTY AND/OR STATE
 AUTHORITIES AT LEAST 48 HOURS BEFORE BEGINNING ANY WORK WITHIN PUBLIC RIGHT (S) OF
 WAY.
- 4. THE CONTRACTOR SHALL VERIFY ALL SURFACE AND SUBSURFACE CONDITIONS (LOCATIONS AND ELEVATIONS) PRIOR TO BIDDING AND START OF CONSTRUCTION. ANY DISCREPANCIES BETWEEN THE DRAWINGS AND ACTUAL FIELD CONDITIONS SHALL BE REPORTED TO THE OWNER AND/OR ENGINEER BEFORE PROCEEDING IF THEY AFFECT THE DESIGN FEASIBILITY OF THIS PROJECT. ANY DAMAGE TO FACILITIES, STRUCTURES, PAVEMENT OR OTHER MAN—MADE ITEMS ON OR ADJACENT TO THE SITE OR NOT SPECIFICALLY INDICATED FOR THE DEMOLITION SHALL BE REPAIRED OR REPLACED AT CONTRACTOR'S EXPENSE AND TO THE SATISFACTION OF THE OWNER.
- 5. THE CONTRACTOR SHALL BE RESPONSIBLE FOR OBTAINING ALL NECESSARY PERMITS AND FOR COMPLYING WITH ALL APPLICABLE LEGAL AND REGULATORY REQUIREMENTS. CONTRACTOR SHALL OBTAIN ANY BONDS REQUIRED BY COUNTY/STATE FOR WORK WITHIN COUNTY/STATE RIGHT-OF-WAYS.
- 6. TEMPORARY EROSION CONTROL MEASURES WILL BE USED TO CORRECT CONDITIONS THAT DEVELOP DURING CONSTRUCTION THAT ARE UNFORESEEN DURING THE DESIGN STAGE OR THAT ARE NEEDED TO TEMPORARILY CONTROL EROSION THAT DEVELOPS DURING NORMAL CONSTRUCTION PRACTICES.
- 7. JOB SITE SAFETY SHALL BE THE SOLE RESPONSIBILITY OF THE CONTRACTOR.
- 8. EXISTING UTILITIES SHOWN HEREON ARE FOR INFORMATIONAL PURPOSES ONLY. EXACT LOCATIONS SHALL BE DETERMINED IN THE FIELD BEFORE BEGINNING CONSTRUCTION.
- 9. NO TITLE REPORT HAS BEEN CONDUCTED BY THIS COMPANY OR FURNISHED TO US BY OTHERS.
 PROPERTY LINE INFORMATION HAS BEEN TAKEN FROM DEED (S) OF RECORD AND NOT FIELD
- 10. IT SHALL BE THE SOLE RESPONSIBILITY OF THE OWNER AND/OR DEVELOPER TO OBTAIN ALL NECESSARY EASEMENTS AND/OR RIGHT OF WAYS NECESSARY IN ORDER TO COMPLETE THE PROJECT SHOWN ON THESE PLANS. FOX & ASSOCIATES, INC. WILL ASSUME NO RESPONSIBILITY OR LIABILITY ASSOCIATED WITH THE ACQUIRING OF OFFSITE EASEMENTS AND RIGHT OF WAYS.
- 11. THE WASHINGTON COUNTY DIVISION OF PUBLIC WORKS, ENGINEERING & CONSTRUCTION REQUIRE THAT A PRE—CONSTRUCTION MEETING BE HELD FOR ALL PROJECTS REGARDLESS OF AMOUNT OF DISTURBANCE. CONTACT THE WASHINGTON COUNTY DIVISION OF PUBLIC WORKS, ENGINEERING & CONSTRUCTION AT 240—313—2400 FIVE (5) DAYS PRIOR TO THE START OF CONSTRUCTION.
- 12. THE WASHINGTON COUNTY SOIL CONSERVATION DISTRICT REQUIRE THAT A PRE-CONSTRUCTION MEETING BE HELD FOR PROJECTS WHICH DISTURB OVER 15,000 S.F. OR OVER 500 C.Y. OF VOLUME. CONTACT THE WASHINGTON COUNTY SOIL CONSERVATION DISTRICT AT 301-797-6821 EXT. 3 FIVE (5) DAYS PRIOR TO THE START OF CONSTRUCTION.
- 13. ANY WORK WITHIN THE COUNTY RIGHT-OF-WAY WILL REQUIRE THE POSTING OF A PERFORMANCE BOND AND EXECUTED PUBLIC WORKS AGREEMENT PRIOR TO THE ISSUANCE OF THE GRADING PERMIT, INC ACCORDANCE WITH THE WASHINGTON COUNTY S-3 POLICY.
- 14. A COMPLETE SET OF APPROVED PLANS AND THE GRADING PERMIT ISSUED FOR CONSTRUCTION COVERED UNDER THIS PLAN MUST BE KEPT ON SITE BY THE PERMITEE AT ALL TIMES DURING THE CONSTRUCTION
- 15. TOPOGRAPHY SHOWN ON THESE PLANS IS FROM FIELD RUN SURVEY BY FOX & ASSOC., INC. DATED DECEMBER, 2022. SURVEYS ARE BASED ON COUNTY HORIZONTAL AND VERTICAL DATUM (NAVD 88 AND NAD 83).
- 16. THERE ARE NO FLOODPLAINS, STEEP SLOPES, STREAMS AND RELATED BUFFERS, OR HABITAT
 OF THREATENED OR ENDANGERED SPECIES IDENTIFIED BY THE U.S. FISH AND WILDLIFE SERVICE
 PER 50 CFR 17 AS REQUIRED TO BE SHOWN BY SECTION 314 OF THE SUBDIVISION
 ORDINANCE AND SECTION 4.21 OF THE ZONING ORDINANCE.
- 17. THERE IS NO 100 YEAR FLOODPLAIN ON THIS SUBJECT PROJECT AREA AS SHOWN ON FEMA PANEL No. 24043C0128D DATED 8/15/2017.

INDEX OF SHEETS

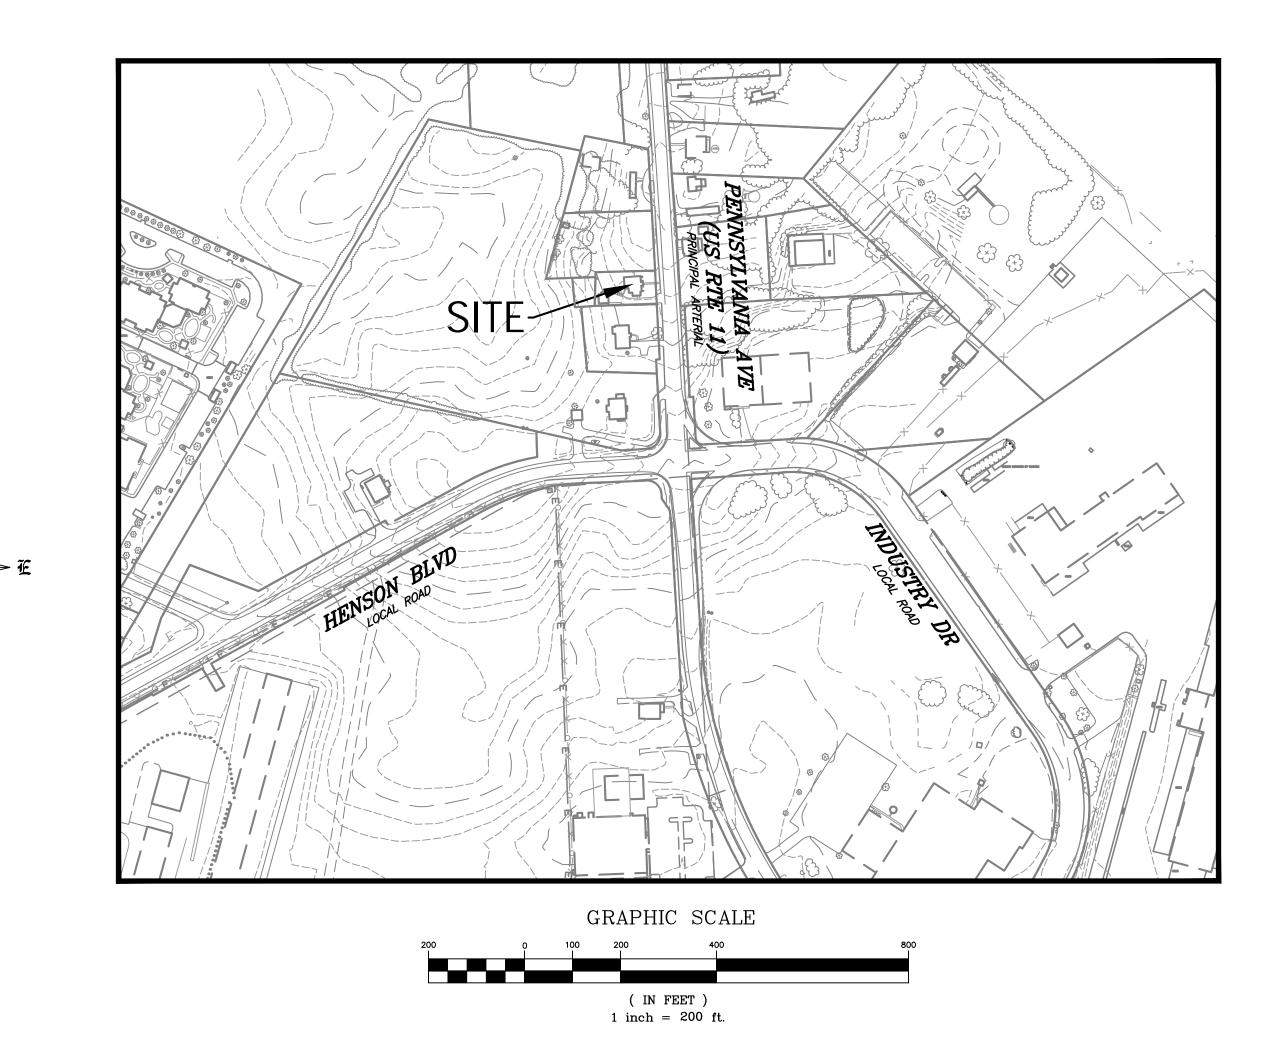
COVER SHEET
EXISTING CONDITIONS / DEMOLITION PLAN
GRADING / EROSION AND SEDIMENT CONTROL PLAN
SESC & SITE NOTES AND DETAILS

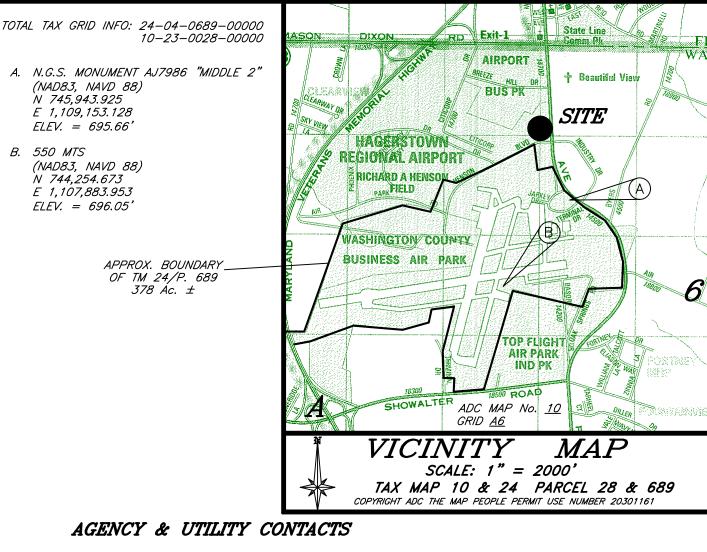
OWNER/DEVELOPER

WASHINGTON CO. COMMISSIONERS 100 WEST WASHINGTON STREET HAGERSTOWN, MARYLAND 21740 PHONE: (240) 313-2200

SITE SPECIFIC GRADING PLAN 14616 PENNSYLVANIA AVE DEMOLITION

SITUATED AT 14616 PENNSYLVANIA AVE WASHINGTON COUNTY, MARYLAND





COUNTY D.P.W. — ENGINEERING AND CONSTRUCTION
WASHINGTON COUNTY DEPT. OF WATER QUALITY (SEWER)
WASH. CO. SCD
CITY OF HAG. UTILITIES ENGINEERING
ANTICON

POTOMAC EDISON

COLUMBIA GAS

----- (240) 313-2400 ----- (240) 313-2600 DENISE PRICE (301) 797-6821 X 3 KELLEN DOUGLAS (301) 739-8577 X 653 KEN BUCKLER (301) 797-5000 JULIE LUDWIG (301) 790-7135 RICK USARY (301) 582-5210 VONDA GRIFFIN (800) 440-6111

SIGNATURE

DISTURBED AREA QUANTITIES

THE TOTAL AREA TO BE DISTURBED SHOWN ON THESE PLANS HAS BEEN DETERMINED TO BE APPROXIMATELY 0.2 ACRES AND THE TOTAL AMOUNT OF EXCAVATION AND FILL AS SHOWN ON THESE PLANS HAS BEEN COMPUTED TO BE APPROXIMATELY 177 C.Y. OF EXCAVATION AND 3 C.Y. OF FILL.

* THESE QUANTITIES ARE APPROXIMATE AND SHALL NOT BE USED BY THE CONTRACTOR FOR BIDDING PURPOSES.

OWNER/DEVELOPER CERTIFICATION - SCD

I/WE CERTIFY ALL/ANY PARTIES RESPONSIBLE FOR CLEARING, GRADING, CONSTRUCTION, AND/OR DEVELOPMENT WILL; BE DONE PURSUANT TO THIS PLAN AND RESPONSIBLE PERSONNEL INVOLVED IN THE CONSTRUCTION PROJECT WILL HAVE A CERTIFICATE OF TRAINING AT A MARYLAND DEPARTMENT OF THE ENVIRONMENT APPROVED TRAINING PROGRAM FOR THE CONTROL OF SOIL EROSION AND SEDIMENT.

DATE PRINTED NAME

DEVELOPER'S CERTIFICATION

I/WE HEREBY CERTIFY THAT ALL CLEARING, GRADING, CONSTRUCTION AND/OR DEVELOPMENT WILL BE DONE PURSUANT TO THIS PLAN AND IN ACCORDANCE WITH THE STORMWATER MANAGEMENT ORDINANCE OF WASHINGTON COUNTY AND THE POLICY ON CONSTRUCTION OF SUBDIVISION INFRASTRUCTURE FOR ACCEPTANCE AND OWNERSHIP BY WASHINGTON COUNTY (S-3).

DATE PRINTED NAME

WASHINGTON COUNTY SOIL CONSERVATION DISTRICT SOIL EROSION AND SEDIMENT CONTROL PLAN APPROVAL

(PLAN IS VALID FOR TWO YEARS FROM DATE OF APPROVAL)

GRADING & STORMWATER MANAGEMENT APPROVAL

WASHINGTON COUNTY DIVISION OF ENGINEERING

ENGINEER PROFESSIONAL CERTIFICATION

I HEREBY CERTIFY THAT THESE DOCUMENTS WERE

PREPARED OR APPROVED BY ME, AND THAT I AM

UNDER THE LAWS OF THE STATE OF MARYLAND.

A DULY LICENSED PROFESSIONAL ENGINEER

NAME GORDON S. POFFENBERGER
LICENSE No. 27053
EXPIRATION DATE 1/25/24

May May

DATE:

ENGINEER/ARCHITECT DESIGN CERTIFICATION

I HEREBY CERTIFY THAT THE PLANS HAVE BEEN DESIGNED IN ACCORDANCE WITH LOCAL ORDINANCES, COMAR 26.17.01.07, MARYLAND STANDARDS AND SPECIFICATIONS FOR SOIL EROSION AND SEDIMENT CONTROL.

May 02, 2023 DATE 27053 REG. NO. SIGNATURE

FOX & ASSOCIATES, INC.

ENGINEERS · SURVEYORS · PLANNERS

www.foxgssociatesinc.com Email: foxgssoc@foxgssociatesinc.com

981 MT. AETNA ROAD HAGERSTOWN, MD. 21740 PHONE: (301)733-8503 or (301)416-7250 FAX: (301)733-1853 82 WORMANS MILL COURT SUITE 'G' FREDERICK, MD. 21701 PHONE: (301)695-0880 FAX: (301)293-6009 & ASSOCIATES INC.


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DATE REVISION DRAWN BY

GP-23-003

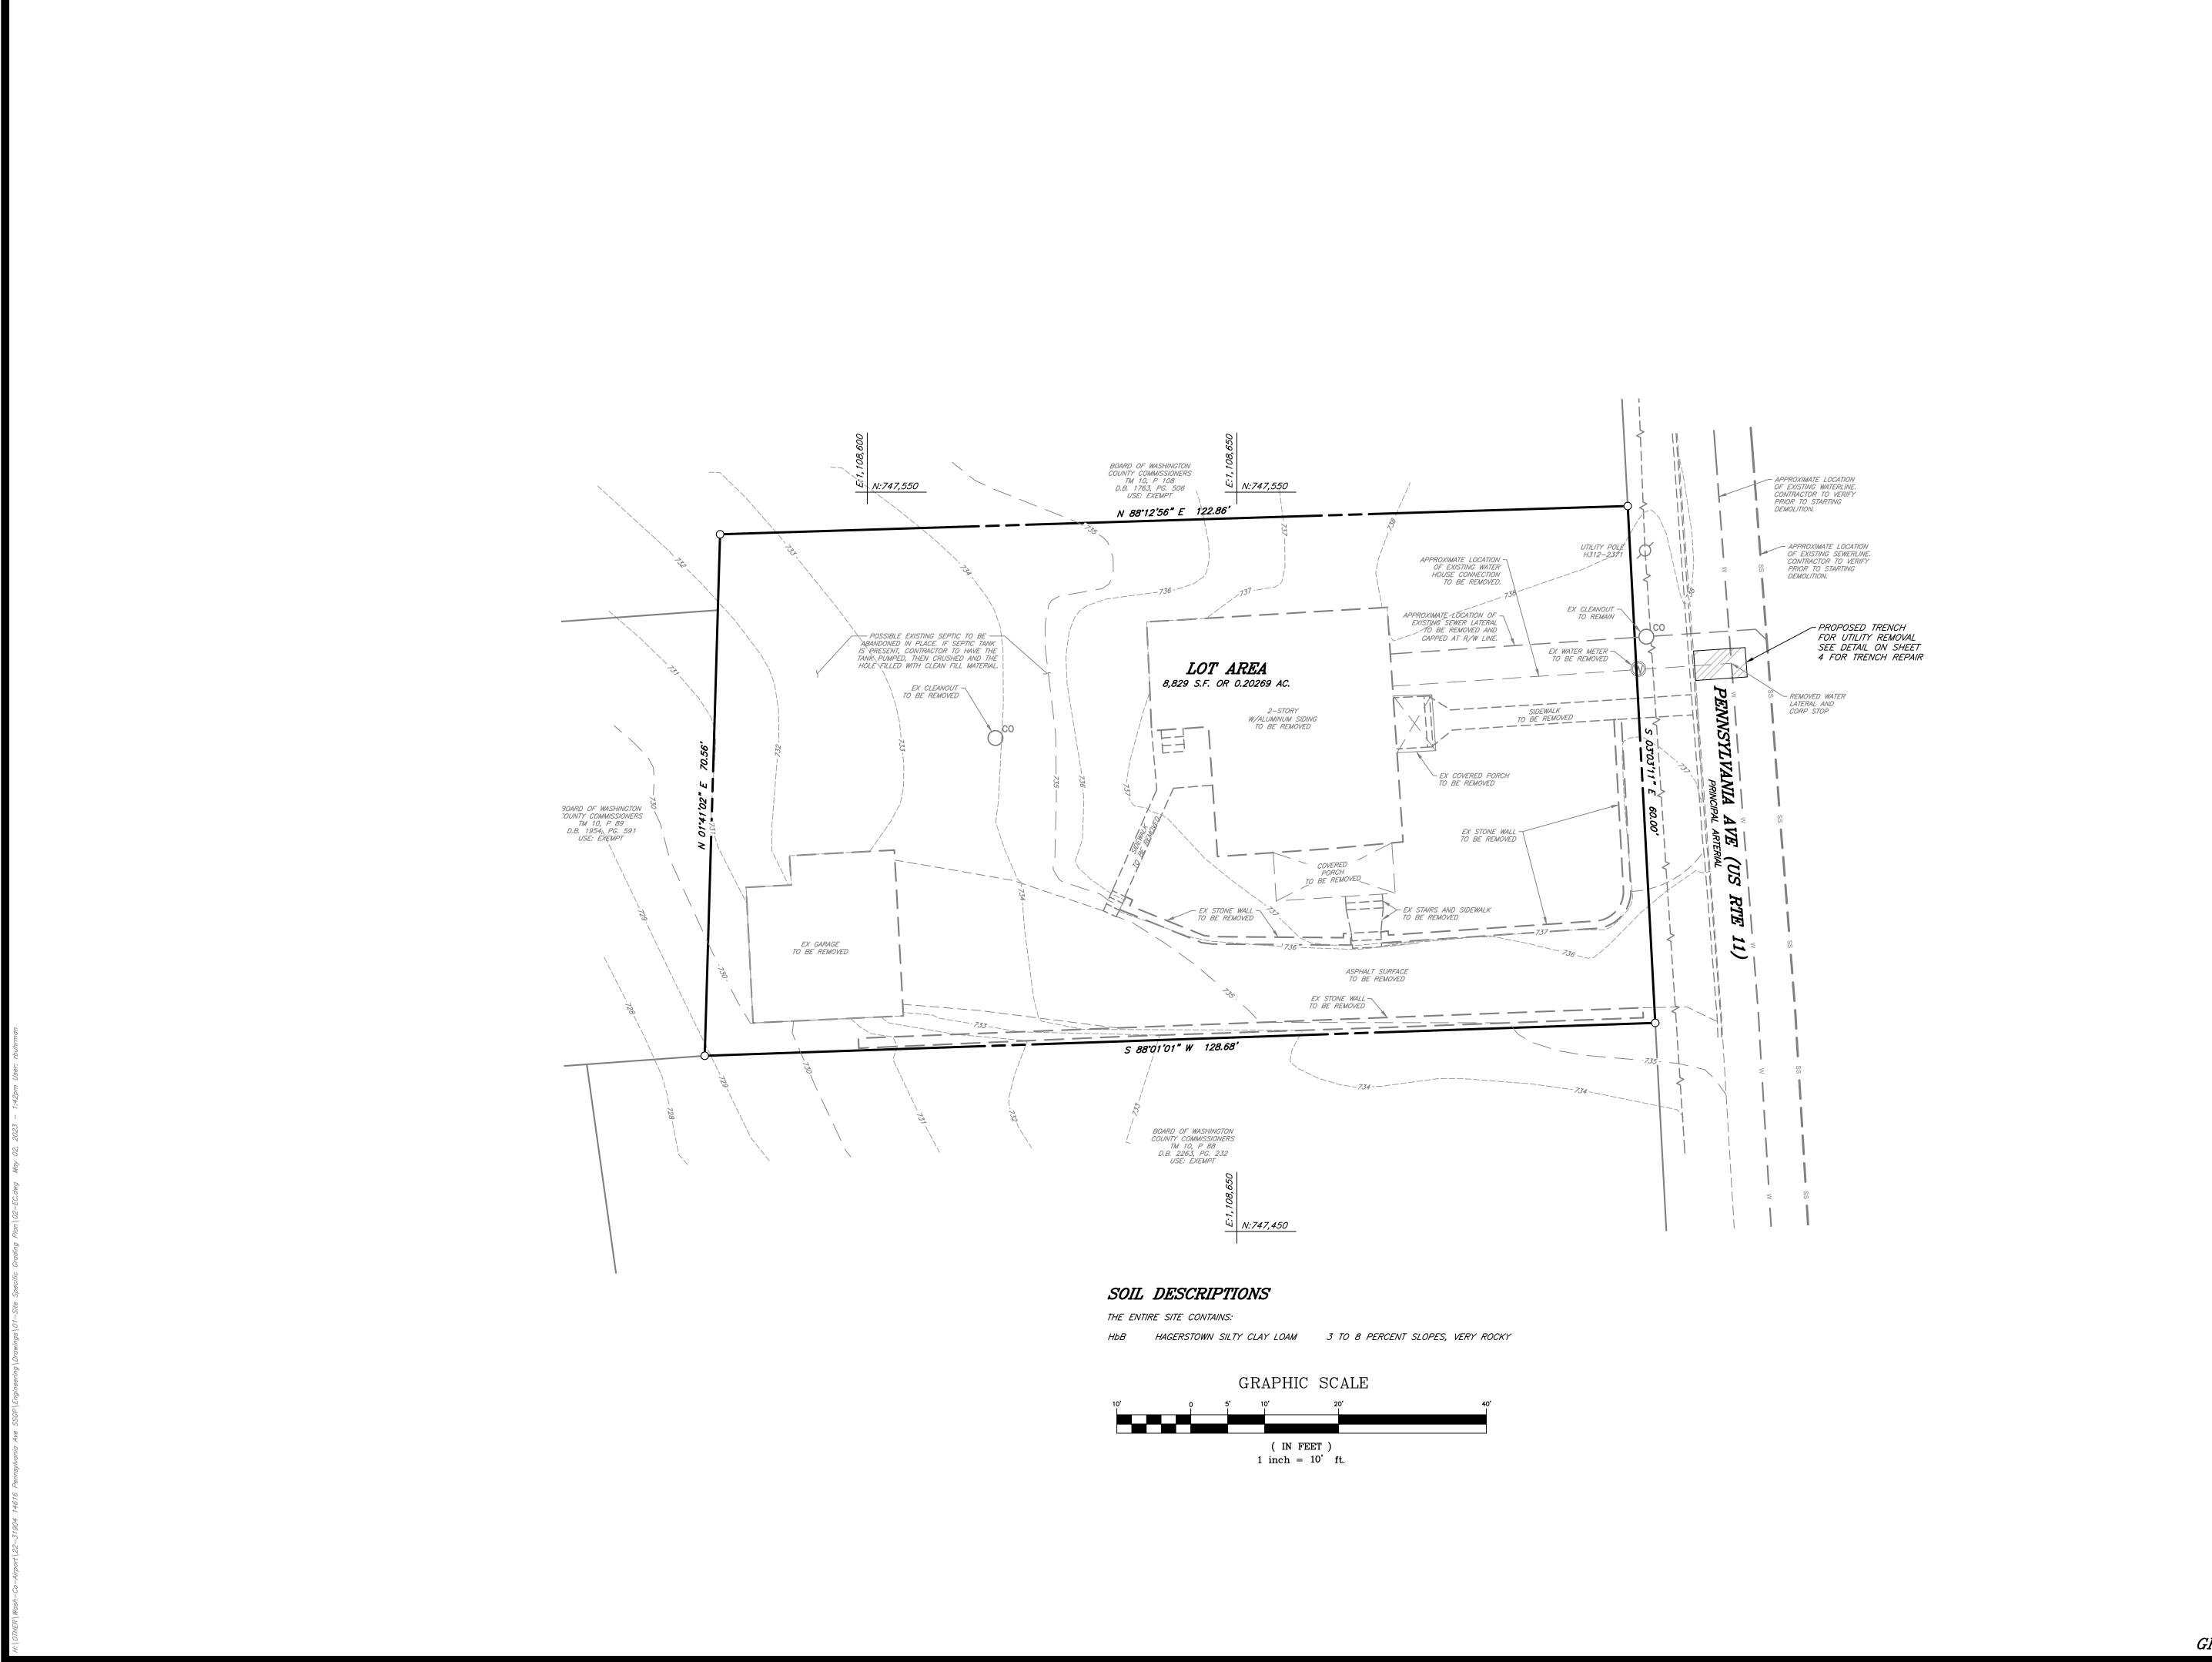D-9140 SHEET 1 OF 4





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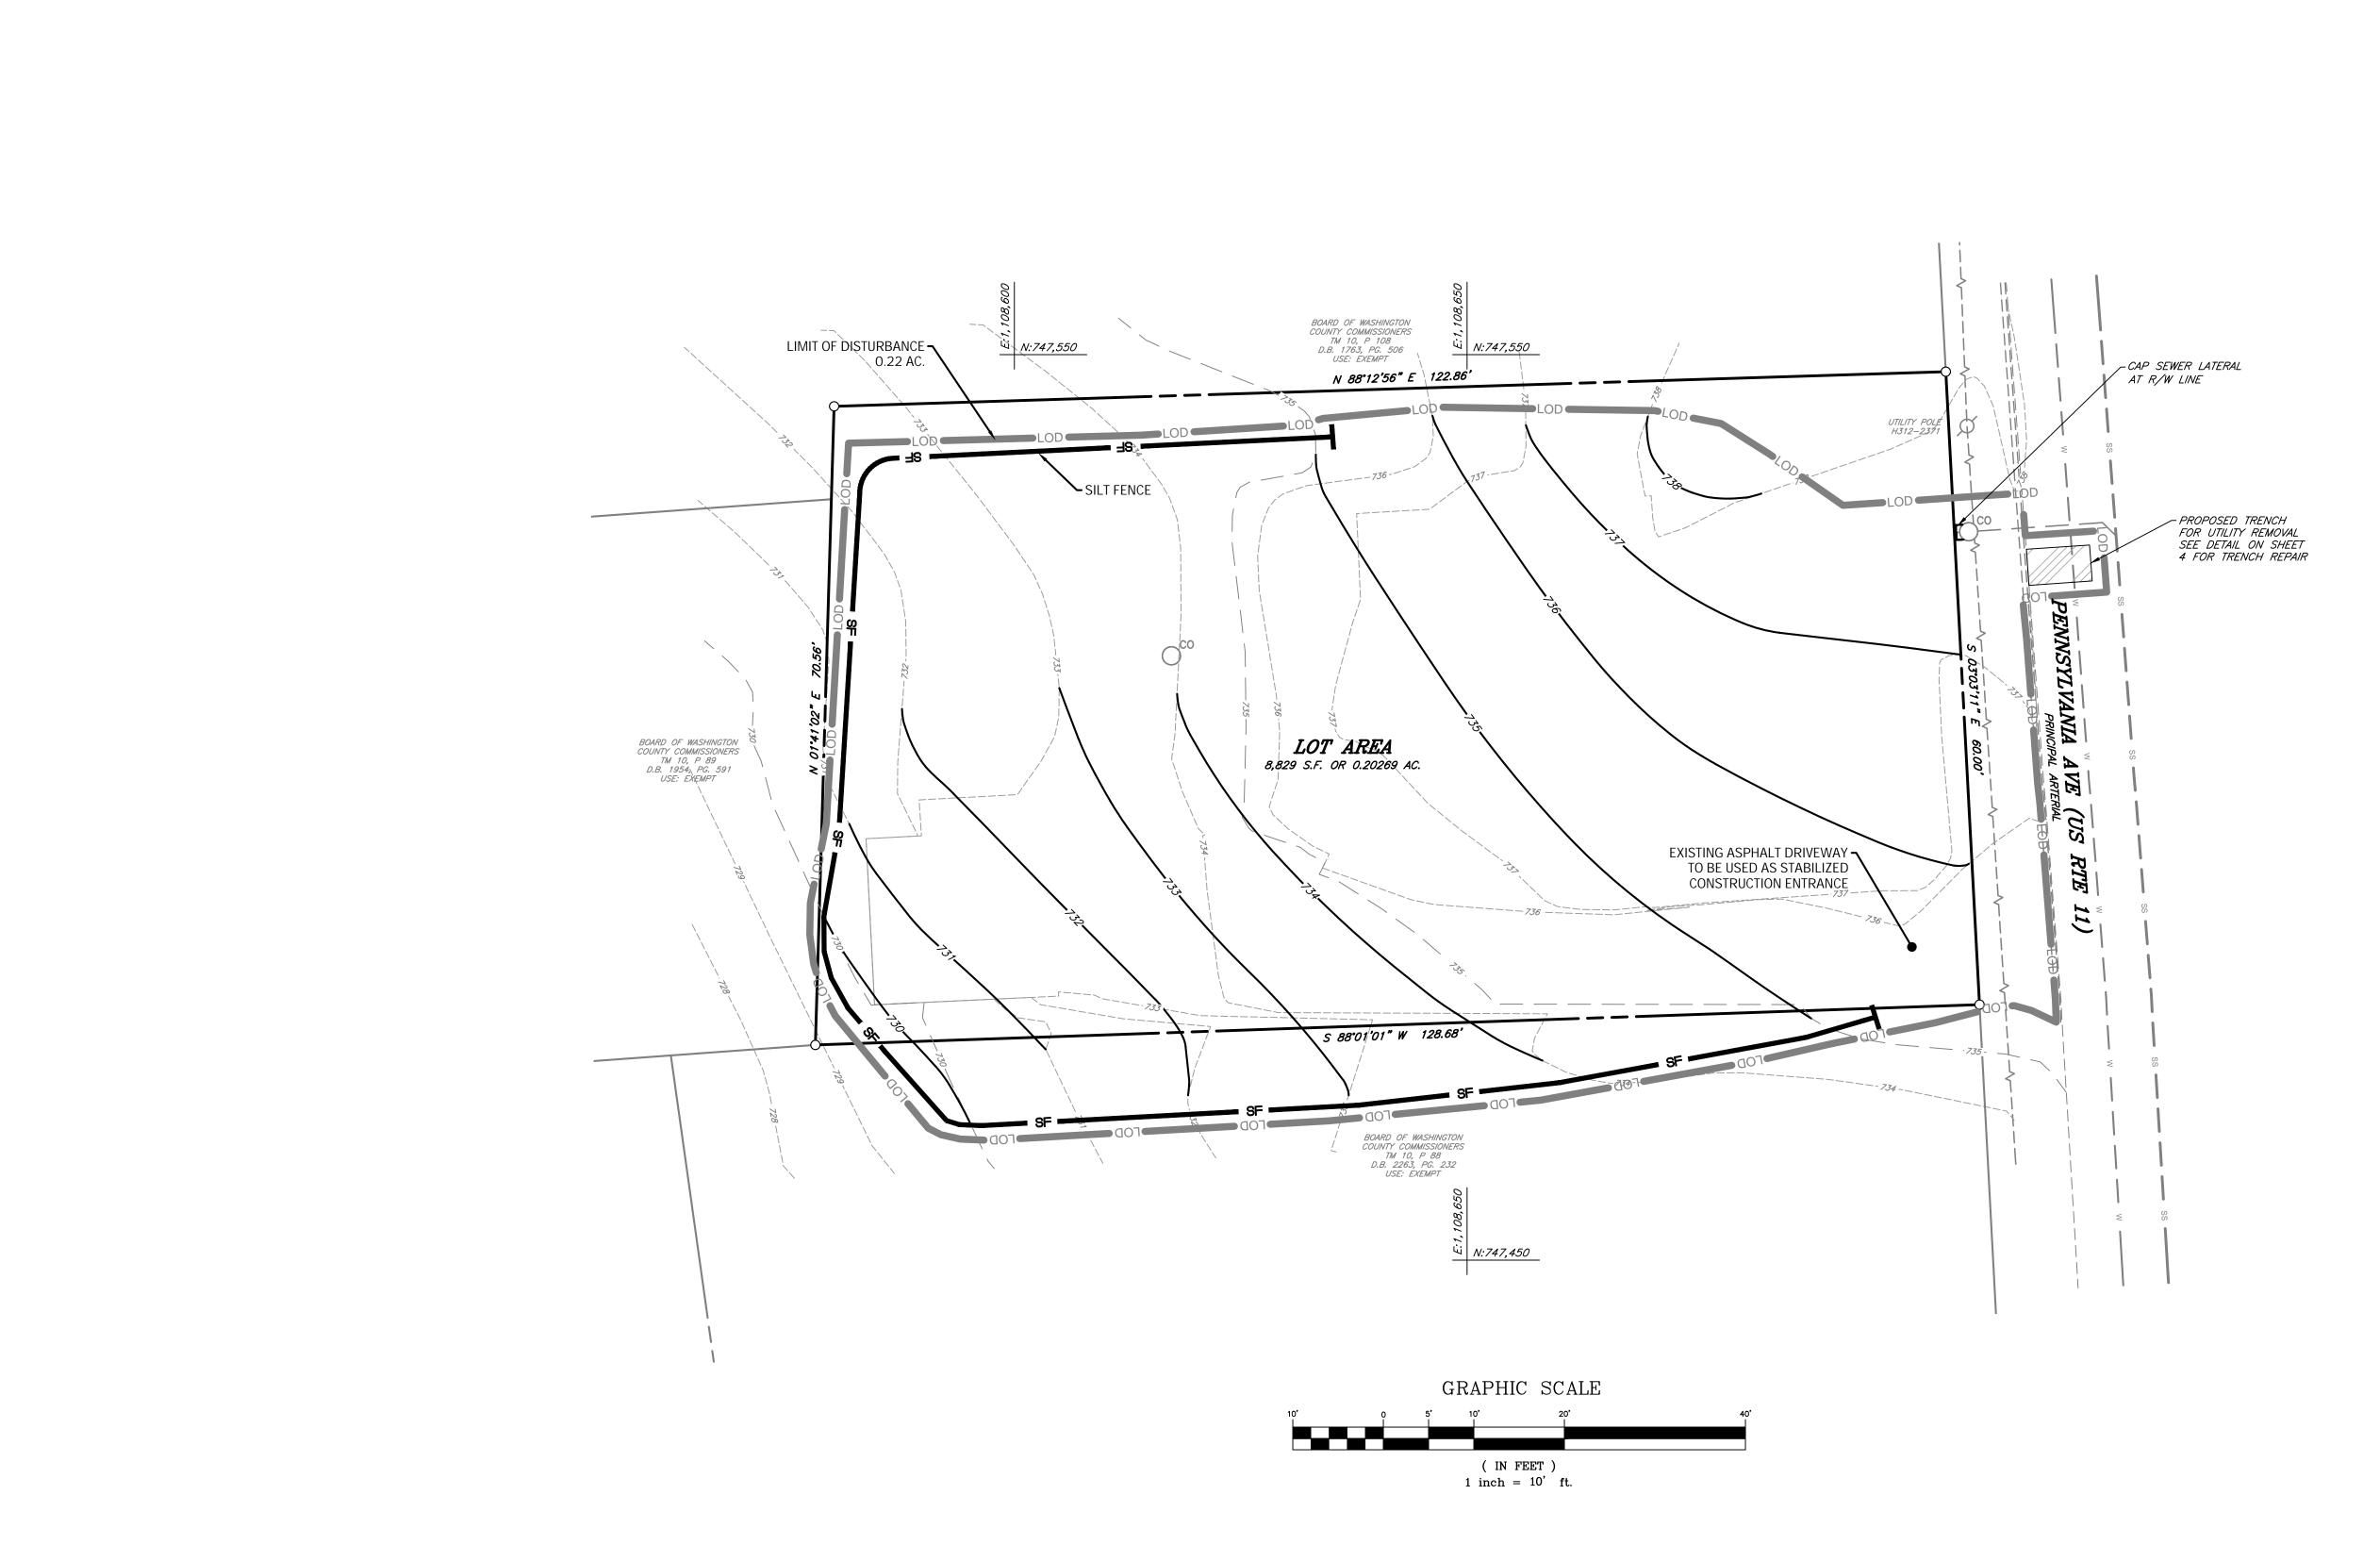
ASSOCIATES, INC.
S • SURVEYORS • PLANNERS N C ಷ

FOX

SCALE: 1"=10' I HEREBY CERTIFY THAT THESE DOCUMENTS
WERE PREPARED OR APPROVED BY ME,
AND THAT I AM A DULY LICENSED
PROFESSIONAL ENGINEER UNDER THE LAWS
OF THE STATE OF MARYLAND.
LICENSE No.: 27053 EXP. DATE: 1/25/24

PROJECT NO. 22-31904
DRAWING NO. D-9140
DATE: JANUARY, 2023 DRAWN BY: DCM CHECKED BY: GSP

SHEET_2 OF_4



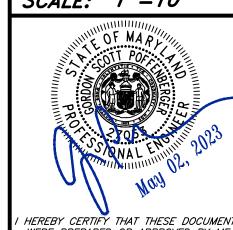


ASSOCIATES,
S • SURVEYORS • PLAN 8 FOX

GRADING SITE 14616

SCALE: 1"=10'

EROSION





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AND THAT I AM A DULY LICENSED
PROFESSIONAL ENGINEER UNDER THE LAWS
OF THE STATE OF MARYLAND.
LICENSE No.: 27053 EXP. DATE: 1/25/24

PROJECT NO. 22-31904
DRAWING NO. D-9140
DATE: JANUARY, 2023 DRAWN BY:_____DCM CHECKED BY: GSP

SHEET<u>3</u> OF <u>4</u>

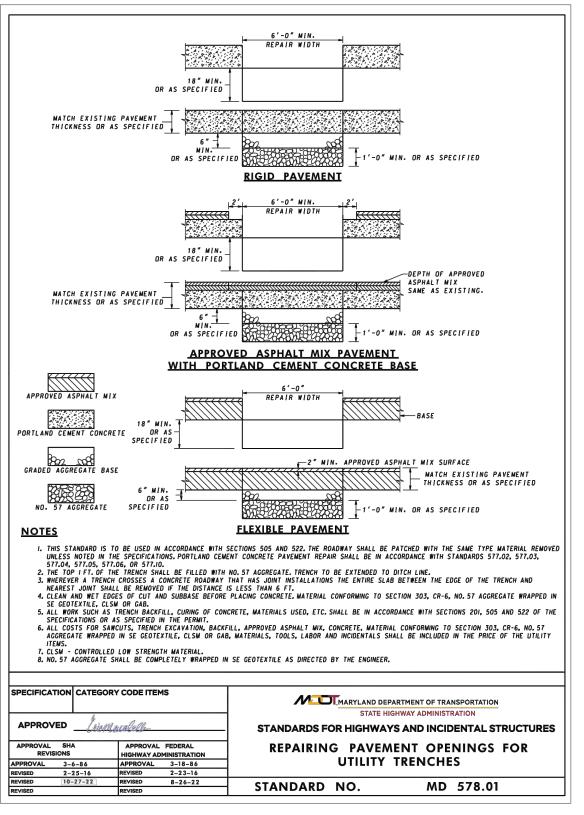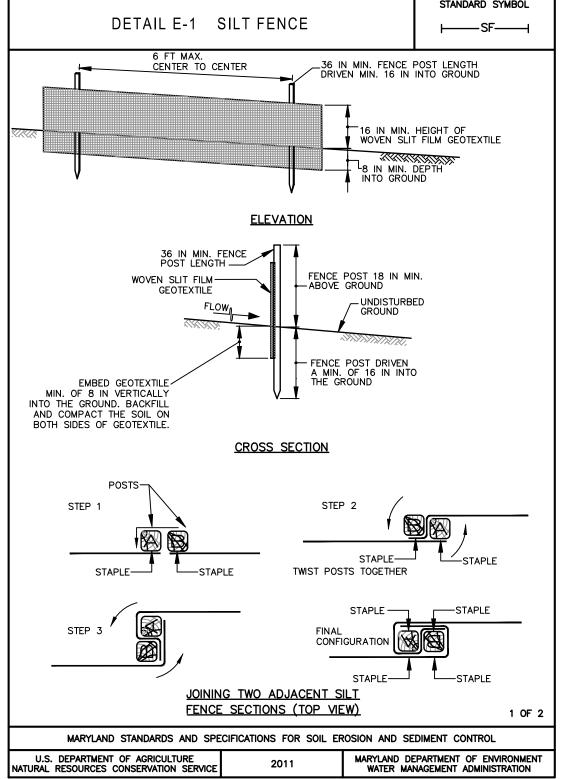- EXISTING PAVING TO BE UTILIZED AS STABILIZED CONSTRUCTION ENTRANCE.
- 2. ANY SPOIL AND/OR BORROW, MUST COME FROM AND/OR GO TO, A SITE WITH AN APPROVED AND CURRENT SOIL EROSION AND SEDIMENT CONTROL PLAN.





STANDARD UTILITY NOTES

- 1. CONTRACTOR TO ONLY OPEN UP LENGTH OF TRENCH THAT CAN BE CONSTRUCTED AND BACKFILLED IN ONE WORKING DAY.
- 2. CONTRACTOR TO PLACE EXCAVATED MATERIALS IN A DUMP TRUCK AND HAUL TO AN APPROVED LOCATION FOR WASTE MATERIALS FROM PAVED AREAS.
- 3. CONTRACTOR TO BACKFILL TRENCH WITH APPROVED MATERIALS AND STABILIZE DISTURBED AREAS THE SAME WORKING DAY.
- 4. IN AREAS WHERE THE CONSTRUCTION TAKES PLACE OUTSIDE OF THE EXISTING ROADBED, CONTRACTOR TO INSTALL SILT FENCE ALONG THE DOWNHILL SIDE OF THE TRENCH BEFORE BEGINNING CONSTRUCTION AND PLACE EXCAVATED MATERIAL FROM THE TRENCH ON THE UPHILL SIDE.
- 5. IF DEWATERING OF THE TRENCH IS REQUIRED. CONTRACTOR TO PUMP WATER TO A FILTER BAG TO DEWATER.
- 6. CONTRACTOR TO SWEEP STREET OF ANY DEBRIS OR SEDIMENTS CAUSED BY CONSTRUCTION OPERATIONS AND DISPOSE OF AT AN APPROVED LOCATION.
- 7. CONTRACTOR TO STABILIZE ALL DISTURBED AREAS WITH SEED & MULCH OR APPROPRIATE STREET REPAIR.

SEQUENCE OF CONSTRUCTION

- 1. CONTACT THE WASHINGTON COUNTY ENGINEERING DEPT. 5 DAYS PRIOR TO THE START OF CONSTRUCTION AT 240-313-2400.
- 2. NOTIFY WASHINGTON COUNTY SOIL CONSERVATION DISTRICT AT LEAST 5 DAYS PRIOR TO THE START OF CONSTRUCTION AT (301) 797- 6821 EXT. 3
- 3. INSTALL PERIMETER CONTROLS.
- 4. REMOVE EXISTING IMPROVEMENTS PER PLANS.
- 5. GRADE SITE PER PLANS.
- 6. SEED AND MULCH ANY REMAINING DISTURBED AREAS.
- POST-CONSTRUCTION NOTIFICATION- WHEN THE SITE IS FULLY STABILIZED, NOTIFY THE WASHINGTON COUNTY SOIL CONSERVATION DISTRICT AT 301-797-6821 EXT. 3 AND THE WASHINGTON COUNTY ENGINEERING DEPARTMENT AT 301-790-3200 PRIOR TO REMOVAL OF ANY SOIL EROSION AND SEDIMENT CONTROL MEASURES.

SOIL EROSION, SEDIMENT CONTROL & SEEDING NOTES

- 1. ALL EROSION/SEDIMENT CONTROL MEASURES SHALL COMPLY WITH THE "2011 MARYLAND STANDARDS AND SPECIFICATIONS FOR SOIL EROSION AND SEDIMENT CONTROL" AND THE PROVISIONS OF THE APPROVED PLAN.
- 2. ALL GRADING AND STABILIZATION SHALL COMPLY WITH THE "2011 MARYLAND STANDARDS AND SPECIFICATIONS FOR SOIL EROSION AND SEDIMENT CONTROL". "SECTION B - GRADING AND STABILIZATION" AND THE PROVISIONS OF THE APPROVED PLAN.
- 3. ALL SOIL EROSION AND SEDIMENT CONTROL PRACTICES (BMP'S) ARE TO BE CONSTRUCTED AND/OR INSTALLED PRIOR TO OR AT THE INITIATION OF GRADING IN ACCORDANCE WITH "2011 MARYLAND STANDARDS AND SPECIFICATIONS FOR SOIL EROSION AND SEDIMENT CONTROL". AND THE APPROVED PLAN.
- 4. A GRADING UNIT IS THE MAXIMUM CONTIGUOUS AREA ALLOWED TO BE GRADED AT A GIVEN TIME AND IS LIMITED TO 20 ACRES. WORK MAY PROCEED TO A SUBSEQUENT GRADING UNIT WHEN AT LEAST 50 PERCENT OF THE DISTURBED AREA IN THE PRECEDING GRADING UNIT HAS BEEN STABILIZED AND APPROVED BY THE ENFORCEMENT AUTHORITY AND/OR THE WASHINGTON COUNTY SOIL CONSERVATION DISTRICT (APPROVAL AUTHORITY). UNLESS OTHERWISE SPECIFIED AND APPROVED BY THE APPROVAL AUTHORITY, NO MORE THAN 30 ACRES CUMULATIVELY MAY BE DISTURBED AT A GIVEN TIME.
- 5. FOR INITIAL SOIL DISTURBANCE OR RE-DISTURBANCE, TEMPORARY OR PERMANENT STABILIZATION MUST BE COMPLETED WITHIN:
- a) THREE (3) CALENDAR DAYS AS TO THE SURFACE OF ALL PERIMETER DIKES, SWALES, DITCHES, PERIMETÉR SLOPES, AND ALL SLOPES STEEPER THAN 3 HORIZONTAL TO 1 VERTICAL (3:1); AND
- b) SEVEN (7) CALENDAR DAYS AS TO ALL OTHER DISTURBED OR GRADED AREAS ON THE PROJECT SITE NOT UNDER ACTIVE GRADING.
- 6. STOCKPILES MUST BE STABILIZED IN ACCORDANCE WITH THE 7 DAY STABILIZATION REQUIREMENT, AS WELL AS, STANDARD B-4-1 INCREMENTAL STABILIZATION AND STANDARD B-4-4 TEMPORARY STABILIZATION. (AS APPLICABLE)
- 7. ALL CONSTRUCTED CHANNELS AND SWALES SHALL HAVE SPECIFIED TREATMENT INSTALLED TO THE DESIGN FLOW DEPTH COMPLETED DOWNSTREAM TO UPSTREAM AS CONSTRUCTION PROGRESSES. AN INSTALLATION DETAIL SHALL BE SHOWN ON THE PLANS.
- 8. ALL STORM DRAIN AND SANITARY SEWER LINES NOT IN PAVED AREAS ARE TO BE MULCHED AND SEEDED WITHIN 3 DAYS OF INITIAL BACKFILL UNLESS OTHERWISE SPECIFIED ON PLANS.
- 9. ELECTRIC POWER, TELEPHONE, AND GAS LINES ARE TO BE COMPACTED, SEEDED AND MULCHED WITHIN 3 DAYS AFTER INITIAL BACKFILL UNLESS OTHERWISE SPECIFIED ON PLANS.
- 10. NO SLOPE SHALL BE GREATER THAN 2:1.
- 11. AS REQUIRED BY SECTION B, OF THE MARYLAND STANDARDS AND SPECIFICATIONS FOR SOIL EROSION AND SEDIMENT CONTROL, "ADEQUATE VEGETATIVE STABILIZATION", IS DEFINED AS 95 PERCENT GROUND COVER. THE WASHINGTON COUNTY SOIL CONSERVATION DISTRICT REQUIRES THE PROJECT ADHERE TO THIS FOR SCHEDULING OF THE FINAL SITE CLOSEOUT REVIEW, AND/OR THE RELEASE OF THE SITE FOR SOIL EROSION AND SEDIMENT CONTROL.

FOR SITES 1.0 ACRE OR MORE, THE FOLLOWING ARE REQUIRED:

- A. MARYLAND DEPARTMENT OF THE ENVIRONMENT, GENERAL PERMIT FOR STORMWATER ASSOCIATED WITH A CONSTRUCTION ACTIVITY, N.P.D.E.S. PERMIT NUMBER MDRC, STATE DISCHARGE PERMIT NUMBER 14GP, OR AN INDIVIDUAL PERMIT.
- B. THE MARYLAND DEPARTMENT OF THE ENVIRONMENT (GENERAL/INDIVIDUAL PERMIT NOTICE OF INTENT N.O.I.) APPLICATION AND PERMIT SHALL BE POSTED AND/OR AVAILABLE ON-SITE AT ALL TIMES.
- C. DURING CONSTRUCTION, ALL SOIL EROSION AND SEDIMENT CONTROL PRACTICES (B.M.P.'s) SHALL BE INSPECTED AND RECORDED ON THE "STANDARD INSPECTION FORM", "GENERAL PERMIT FOR STORMWATER ASSOCIATED WITH CONSTRUCTION ACTIVITY" PER MARYLAND DEPARTMENT OF THE ENVIRONMENT (GENERAL/INDIVIDUAL PERMIT - NOTICE OF INTENT - N.O.I.).
- D. FOLLOWING CONSTRUCTION AND RELEASE OF THE SIGHT FOR SOIL EROSION AND SEDIMENT CONTROL BY THE WASHINGTON COUNTY SOIL CONSERVATION DISTRICT, I.E., ALL PORTIONS OF A SITE HAVE BEEN PERMANENTLY STABILIZED, AND ALL STORMWATER DISCHARGES FROM THE CONSTRUCTION SITES THAT ARE AUTHORIZED BY THE PERMIT AREA ELIMINATED, THE AUTHORIZED PERMITEE SHALL SUBMIT THE MARYLAND DEPARTMENT OF

PERMANENT SEEDING SUMMARY

SEED MIXTURE (HARDINESS ZONE 6B) FROM TABLE B.3						FERTILIZER RATE (10–20–20)		
No.	SPECIES	APPLICATION RATE (LB/AC)	SEEDING DATES	SEEDING DEPTHS	N	P205	K20	RATE
6	TALL FESCUE WHITE CLOVER PERENNIAL RYE GRASS	40 5 25	3/1 - 5/15 8/1 - 10/15	1/4" - 1/2"	45 LB/AC (1.0 LB/ 1000 S.F.)	90 LB/AC (2 LB/ 1000 S.F.)	90 LB/AC (2 LB/ 1000 S.F.)	2 TONS/AC (90 LB/ 1000 S.F.)
	SECTION B-4-5 OF THE		T SEEDING SHALL IND STANDARDS .			AND SEDI	MENT CON	TROL

TEMPORARY SEEDING SUMMARY

SEED MIXTURE (HARDINESS ZONE 6B) FROM TABLE B.1					FERTILIZER DATE	UNG DATE	
No.	SPECIES	APPLICATION RATE (LB/AC)	SEEDING DATES	SEEDING DEPTHS	RATE (10–20–20)	LIME RATE	
2	BARLEY (HORDEUM VULGARE)	96	3/1 - 5/15 8/1 - 10/15	1.0"	436 LBS./AC. (10 LBS/1000 S.F.)	2 TONS/AC. (90 LBS/1000 S.F.)	


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WERE PREPARED OR APPROVED BY ME, AND THAT I AM A DULY LICENSED PROFESSIONAL ENGINEER UNDER THE LAWS OF THE STATE OF MARYLAND. LICENSE No.: 27053 EXP. DATE: 1/25/

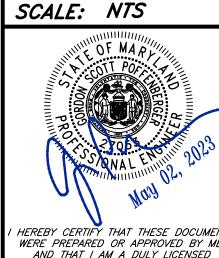PROJECT NO. 22-31904 DRAWING NO. D-9140 DATE: JANUARY, 2023 DRAWN BY:____DCM CHECKED BY: GSP

SHEET_4_OF_4