

# PURCHASING DEPARTMENT DIVISION OF BUDGET & FINANCE

### PUR-1751 ADDENDUM NO. 5 INVITATION TO BID

### HAGERSTOWN REGIONAL AIRPORT EXPAND/REHABILITATE TERMINAL BUILDING EAST

DATE: Monday, June 23, 2025 BIDS DUE: Friday, June 27, 2025

2:00 P.M.(EDT/EST)

To Bidders:

This Addendum is hereby made a part of the Contract Documents on which all bids will be based and is issued to correct and clarify the original documents.

Please acknowledge receipt of this Addendum at the appropriate space on the Proposal Form. This Addendum consists of eleven (11) pages and five (5) attachments.

NOTE: All Bidders must enter the Washington County Administration Complex through either the front door at the 100 West Washington Street entrance or through the rear entrance (w/blue canopy roof) which is handicap accessible and must use the elevator to access the Purchasing Department to submit their bid and/or to attend the Pre-Bid Conference. Alternate routes are controlled by a door access system. The general public will be subject to wand search and will be required to remove any unauthorized items from the building prior to entry. Prohibited items include but are not limited to: Weapons of any type; Firearms, ammunition, and explosive devices; Cutting instruments of any type - including knives, scissors, box cutters, work tools, knitting needles, or anything with a cutting edge, etc.; Pepper spray, mace, or any other chemical defense sprays; and Illegal substances.

**ITEM NO. 1:** *Inquiry*: Ref.: Electrical drawing and ADD Alt 1

The drawings depict power and lighting circuits that come from the Add alt 1 section to the Base bid section. Please provide details on how the handel this if the ADD Alt 1 is not completed.

<u>Response</u>: Under Base Bid, all new panels and electrical room are to be installed. If renovations under ADD Alt 1 are chosen, all new circuits under this renovation to be connected to panels installed under Base Bid.

100 West Washington Street, Room 3200 | Hagerstown, MD 21740-4748 | P: 240.313.2330 | F: 240.313.2331 | Hearing Impaired: 7-1-1

Addendum No. 5

### HGR Expand/Rehabilitate

### **Terminal Building East**

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#### ITEM NO. 2:

<u>Inquiry</u>: Ref.: Electrical room orientation During site visit the Designer mentioned that the 2 new transformers will be stacked rather than floor mounted. Please confirm and provide an up dated drawing.

*Response*: Refer to Drawing Revisions for updated transformer layout. (Attachment C)

#### ITEM NO. 3:

<u>Inquiry</u>: Ref.: New Electrical Panel tie in to existing service

Will the outage need to be during off hours? If so will escorts be required for off hours work

<u>Response</u>: This outage will need to be on a day when there are no scheduled service flights and/or during off work hours. Escorts will be provided by the Airport.

### ITEM NO. 4:

Inquiry: Ref.: New Electrical room construction Phasing

Will the existing roll up door be moved and the new electrical room be constructed before the new electrical panels need to be installed? If not the panels will be exposed to the elements, and need to be protected

<u>Response</u>: Refer to Drawing Sheet No. A1.3 (Attachment C) ENLARGED FLOOR PLAN AT NEW WORK

#### ITEM NO. 5:

Inquiry: Ref.: Security Rough in

Where is the security closet where security conduit should be routed to

<u>Response</u>: The security panels are located in the L shaped room on frame line 7 next to the hold room entrance and men's public toilet room.

#### ITEM NO. 6:

*Inquiry*: Ref.: Telecom Rough in

Where is the telecom room where telecom conduit should be routed to

<u>Response</u>: Refer to Drawing Revisions for clarification on telecom room locations. (Attachment B)

#### **ITEM NO. 7:**

*Inquiry:* Ref.: Airport Security

Will escorts be needed for any part of the work in the airport? If so will the customer be providing them, or will the GC be required to provide them?

*Response*: The airport staff shall provide airport security and escorting.

#### ITEM NO. 8:

*Inquiry:* Ref.: security system scope

Is the security cabling, devices, and head end equipment scope part of a separate contract. The specifications only refer to rough in

Response: Yes, this scope is for system rough in only.

#### ITEM NO. 9:

*Inquiry*: Ref.: telecom system scope

Is the telecom cabling, devices, and head end equipment scope part of a separate contract. The specifications only refer to rough in

<u>Response</u>: Telecom cabling, devices, and head end equipment to be provided under a separate contract. Electrical contractor is responsible for conduit and back box rough in only.

### ITEM NO. 10: Inquiry: Ref.: Drawing C1.3 Tie in to proposed wall mounted electrical box

- 1. This box is not shown on the electrical plans. Please provide a detail depicting this box and the conduits terminating in it.
- 2. Where in the building do these conduits go to once they terminate in this box

<u>Response</u>: Part 1 of Item No. 10 herein: This relocated wall mounted junction box is shown on plan sheet E1-1 - Demolition First Floor Plan – Electrical. This box is to receive two (2) 2" RGS conduits. (Attachment B)

<u>Response</u>: Part 2 of Item No. 10 herein: They run into the terminal building existing patch panel. These are in the L shaped room on frame line 7 next to the hold room entrance and men's public toilet room.

### **ITEM NO. 11:** *Inquiry*: Ref.: Drawing C1.3 proposed main gate

- 1. Please provide a detail for the electrical and controls required at the proposed main.
- 2. Please provide a detail for the proposed electrical box at this location

<u>Response</u>: Part 1 of Item No. 11 herein: Refer to Pedestrian Gate Detail 6 on Sheet CV5.1. Provide a 120V circuit from the existing electrical rack using a 15-amp breaker in the existing panel on the rack. Extend power in 1.5" RGS conduit with 12 AWG THHN/THWN-2 conductors to a weather-rated electrical box housing a 12/24VDC regulated power supply for the electric gate lock system. From this electrical box, extend all control wiring to the electric gate lock system as Class 2 low-voltage wiring in weather-rated conduit, with proper grounding in accordance with NEC requirements. (Attachment A)

<u>Response</u>: Part 2 of Item No. 11 herein: The electrical box shall be a NEMA 4X-rated, 8"x8"x4" enclosure securely mounted near the pedestrian man gate on the non-public side of the fence. It shall house wiring connections for the electric gate lock and key switch and be mounted on a nearby post, wall, or gate column. See REVISED sheet C1.3 Utility Plan. Also, see REVISED sheet CV5.1 Site Details 1, which eliminates the ground mounted electrical box/pedestal for the pedestrian gate since it will be mounted onto the proposed fence. (Attachment A)

### **ITEM NO. 12:** *Inquiry*: Ref.: lightning protection

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Will there be lightning protection required? None is shown.

Response: Lighting protection is not required

**ITEM NO. 13:** *Inquiry*: Who is the existing HVAC provider for the facility?

**Response**: The Airport uses the following:

Mick's Plumbing & Heating, Inc. – York Systems

27 Howard Street Thurmont, MD 21788 (Ph) 301-271-2488 (F) 301-271-2111

https://www.micksplumbinghvac.com/

### **ITEM NO. 14:** *Inquiry:* Floor questions:

- 1. There's a Vestibule below 101 Lobby, on A9.1 Floor Pattern Plan it calls that area to receive (F6) but there's no F6 listed on either the Color Schedule or the Legend on A9.1
- 2. Rooms 101 & 104 calls for the flooring to be "E-F1B" on A9.1, I assume this is existing so no new work needs done?
- 3. Rooms 105, 106, 108 & 115. Similar to above, the "E-F3" is existing to remain and we only need to install base on each side of the new wall?
- 4. B1 base on the millwork?
- 5. Note 3 on A9.1 "Patch and Repair Floor and Base as needed", I have no way to determine how much and of what type this would be. Can either you or I just carry an allowance?

<u>Response</u>: Part 1 of Item No. 14 herein: Refer to Revised Drawing A9.1 (dated 06.10.2025) (Attachment D)

<u>Response</u>: Part 2 of Item No. 14 herein: Refer to Revised Drawing A9.1 (dated 06.10.2025) (Attachment D)

<u>Response</u>: Part 3 of Item No. 14 herein: Refer to Revised Drawing A9.1 (dated 06.10.2025) (Attachment D)

<u>Response</u>: Part 4 of Item No. 14 herein: Provide base as specified.

Response: Part 5 of Item No. 14 herein: Yes.

**ITEM NO. 15:** *Inquiry*: Who is the DDC Controls contractor we need to use/tie into for this project?

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*Response*: The Airport uses the following:

Control Systems 934 Sweeney Dr.

Hagerstown, MD 21740

301 791-1166

http://www.csihagerstown.com/

**ITEM NO. 16:** 

<u>Inquiry</u>: Spec section 44313 for stone veneer is written as though we are working on an historic stone structure. The specification asks for experience in historic restoration in heavy natural stone structures. Clarify if this is required if we are still meeting the sample panel or the existing stone column wraps. Based on discussions at the site visit, is the sample panel or the mockup still required?

<u>Response</u>: A mock-up panel will be required during the construction phase. The existing stone pilasters will be the basis for quality control.

**ITEM NO. 17:** 

<u>Inquiry</u>: Refer to plan C1.0 - The conduits that are to be removed, what are they for and what cables are in them?

<u>Response</u>: There are existing electrical power and fiber optic conduits originating from the existing terminal building and extending to the electrical rack located in the area of the terminal expansion. These existing systems must be disconnected, relocated, and reconnected as part of this project. Conduit contains power feeding the existing electrical rack. The other conduits contain fiber optic cables serving the access control system, parking lot security cameras, and gate control systems.

**ITEM NO. 18:** 

*Inquiry*: Refer to plan C1.0 - What size is the manhole that gets removed?

<u>Response</u>: The manhole to be removed, as shown on Plan C1.0, is an approximately 2' x 2' electrical manhole. It contains conduit and cabling that feeds power from the existing terminal building to the electrical rack. Contractor shall verify exact size and contents in the field prior to removal and ensure all associated power feeds are properly rerouted and reconnected as part of the work. (Attachment A)

**ITEM NO. 19:** 

<u>Inquiry</u>: Refer to plan C1.3 - For the proposed Electrical, Fiber & Comm 4" RGS are there (3) conduits?

<u>Response</u>: Only two (2) RGS conduits are required: One (1) for electrical power, and one (1) for fiber optic and communication cabling.

**ITEM NO. 20:** 

<u>Inquiry</u>: Refer to plan C1.3 - What MEP sheets show the tie-in to the wall mounted electric box?

<u>Response</u>: This relocated wall mounted junction box is shown on plan sheet E1-1 - Demolition First Floor Plan – Electrical. (Attachment B)

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ITEM NO. 21: <u>Inquiry</u>: Refer to plan C1.3 - There is a 1.5" RGS conduit for communication shown to the proposed Gate, is a conduit for power required?

<u>Response</u>: The 1.5" RGS conduit shown on plan sheet C1.3 shall be used for power to the proposed pedestrian gate. Communication cable is only needed from the electrical box to the electrical gate lock system mounted on the pedestrian gate. See Item No. 11 above. A REVISED sheet C1.3 Utility Plan is included. (Attachment A)

ITEM NO. 22: <u>Inquiry</u>: On the "C" set of the drawings they show river rock in the area between the sidewalk and proposed building, but on the "CV" set it is not shown or called out on the legend. Please clarify what the intent is in that area.

<u>Response</u>: River Rock shall be installed in the area between the sidewalk and proposed building. A REVISED CV1.2 Final Conditions Plan is included which updates the legend to include the river rock. (Attachment A)

ITEM NO. 23: <u>Inquiry</u>: Numerous Wage Rates still missing from Addendum # 1 Determination. (Stone Mason, Painter, Dump Truck Driver, Drywall, Drywall Finisher, Tile Setter, Crane Operator, Sprinkler fitter, Fence Erector, ect.). Please provide a complete determination for the project.

<u>Response</u>: At this time, the U.S. Department of Labor (DOL) has not issued a Building wage determination for Washington County, Maryland that includes all of the classifications noted in your inquiry (e.g., Stone Mason, Painter, Dump Truck Driver, Drywall Installer, Tile Setter, Crane Operator, Sprinkler Fitter, Fence Erector, etc.). The applicable federal wage determinations for this project are:

- MD20250126 (Building), dated 03/14/2025
- MD20250078 (Heavy/Highway), dated 03/14/2025

In accordance with federal Davis-Bacon requirements, any labor classifications not listed in these determinations will be addressed post-award through the DOL's conformance process using Standard Form SF-1444. This is a routine procedure used for adding classifications not included in the published determination.

As the contracting agency, we will coordinate and facilitate this conformance process with the DOL after contract award, if necessary. In the meantime, bidders should include all anticipated labor classifications in their bids and propose wage and fringe rates that reflect prevailing local market conditions for those trades.

We recommend all bidders review Wage Determinations MD20250126 (Building) and MD20250078 (Heavy/Highway), both dated 03/14/2025, and prepare their bids accordingly, understanding that a formal conformance request may be submitted following award if needed.

ITEM NO. 24: <u>Inquiry</u>: It was discussed at the pre-bid that the new 119 electric room was not going to be installed in Phase 1 due to security issues and that the panels and transformers

will be wall mounted and the existing OHD door to be relocated (116B) would now be a new door. It was discussed that this would to be addressed in Addendum 1, but this did not occur. Please clarify.

*Response*: Refer to Revised Drawing A1.3 (dated 06.17.2025) (Attachment C) and Revised Drawing D1.1 (dated 06.18.2025). (Attachment B)

ITEM NO. 25: Inquiry: Can you tell me watch manufacturer provided the existing ticket counters? Plan A1.3 says that we are to match the existing ticket counters, but the existing ticket counters do not match the details on A6.2. The existing counters have stainless steel angles at the corners of the low luggage check-ins and A6.2 shows SS end panels. The vented doors on the attendant side are different than the provided A6.2 elevation. Elevations 2/A6.2 and 5/A6.2 appear to be elevations at the same viewing but are different. It is not clear what we are to provide.

Response: The manufacturer who provided the existing Ticket Counters is:
Beachley Furniture Company
858 Willow Cir, Hagerstown, MD 21740
301 733-1910
http://beachlev.com/

Also, refer to Revised Drawings A6.1 and 6.3 (dated 06.12.2025) for additional clarification. (Attachment D)

ITEM NO. 26: <u>Inquiry</u>: What is the desired path, thru the exposed structure areas, of the conduits from the new addition to the existing electric room for the normal and emergency feeders, the RTU feeder and other lighting branch circuits?

<u>Response</u>: Conduit path to be determined in field by contractor to cause minimal disruption to existing functional spaces. All outages to be coordinated in advance with owner.

ITEM NO. 27: <u>Inquiry</u>: It was mentioned at the pre-bid that any work in the main terminal area or TSA controlled areas must cease while a plane is preparing to or departing. I assume this would also be the case for arrivals. Please provide a schedule as to when work may or may not be allowed in these areas.

<u>Response</u>: A detailed flight operations schedule will be provided to the awarded contractor prior to the start of work. Access to the main terminal area, including TSA-controlled and sterile areas, will be restricted during aircraft operations unless proper clearance is obtained.

Specifically, the bag makeup area and all areas behind the Allegiant ticket counter will be inaccessible starting two (2) hours prior to a scheduled arrival and until approximately 15–20 minutes after departure. These restrictions apply to both arriving and departing Allegiant flights to maintain security and operational safety.

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Alternatively, if contractor personnel complete SIDA (Security Identification Display Area) training and receive airport-issued security badges, they may be granted access to work in these areas during flight operations. The contractor is responsible for coordinating badge applications and training with airport security in advance of the work.

**ITEM NO. 28:** *Inquiry:* The civil drawings contain a note to remove an electrical manhole and associated conduit. Have these conductors, cables or fibers been previously removed?

<u>Response</u>: No, these conduits, conductors, and/or cables have not been previously removed.

ITEM NO. 29: <u>Inquiry</u>: The civil drawings contain electrical notes for fiber and communication relocations and to refer to the MEP sheets. There is limited reference to this work on the electrical plans. Please advise all requirements to be included with this project.

<u>Response</u>: There are existing electrical power and fiber optic conduits originating from the existing terminal building and extending to the electrical rack located in the area of the terminal expansion. These existing systems must be disconnected, relocated, and reconnected as part of this project. Conduit contains power feeding the existing electrical rack. The other conduits contain fiber optic cables serving the access control system, parking lot security cameras, and gate control systems.

Contractor shall include all labor, materials, equipment, coordination, and testing necessary to safely remove, reroute, and restore full functionality of these systems. The intent is to maintain uninterrupted service or provide temporary service as required during construction.

Refer to Civil and Electrical drawings for routing and coordination and confirm final termination locations and requirements with the Owner's representative during construction.

ITEM NO. 30: <u>Inquiry</u>: Reference sheet E3-1, notes 7 and 8. Please specify all required conduit sizes and types along with a specification for the fiber and any other required cables or wiring. Are there any temporary operational requirements, during the time between removing the existing cable, relocating the raceway onto the new building addition, and then reinstalling this cable?

<u>Response</u>: Refer to REVISION TO PLANS. DELETE Drawing A2.4 in its entirety and REPLACE with Revised Drawing A2.4, dated 06.18.25. Sloped glazing system is shown on Drawing A4.5 with details on Drawing A2.4. Provide 3/8" polycarbonate glazing. All fiber and cabling requirements to be coordinated by low voltage contractor with owner. Coordinate all temporary operational requirements with owner. (Attachment B)

**ITEM NO. 31:** *Inquiry*: It was mentioned at the site visit that the new lockers shown in the 113

Breakroom on plan A1.3 would not be required and that we are only relocating the existing lockers. If this is not the case, we need a locker specification since the existing lockers a mixed variety, and brands.

<u>Response</u>: New lockers will not be required. Existing lockers will be relocated.

ITEM NO. 32: <u>Inquiry</u>: Addendum 1, plan A1.9 shows a total of 230 new seats related to Alternate 2. If you count the seating shown, the total should be 237. Please clarify.

<u>Response</u>: DELETE Drawing A1.9, Rev Date 06.10.2025 in its entirety and REPLACE with Revised Drawing A1.9, Rev Date 06.19.2025. (Attachment A)

- ITEM NO. 33: <u>Inquiry</u>: Specification 083336 Overhead Coiling Doors: Page 4 of specs; #6 a & b: Finish for Bottom Bar, Guides and Brackets:
  - 1. Says Black powder coat finish.
  - 2. Says PowderGuard Zinc base with Gray Powdercoat Premium top finish.

(Sample submittal specs call for 6" long sections of each with b) choice) (Note: Those submittal samples will have a significant cost.)

<u>Response</u>: Part 1 of Item No. 33 herein: Spec Section 083336, Article 2.2.A.6; DELETE Subparagraph a. in its entirety.

<u>Response</u>: Part 2 of Item No. 33 herein: Spec Section 083336, Article 2.2.A.6; Provide Subparagraph 'b.' as specified.

<u>Response</u>: Sample Submittal of Item No. 33 herein: Spec Section 083336, Article 1.5; DELETE Paragraph E. in its entirety.

- ITEM NO. 34: <u>Inquiry</u>: Specification 083336 Overhead Coiling Doors : Page 4 of specs; #10 c: Calls for operator to have;
  - 1. Radio control operation (Need more information, and quantity)
  - 2. Card reader control (Need more information, and quantity)

Response: Part 1 of Item No. 34 herein: Radio control operation NOT required

<u>Response</u>: Part 2 of Item No. 34 herein: Spec Section 083336, Article 2.2.A.10; DELETE Subparagraph c. in its entirety.

ITEM NO. 35: <u>Inquiry</u>: Specification 083336 – Overhead Coiling Doors : - Page 6 of specs; #3.7: Lists 4 coiling doors and 1 coiling grille; none of which are listed in the Door Schedule. **Response**: A Card Reader is not required for the Overhead rollup doors.

ITEM NO. 36: Inquiry: I would like to respectfully request your consideration of Sarnafil S327 60mil Thermoplastic Polyvinyl-Chloride (PVC) Roofing, as an alternate on the upcoming Hagerstown Airport Expand/East Terminal Bldg Rehabilitation. Our roof is on this facility now and we hold the warranty. I have attached the Sarnafil Data Sheet as it pertains to the project specifications. Our Sarnafil 60 mil membrane is Energy Star Rated and meets ALL THE ASTM and FM Global requirements. (Attachments A1 & A2)

<u>Response</u>: Spec Section 07 54 19, Article 2.2; ADD Paragraph C as follows: "C. Other Approved Manufacturers: Sike Sarnafil S327 60 mil system."

**ITEM NO. 37:** *Inquiry*: Verify Room 119 is part of base bid?

Response: Yes.

ITEM NO. 38: <u>Inquiry</u>: Drawing A1.9 – Addenda #2 drawing did not define Alternate #2 requirements. What is Alternate #2?

<u>Response</u>: Alternate #2 is for the new 237 Herman Miller seats in the existing Hold Room

**ITEM NO. 39:** <u>Inquiry</u>: Based on the amount of revised information, additional time for bid preparation is requested. Please push the bid date!

*Response*: The bid date will not change due to FAA grant deadline requirements.

### **REVISIONS TO PLANS (see corresponding reissued sheets in Attachment A):**

**ITEM NO. 40:** Sheet No. C1.0 Exiting Conditions and Demo Plan:

Updated the plan sheet to show removal of three (3) additional bollards.

**REVISE** Replace sheet in entirety with attached revised sheet.

**ITEM NO. 41:** Sheet No. C1.1 Site Development Plan:

Updated plan sheet to depict the proposed owner supplied bollards (3) versus the proposed Contractor supplied bollards (2).

**REVISE** Replace sheet in entirety with attached revised sheet.

**ITEM NO. 42:** Sheet No. C1.2 Grading and Drainage Plan:

Updated plan sheet to add note about proposed drainage crossing existing conduits.

**REVISE** Replace sheet in entirety with attached revised sheet.

**ITEM NO. 43:** Sheet No. C1.3 Utility Plan:

Updated plan sheet to depict electrical conduit/cable to proposed pedestrian gate with fence mounted electrical box.

**REVISE** Replace sheet in entirety with attached revised sheet.

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**ITEM NO. 44:** 

Sheet CV1.1 Exiting Conditions and Demo Plan:

Updated the plan sheet to show removal of three (3) additional bollards.

**REVISE** Replace sheet in entirety with attached revised sheet.

**ITEM NO. 45:** 

Sheet CV1.2 Final Conditions Plan:

Updated the plan sheet to show the river rock in the legend.

**REVISE** Replace sheet in entirety with attached revised sheet.

**ITEM NO. 46:** 

Sheet CV1.3 Site Plan:

Updated plan sheet to depict the proposed owner supplied bollards (3) versus the

proposed Contractor supplied bollards (2).

**REVISE** Replace sheet in entirety with attached revised sheet.

**ITEM NO. 47:** 

Sheet CV5.1 Site Details 1:

Updated plan sheet to remove the ground mounted electrical box/pedestal.

**REVISE** Replace sheet in entirety with attached revised sheet.

**ITEM NO. 48:** 

**Sheet** A1.9, Rev Date 06.19.2025:

**REVISE** Replace sheet in entirety with attached revised sheet.

**ITEM NO. 49:** 

**Sheet** A4.7, Rev Date 06.10.2025:

**REVISE** Additional details provided.

### **ATTACHMENTS:**

A. Contract Drawings (C1.0, C1.1, C1.2, C1.3, CV1.1, CV 1.2, CV 1.3, CV5.1, A1.9, and A4.7) (10 pages)

B. D3.1, A2.4, E1-1, E2-1, E3-1, E6-1, CV5.2 (8 pages)

C. CV1.0, CV1.1, CV1.2, CV1.3, CV1.4, CV1.5, CV5.1, CV5.2, D1.1, A1.0, A1.3, A4.9, S1.1, S1.2 (14 pages)

D. A9.1 (1 page)

E. A6.1, A6.3 (2 pages)

By Authority of:

Brandi J. Kentner, CPPO

Director of Purchasing






**EXISTING TERMINAL (EAST SIDE)** C1.0 SCALE: NTS




**ELECTRICAL RACK** C1.0 SCALE: NTS

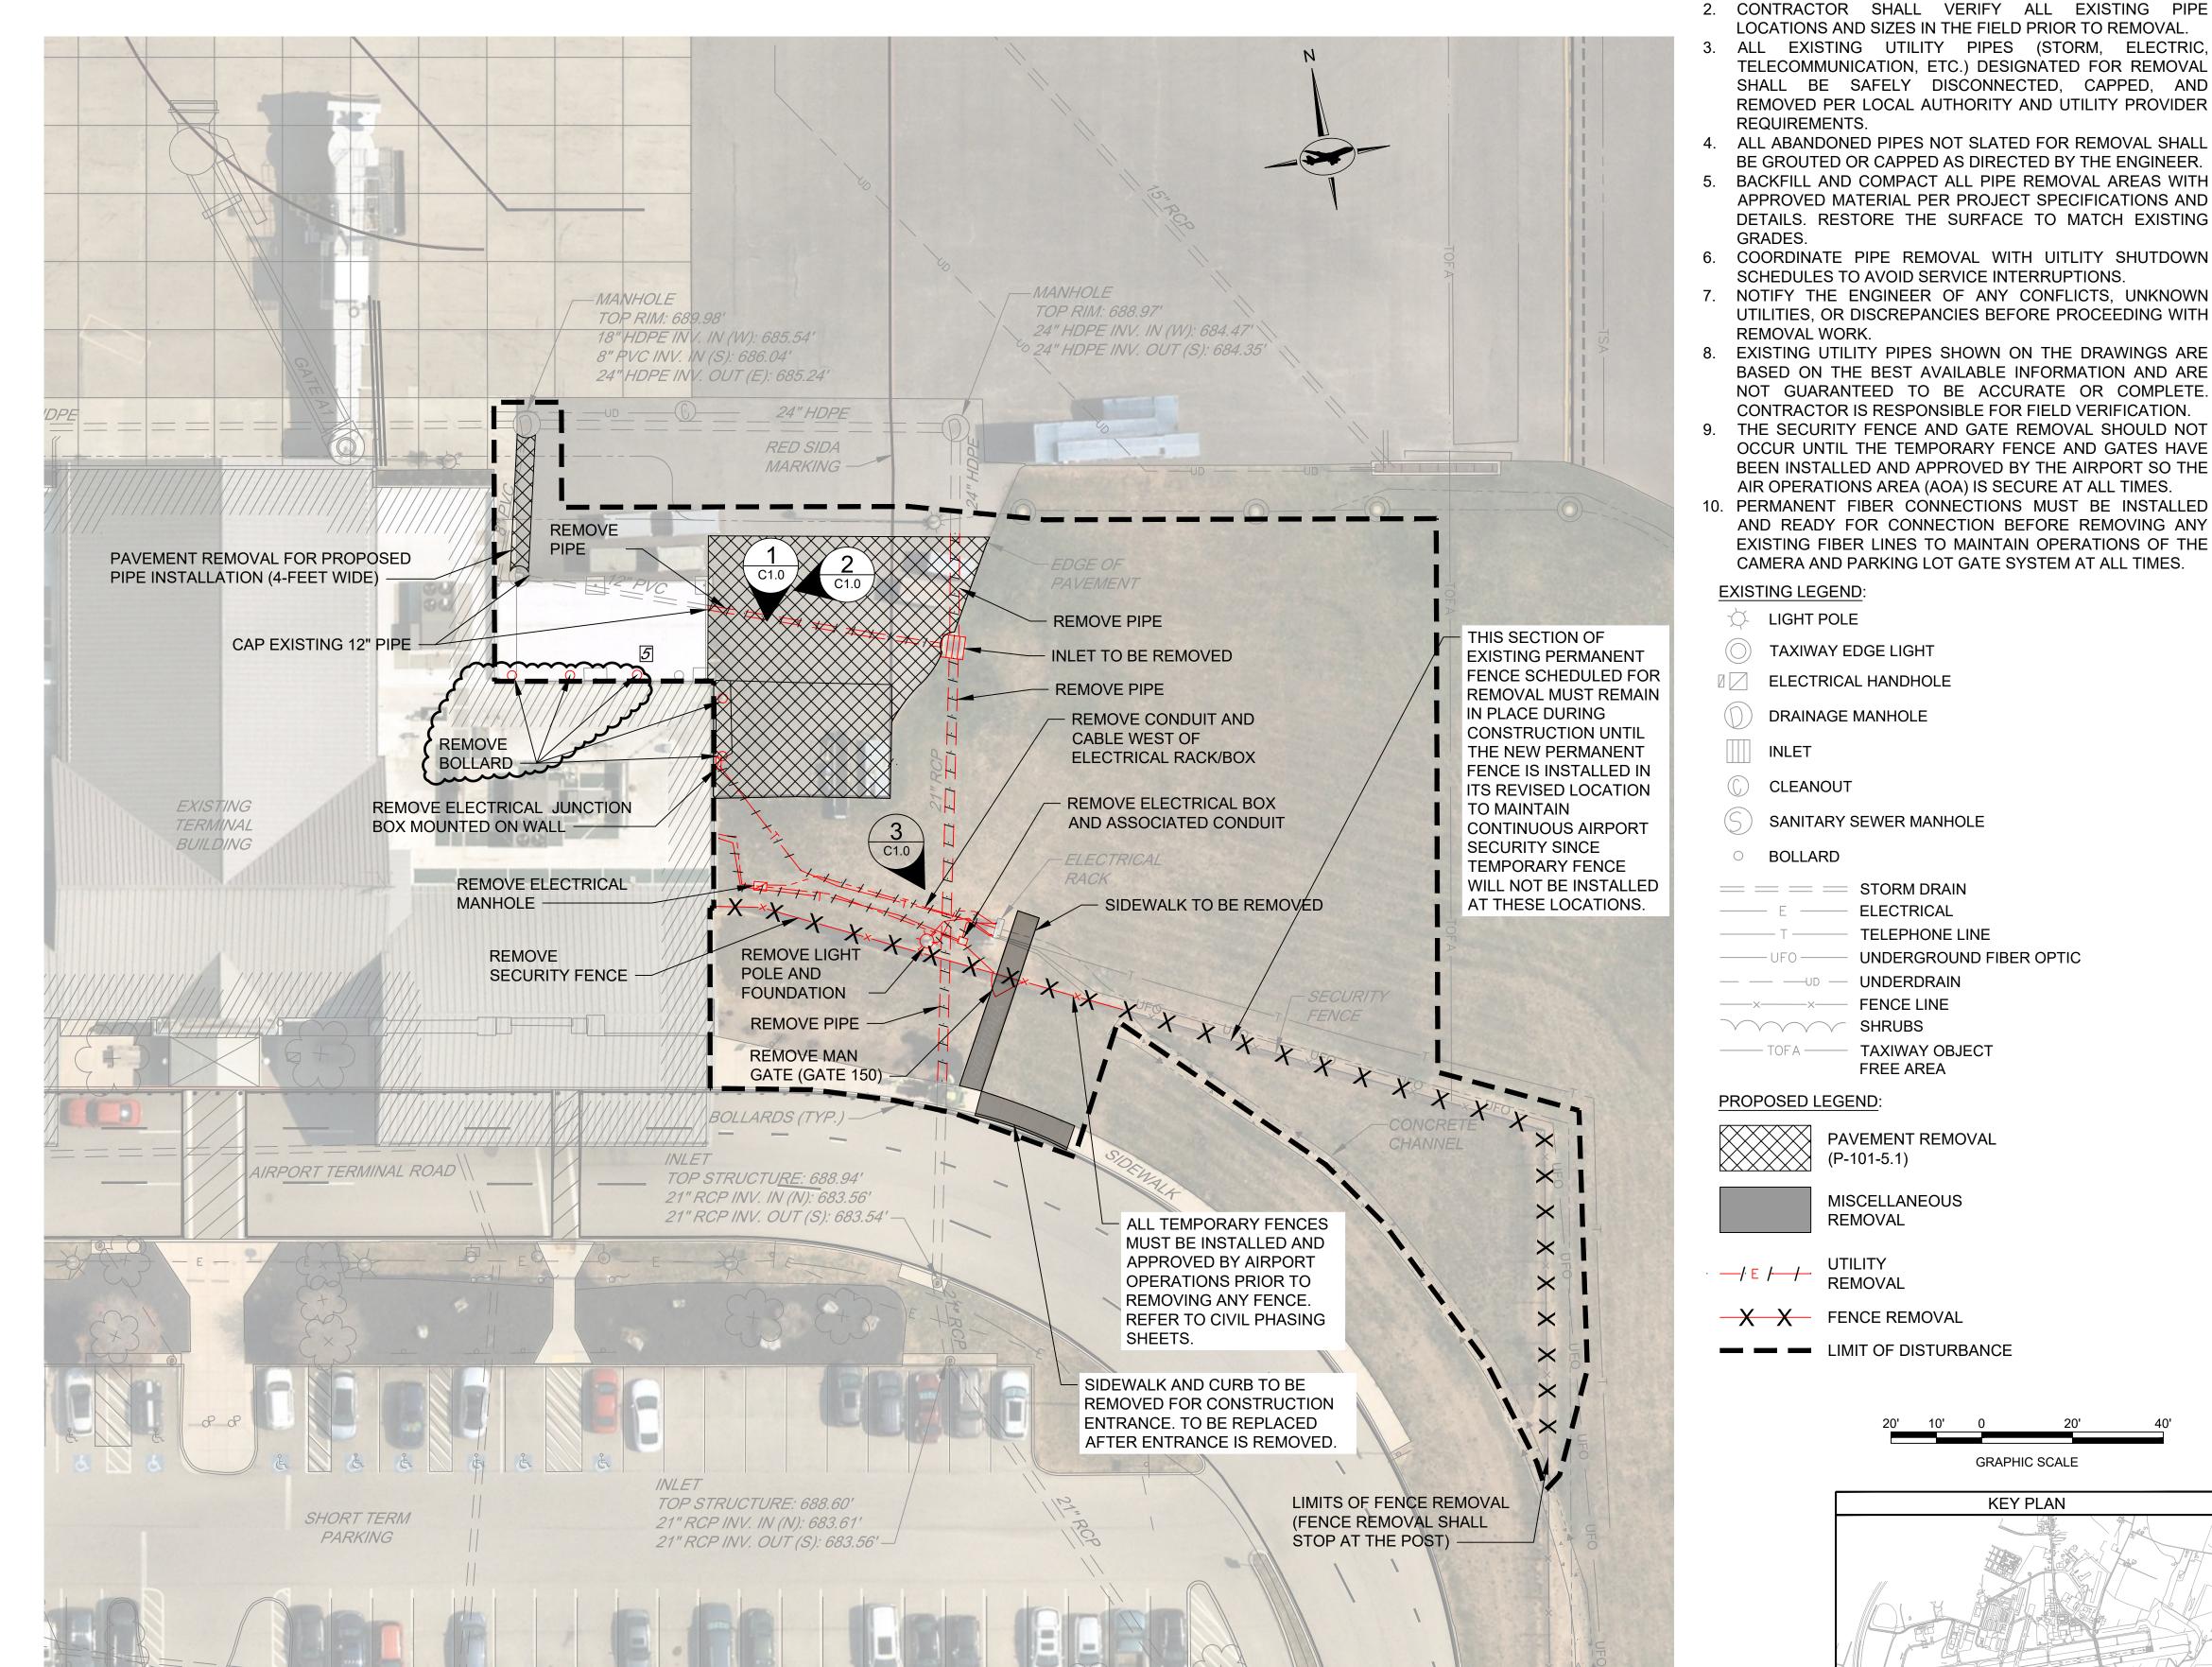








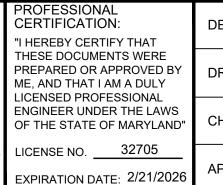

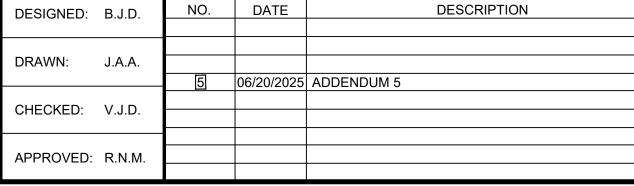



# **HAGERSTOWN REGIONAL AIRPORT**

Washington County, MD

T	ERMINAL	<b>BUILDING</b>	<b>EXPANSION</b>

N.A.

PROJECT TITLE

SCALE:

SHEET TITLE: **EXISTING CONDITIONS AND DEMOLITION PLAN** 

MAY 2025

NOTES:

1. REFER TO CIVIL PHASING SERIES FOR PHASING AND

LOCATIONS AND SIZES IN THE FIELD PRIOR TO REMOVAL.

TELECOMMUNICATION, ETC.) DESIGNATED FOR REMOVAL SHALL BE SAFELY DISCONNECTED, CAPPED, AND REMOVED PER LOCAL AUTHORITY AND UTILITY PROVIDER

BE GROUTED OR CAPPED AS DIRECTED BY THE ENGINEER.

APPROVED MATERIAL PER PROJECT SPECIFICATIONS AND DETAILS. RESTORE THE SURFACE TO MATCH EXISTING

UTILITIES, OR DISCREPANCIES BEFORE PROCEEDING WITH

BASED ON THE BEST AVAILABLE INFORMATION AND ARE

NOT GUARANTEED TO BE ACCURATE OR COMPLETE CONTRACTOR IS RESPONSIBLE FOR FIELD VERIFICATION.

OCCUR UNTIL THE TEMPORARY FENCE AND GATES HAVE

BEEN INSTALLED AND APPROVED BY THE AIRPORT SO THE AIR OPERATIONS AREA (AOA) IS SECURE AT ALL TIMES.

AND READY FOR CONNECTION BEFORE REMOVING ANY

EXISTING FIBER LINES TO MAINTAIN OPERATIONS OF THE

CAMERA AND PARKING LOT GATE SYSTEM AT ALL TIMES.

SCHEDULES TO AVOID SERVICE INTERRUPTIONS.

GENERAL PROJECT LAYOUT PLANS.

REQUIREMENTS.

REMOVAL WORK.

LIGHT POLE

BOLLARD

TAXIWAY EDGE LIGHT

DRAINAGE MANHOLE

SANITARY SEWER MANHOLE

TELEPHONE LINE

FREE AREA

**MISCELLANEOUS** 

LIMIT OF DISTURBANCE

REMOVAL

REMOVAL

UTILITY

GRADES.

Bid No.: PUR-1751 MAA Grant No.: MAA-GR-XX-XXX SUBMISSION: **BID SET** 

**GRAPHIC SCALE** 


**KEY PLAN** 

SHEET No.: C1.0 10 OF 102

**PROJECT** 

FAA ATP No.:3-24-0019-XX-2025


LOCATION

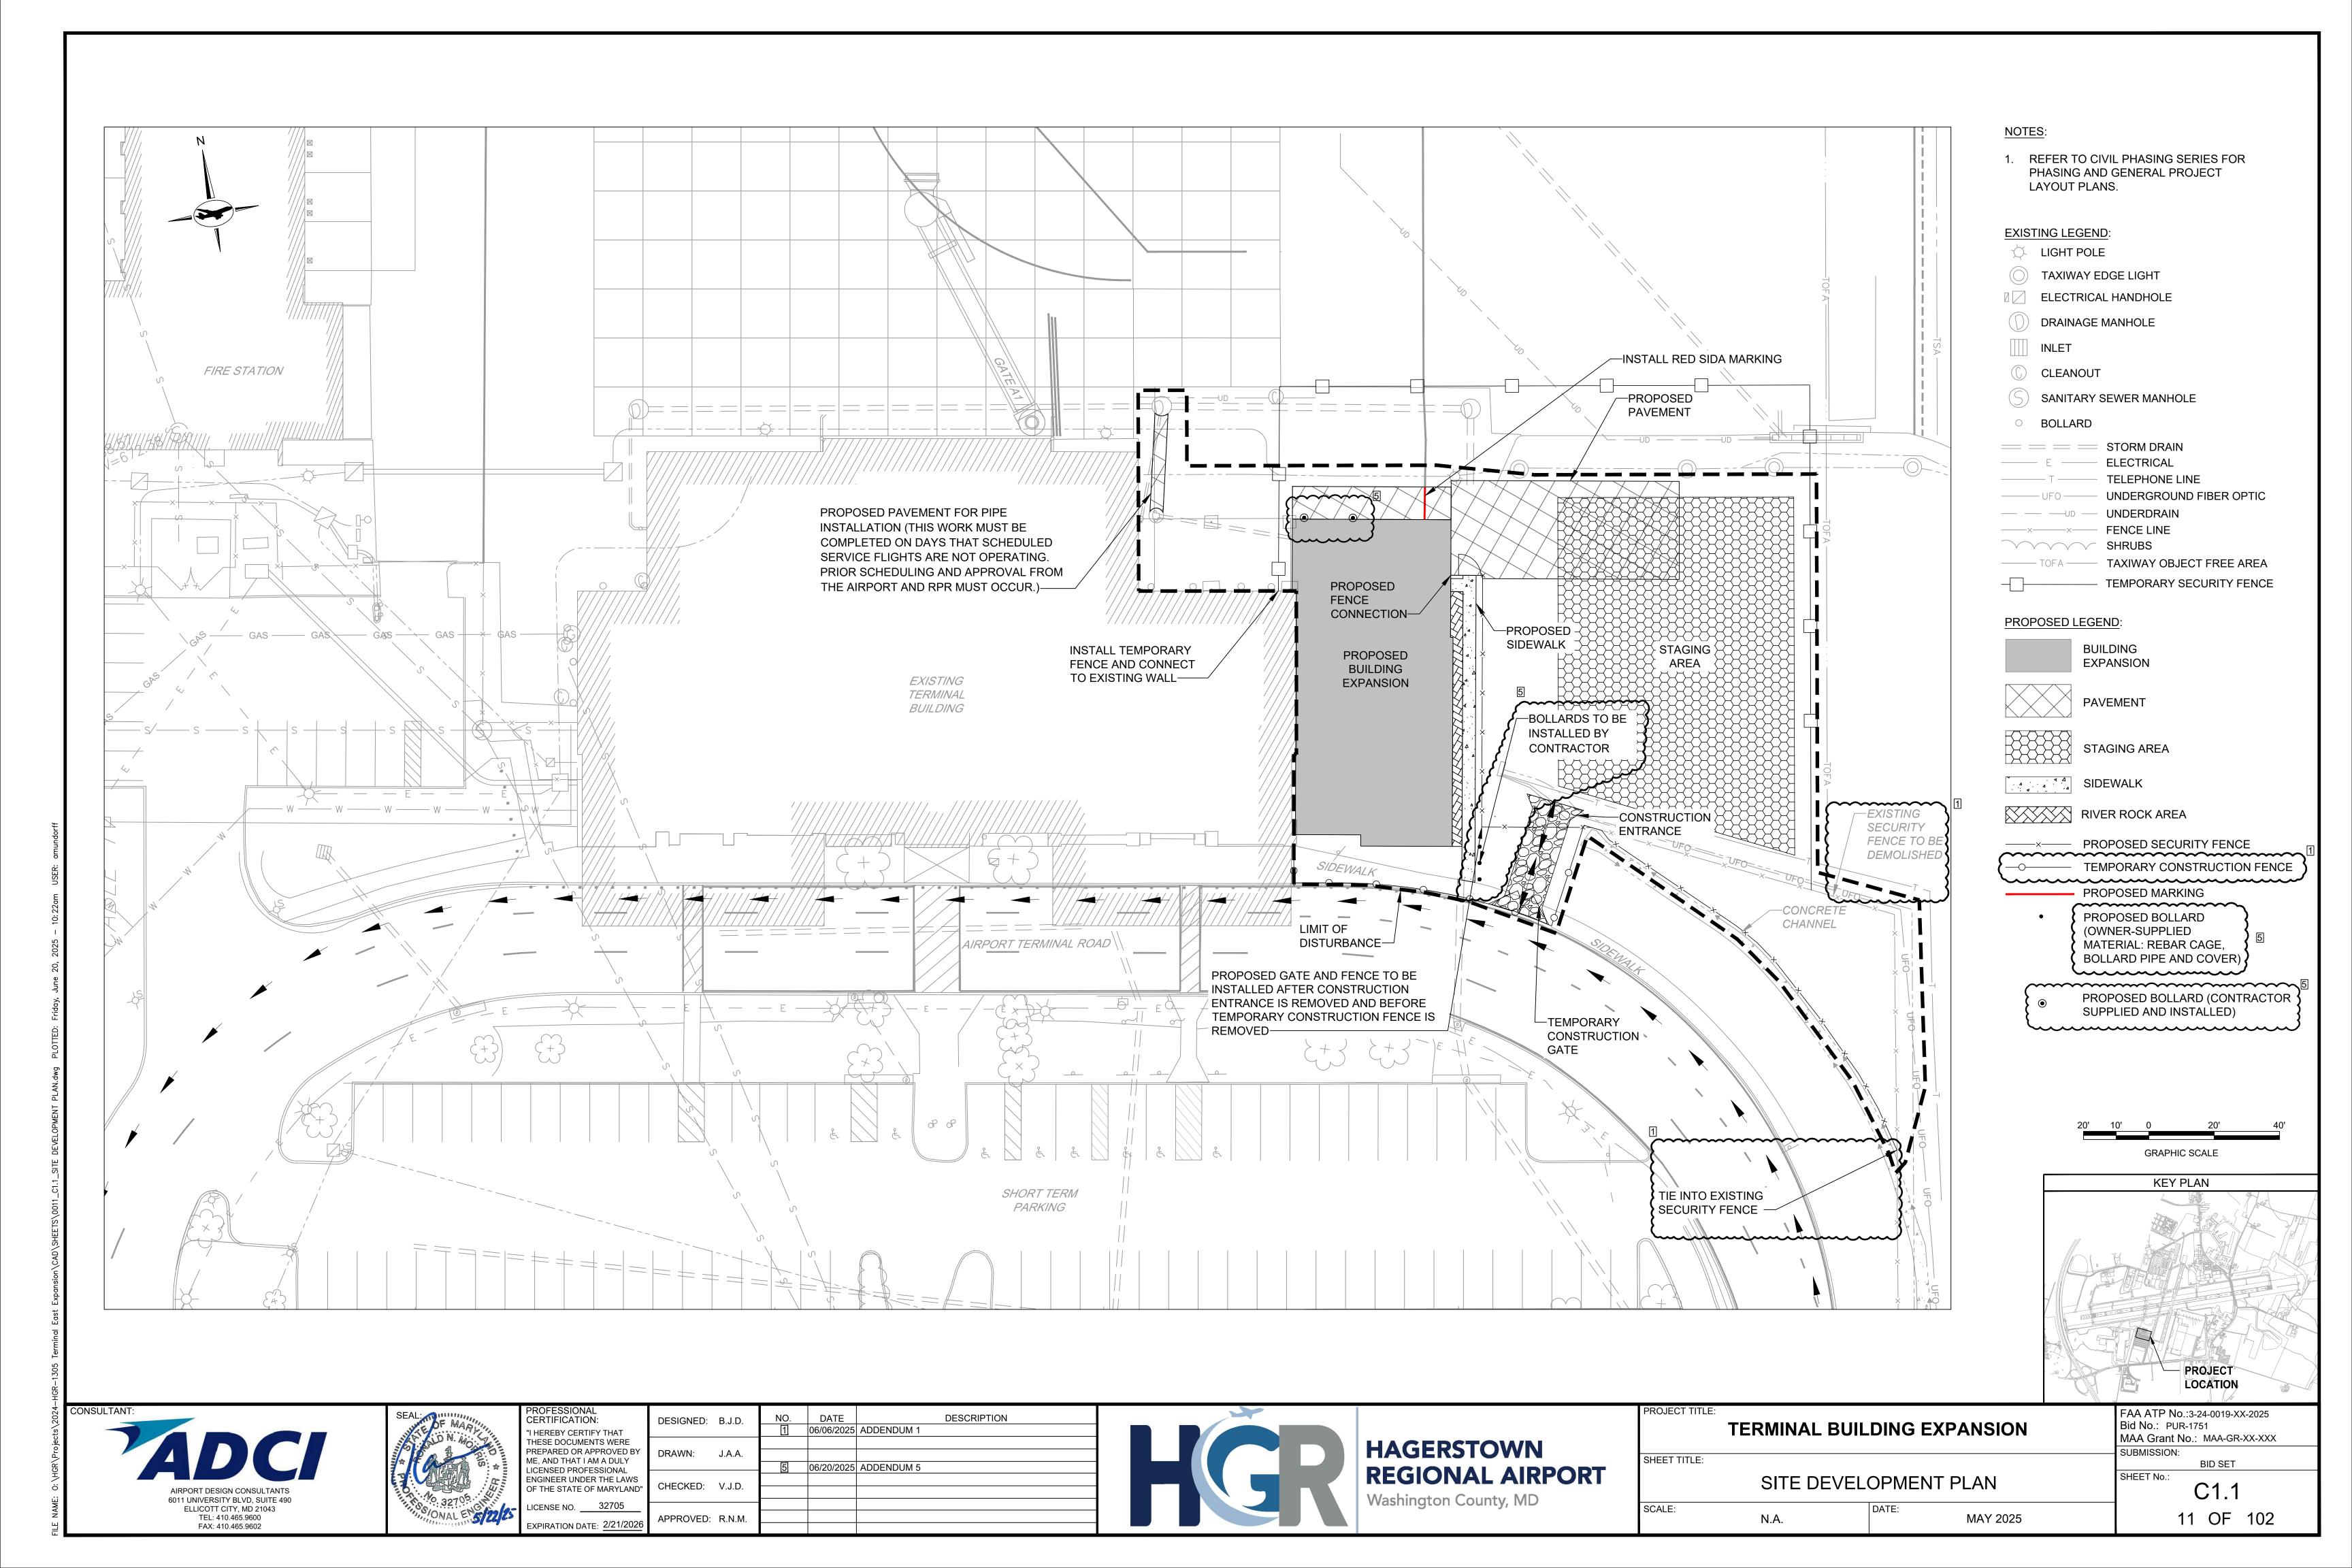

# NOTES:

REFER TO CIVIL PHASING SERIES FOR PHASING AND GENERAL PROJECT LAYOUT PLANS.

CONTRACTOR SHALL LOCATE AND EXPOSE ALL EXISTING UNDERGROUND CONDUIT IN THE VICINITY OF CONDUIT SHALL BE FULLY SUPPORTED AND PROTECTED FROM SETTLEMENT, DAMAGE, OR DEFLECTION DURING EXCAVATION, INSTALLATION, AND BACKFILLING OPERATIONS. PROVIDE TEMPORARY CONDUIT SUPPORT AS REQUIRED. RESTORE ALL DISTURBED UTILITIES TO ORIGINAL CONDITION. COORDINATE WITH OWNER AND ENGINEER PRIOR TO CROSSING ANY EXISTING CONDUITS.

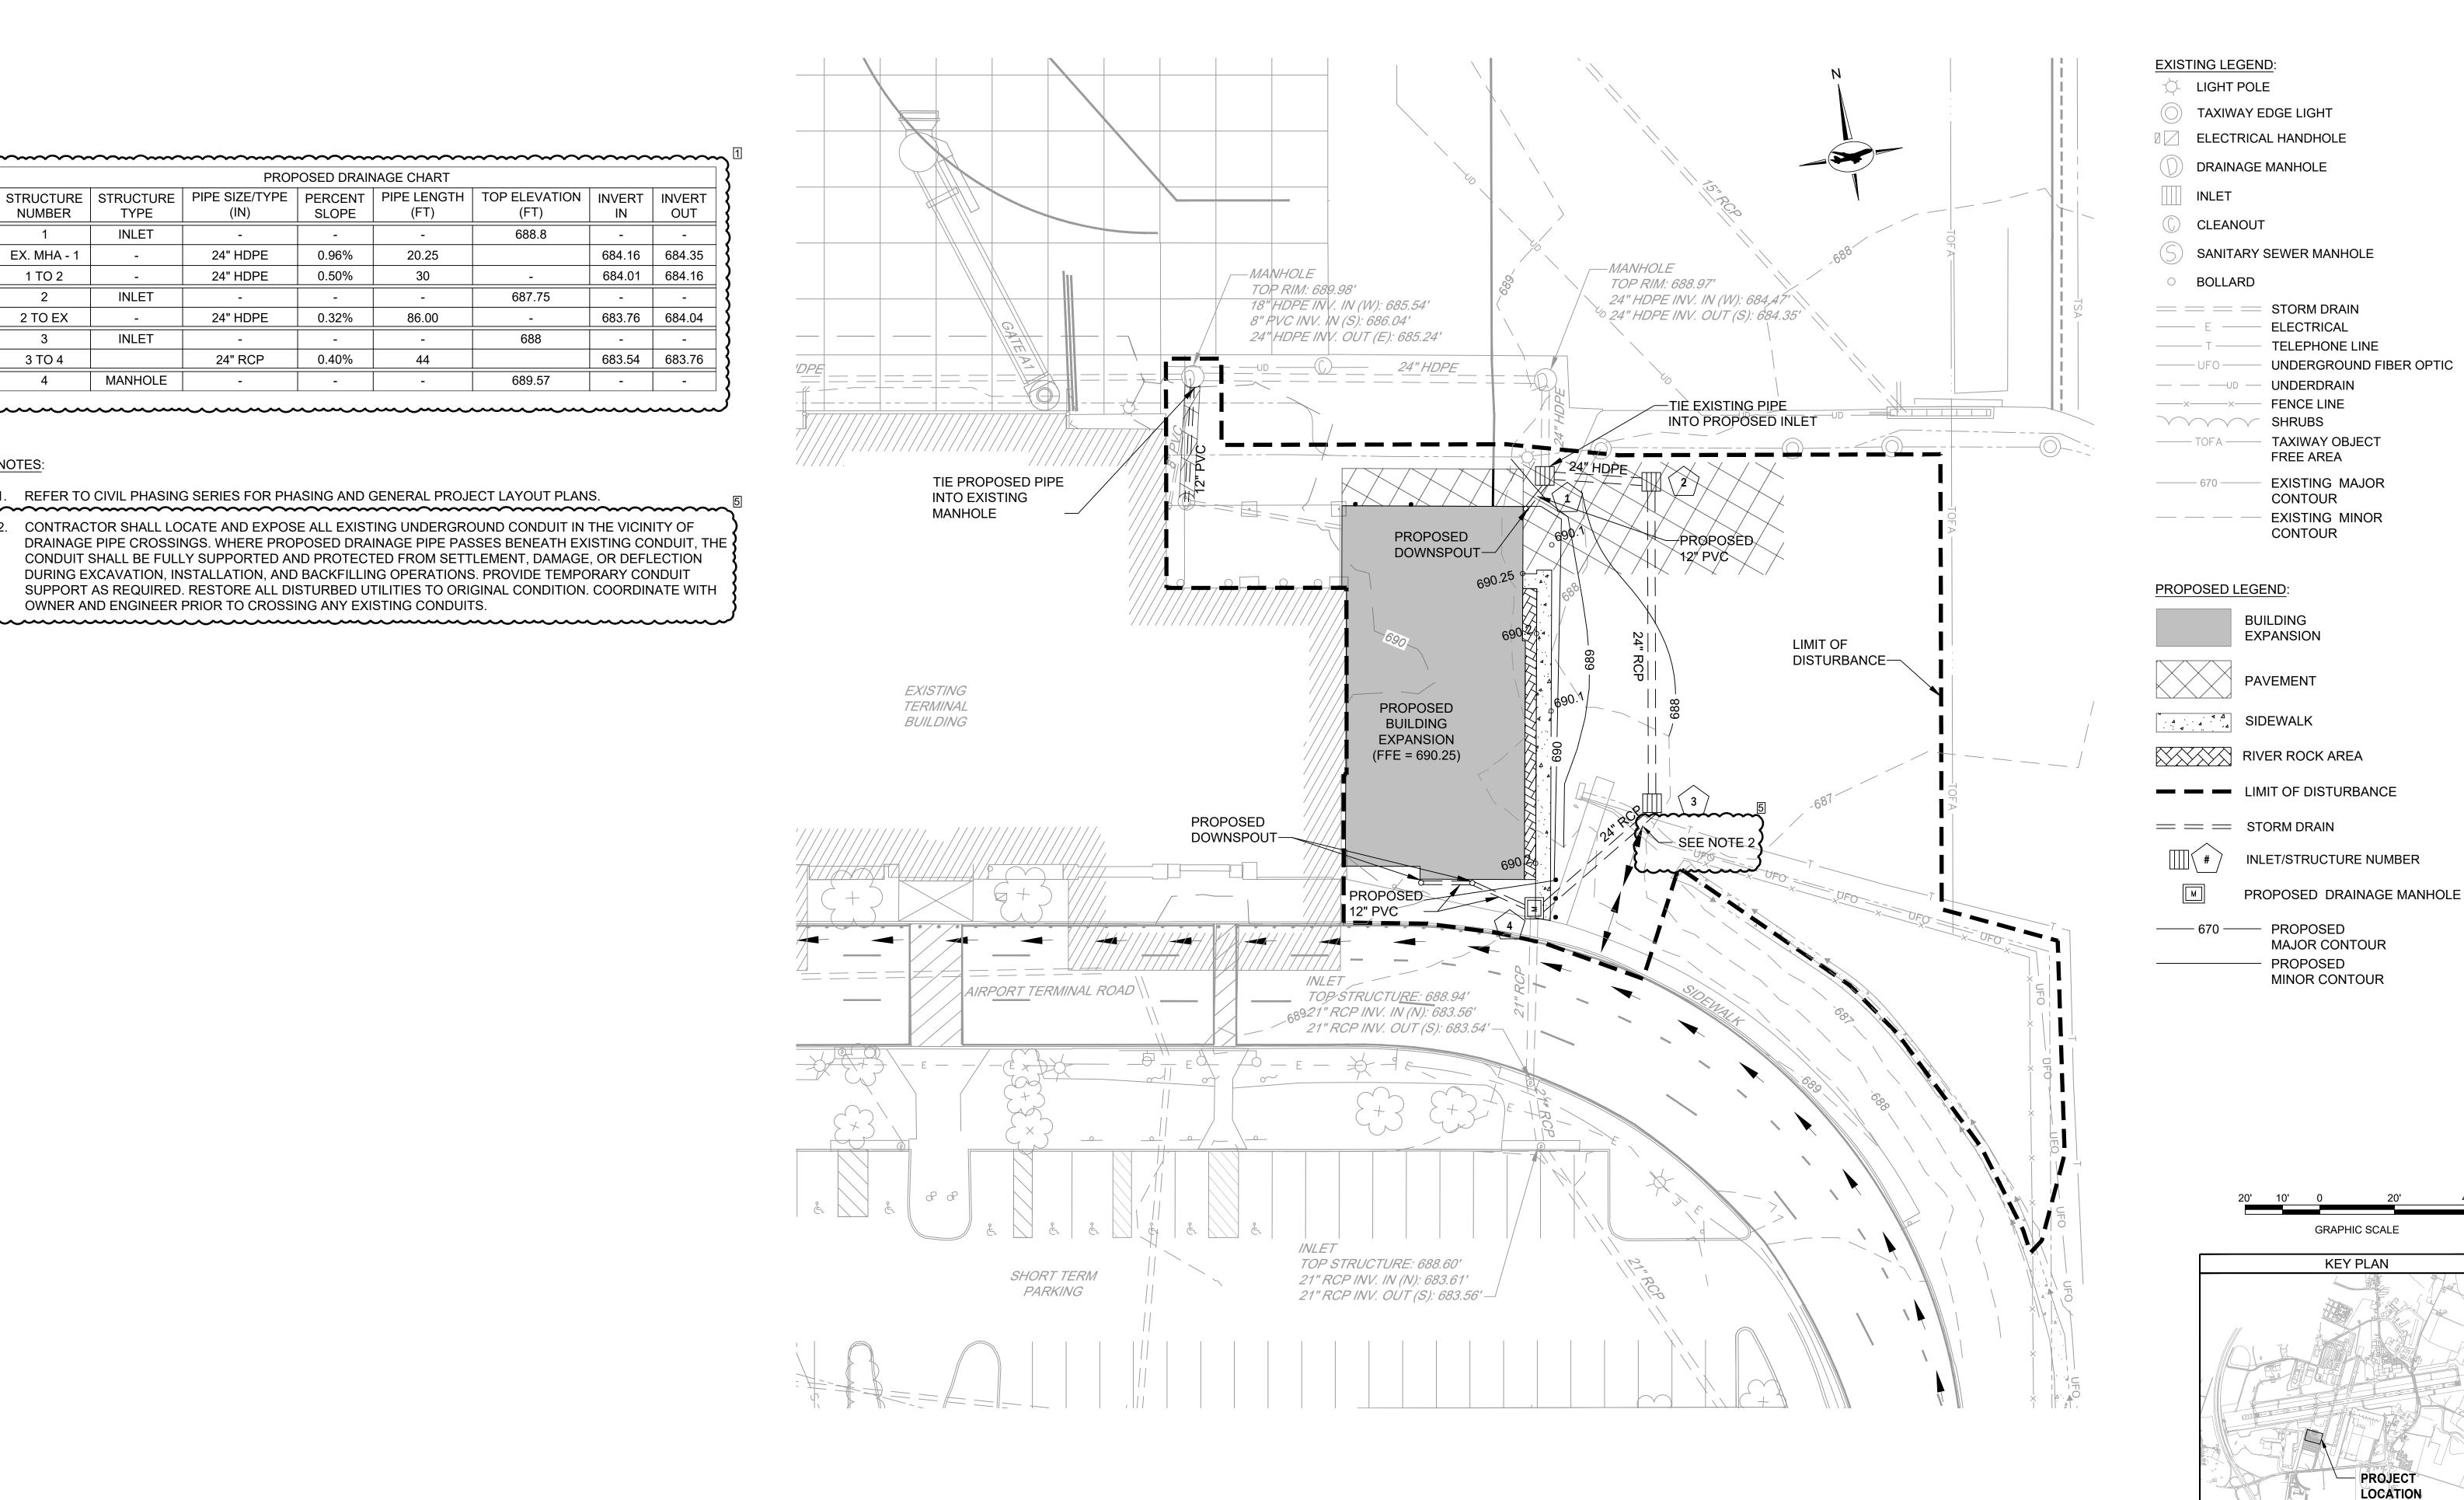

AIRPORT DESIGN CONSULTANTS 6011 UNIVERSITY BLVD, SUITE 490 ELLICOTT CITY, MD 21043 TEL: 410.465.9600 FAX: 410.465.9602



PROFESSIONAL CERTIFICATION: EXPIRATION DATE: 2/21/2026

I HEREBY CERTIFY THAT THESE DOCUMENTS WERE PREPARED OR APPROVED BY ME, AND THAT I AM A DULY ICENSED PROFESSIONAL ENGINEER UNDER THE LAWS OF THE STATE OF MARYLAND" LICENSE NO. \_\_\_\_\_32705

DESIGNED: B.J.D. 06/06/2025 ADDENDUM 1 DRAWN: J.A.A. 06/20/2025 ADDENDUM 5 CHECKED: V.J.D. APPROVED: R.N.M.

DESCRIPTION





**HAGERSTOWN REGIONAL AIRPORT** Washington County, MD

PROJECT TITLE:	TERMINAL BUILDING EXPANSION				
SHEET TITLE:					
	GRADING AND	DRAINAGE PLAN			
SCALE:	N.A.	DATE: MAY 2025			

FAA ATP No.:3-24-0019-XX-2025 Bid No.: PUR-1751 MAA Grant No.: MAA-GR-XX-XXX SUBMISSION: **BID SET** 

SHEET No.: C1.2 12 OF 102

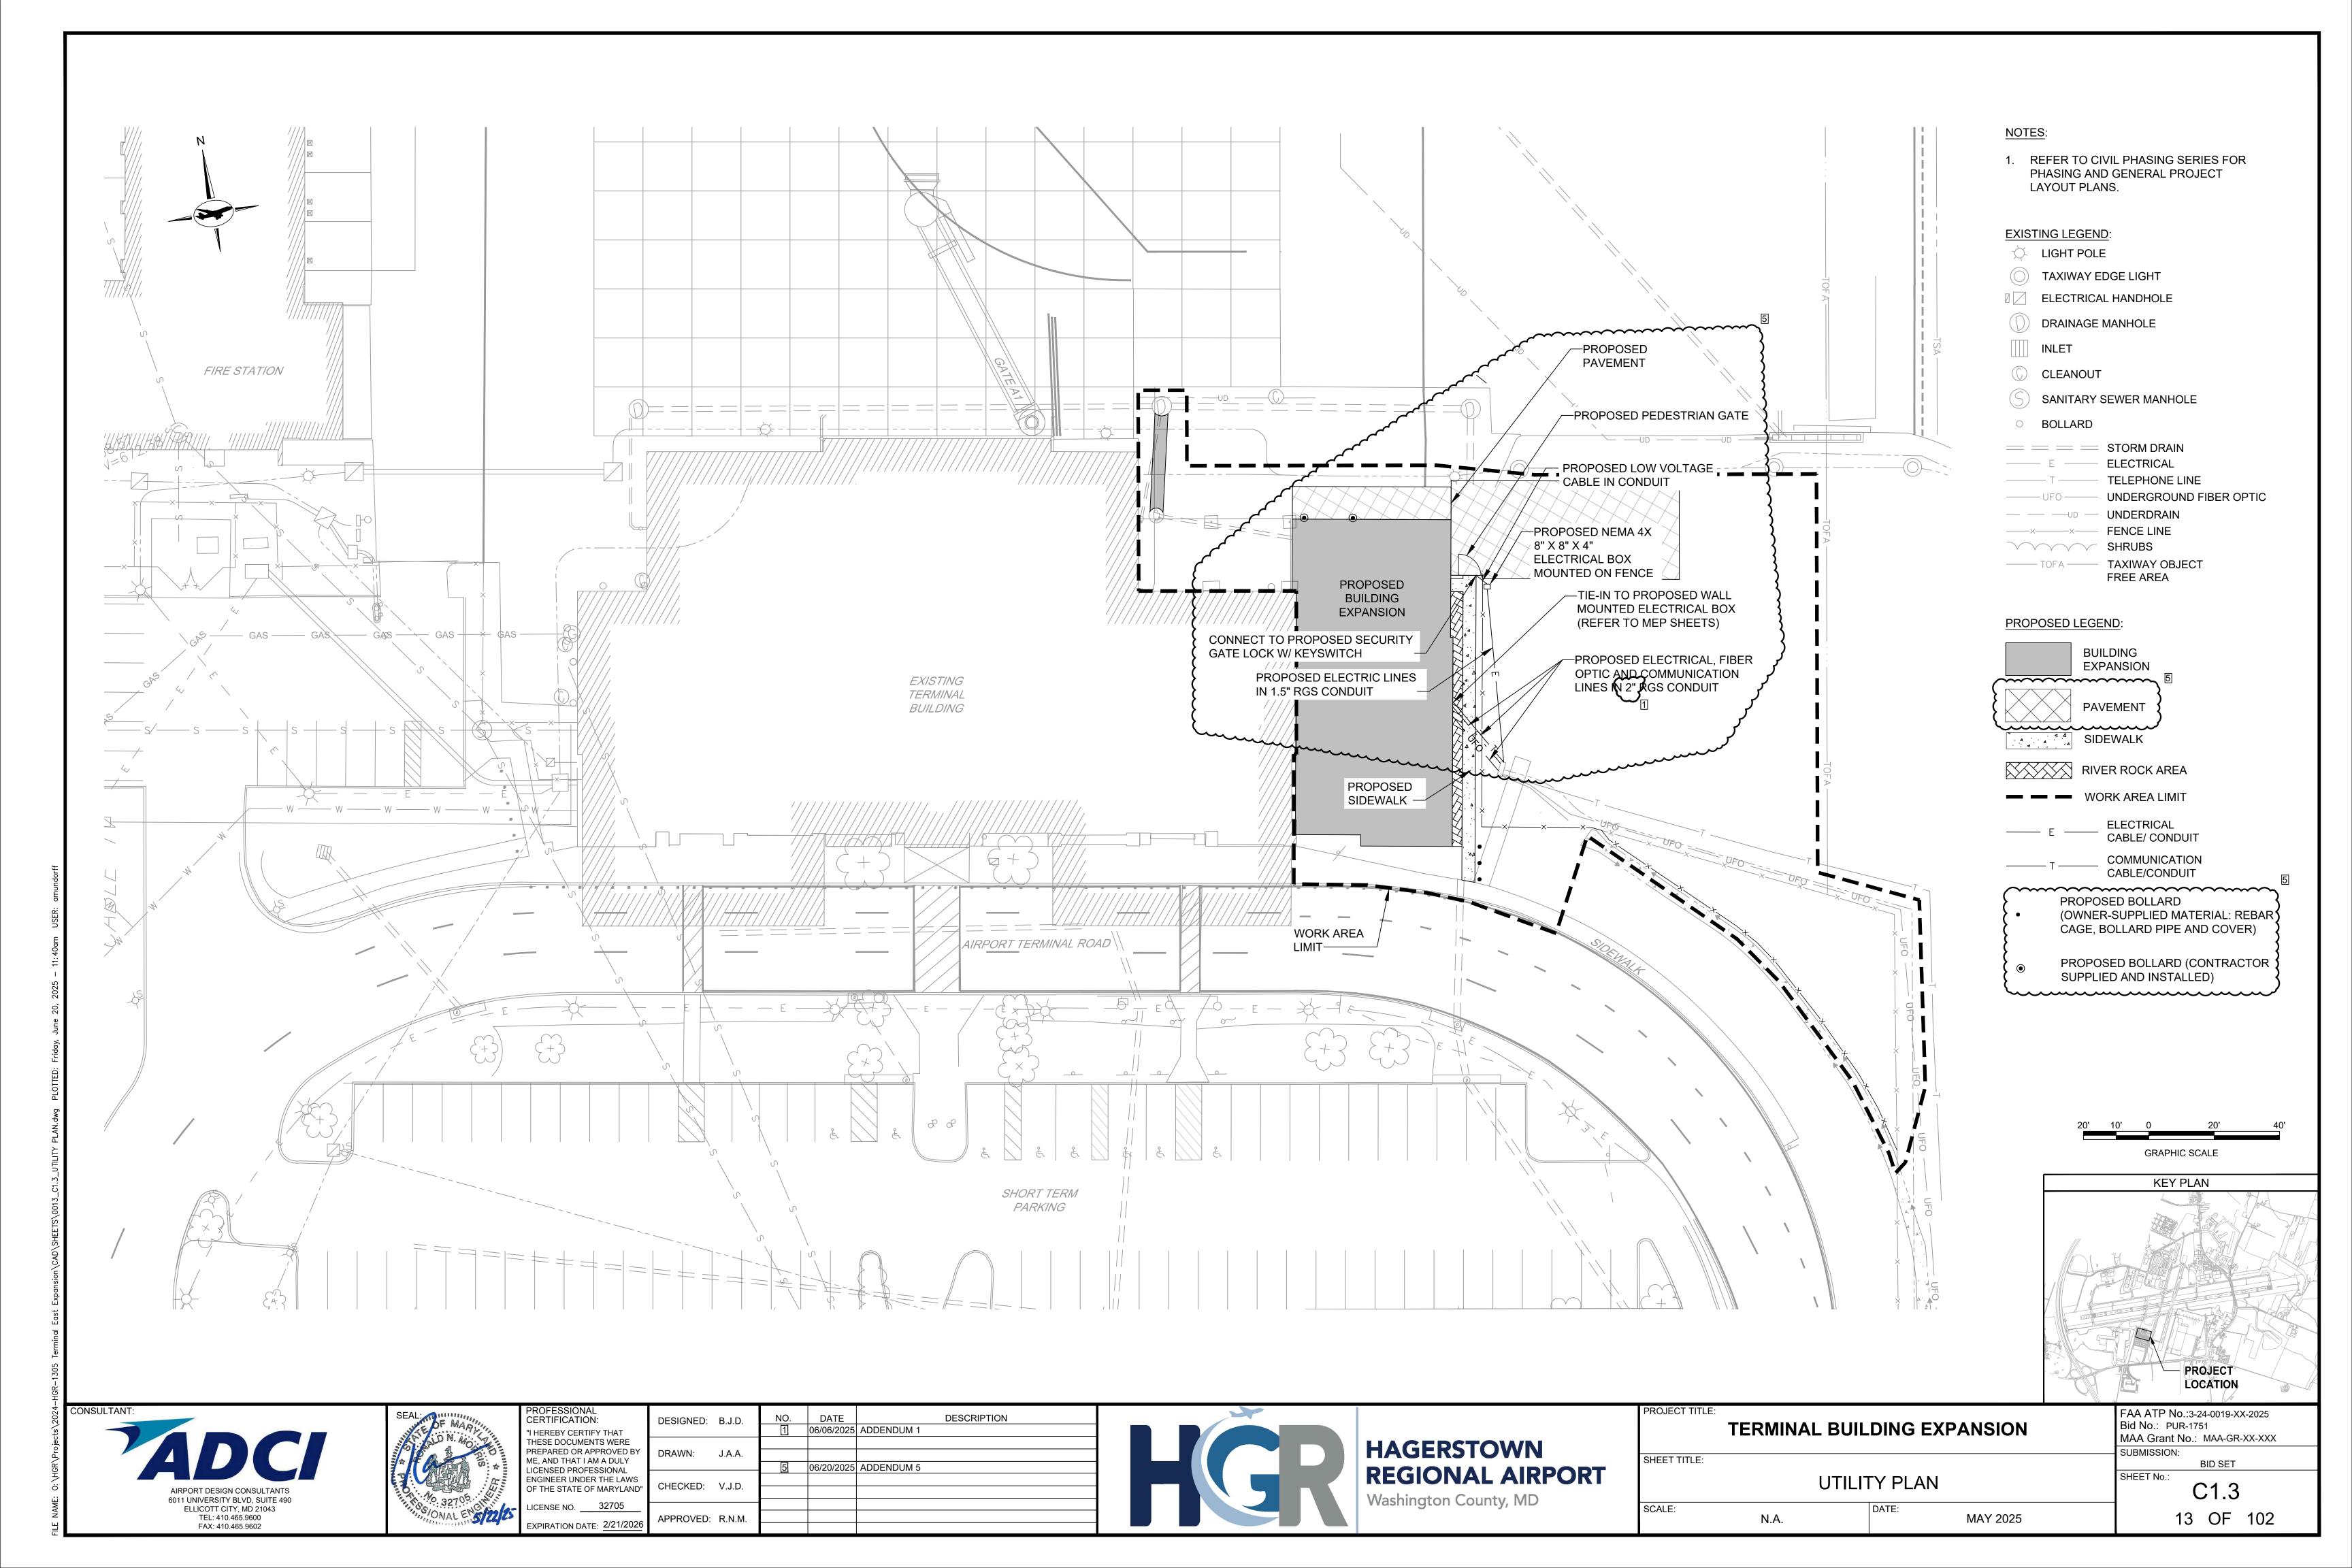

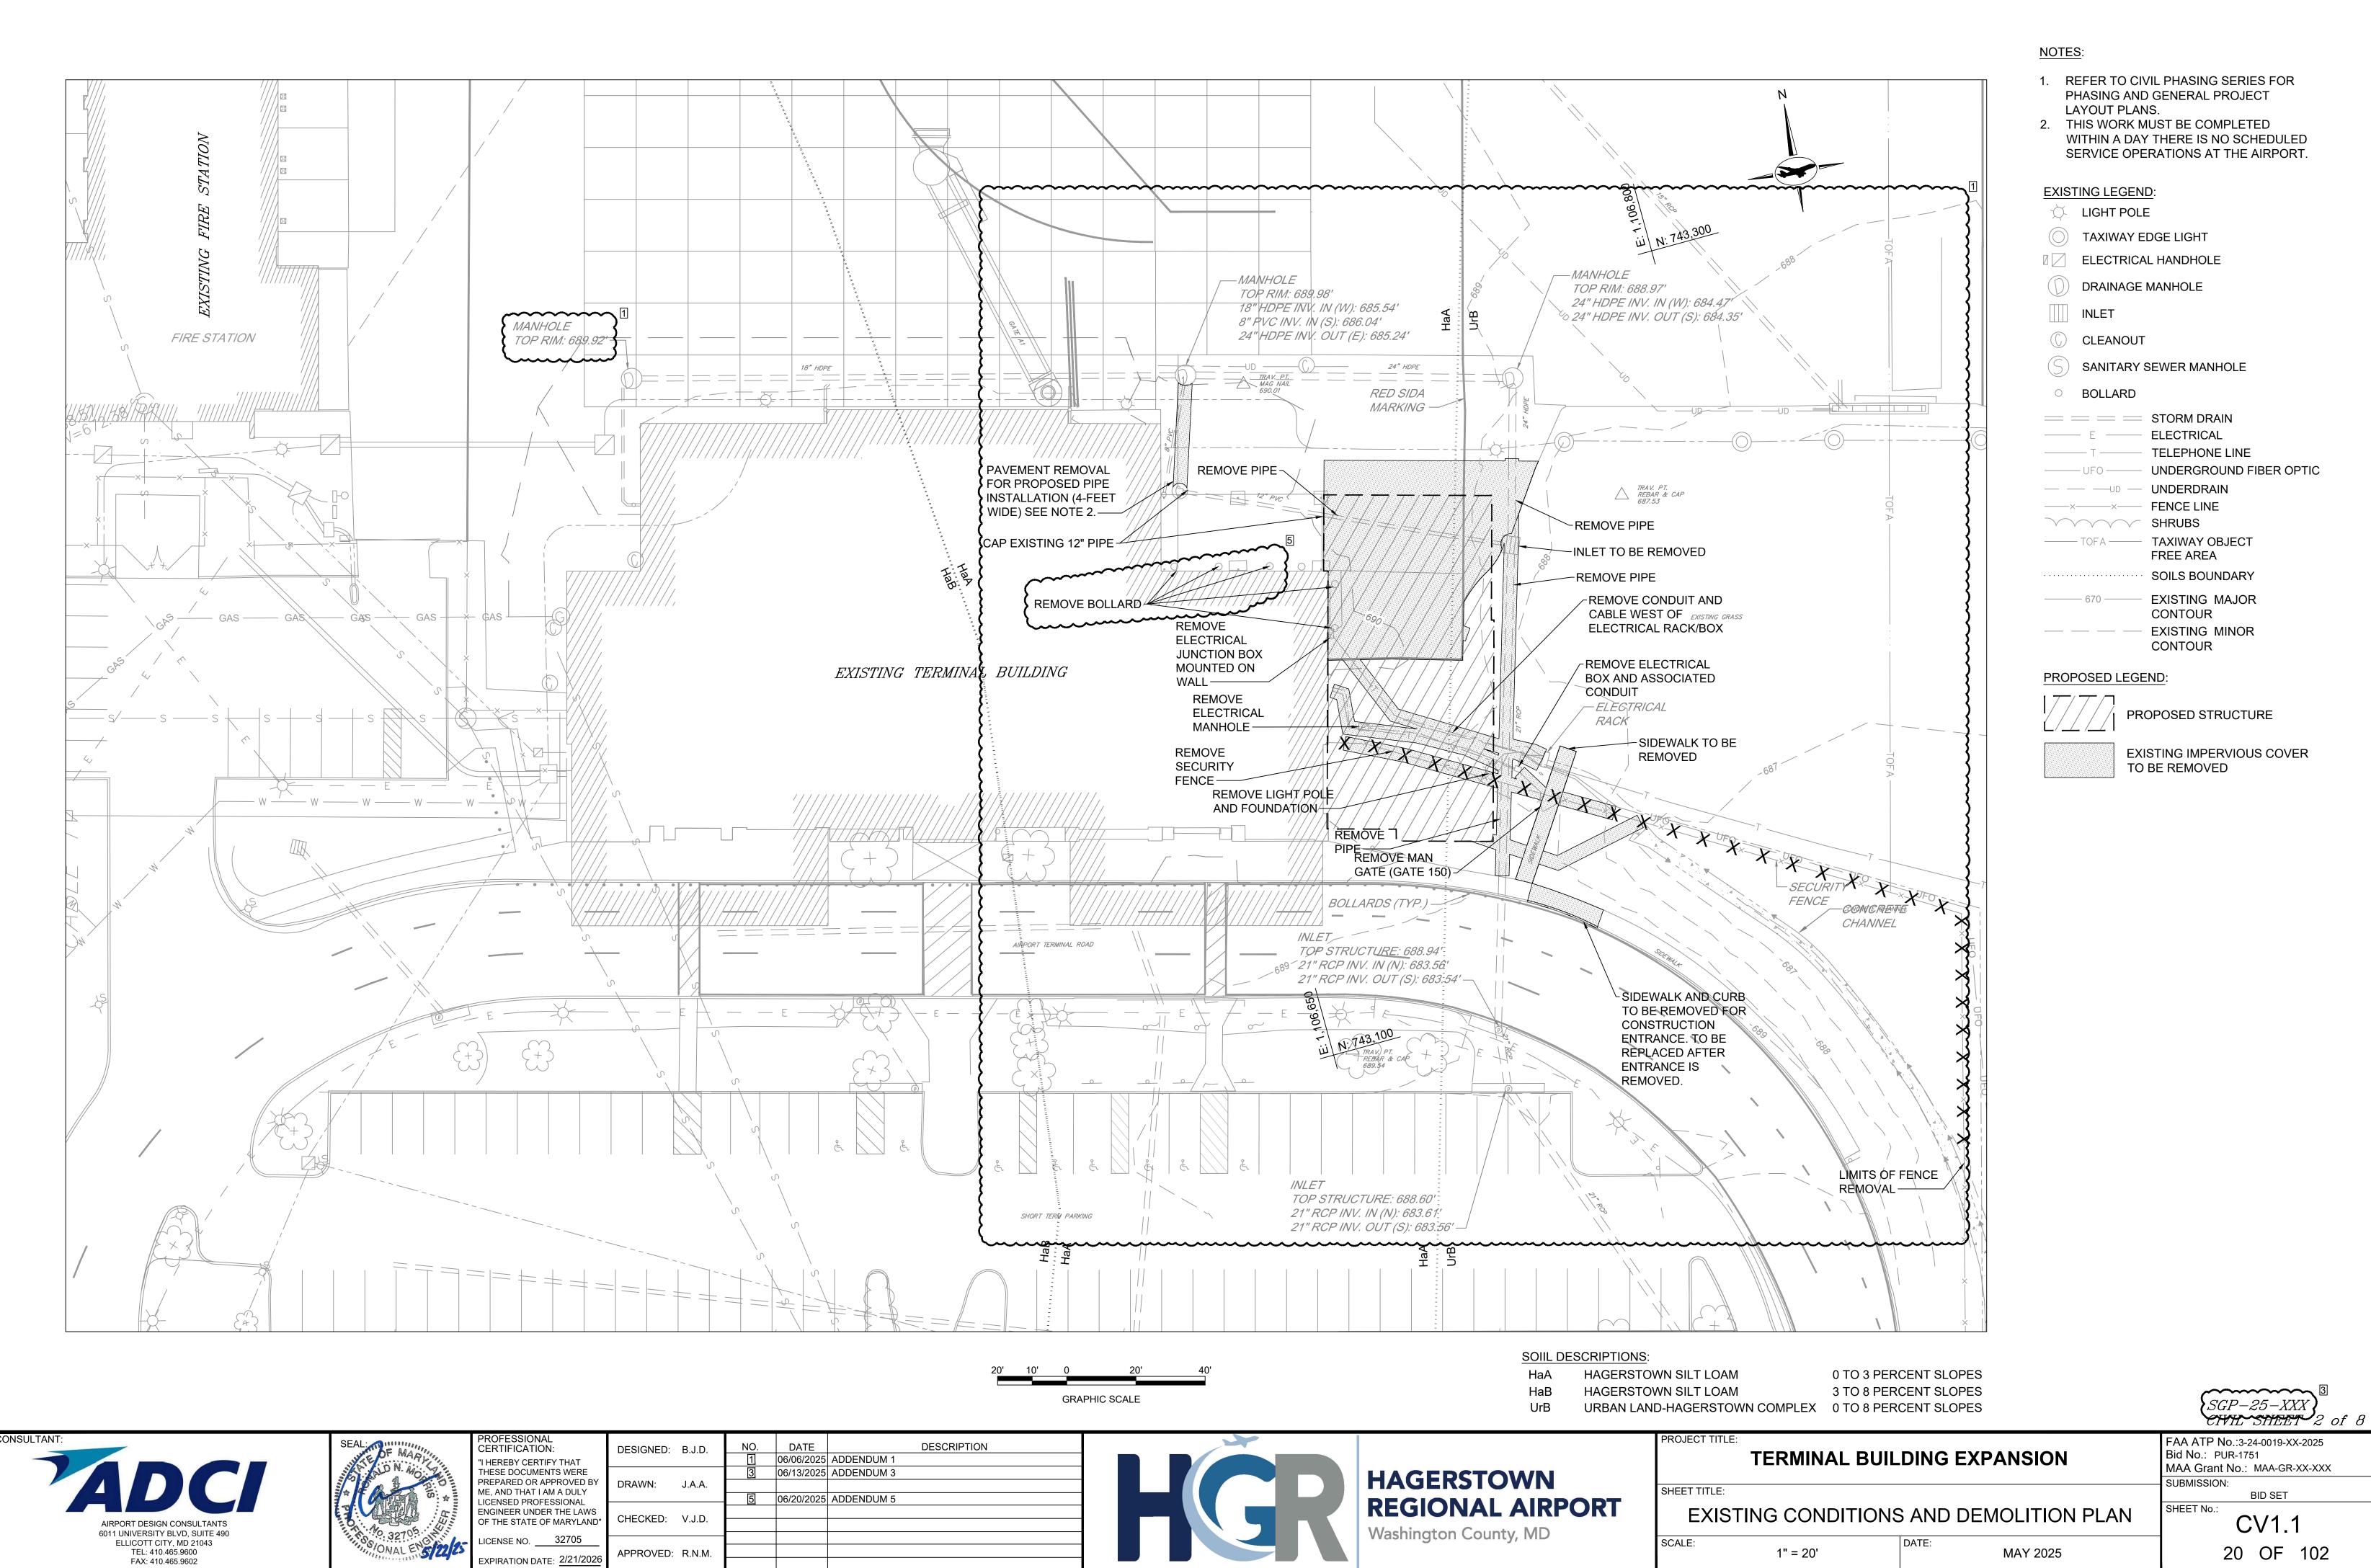



APPROVED: R.N.M.


EXPIRATION DATE: 2/21/202

MAY 2025

1" = 20'

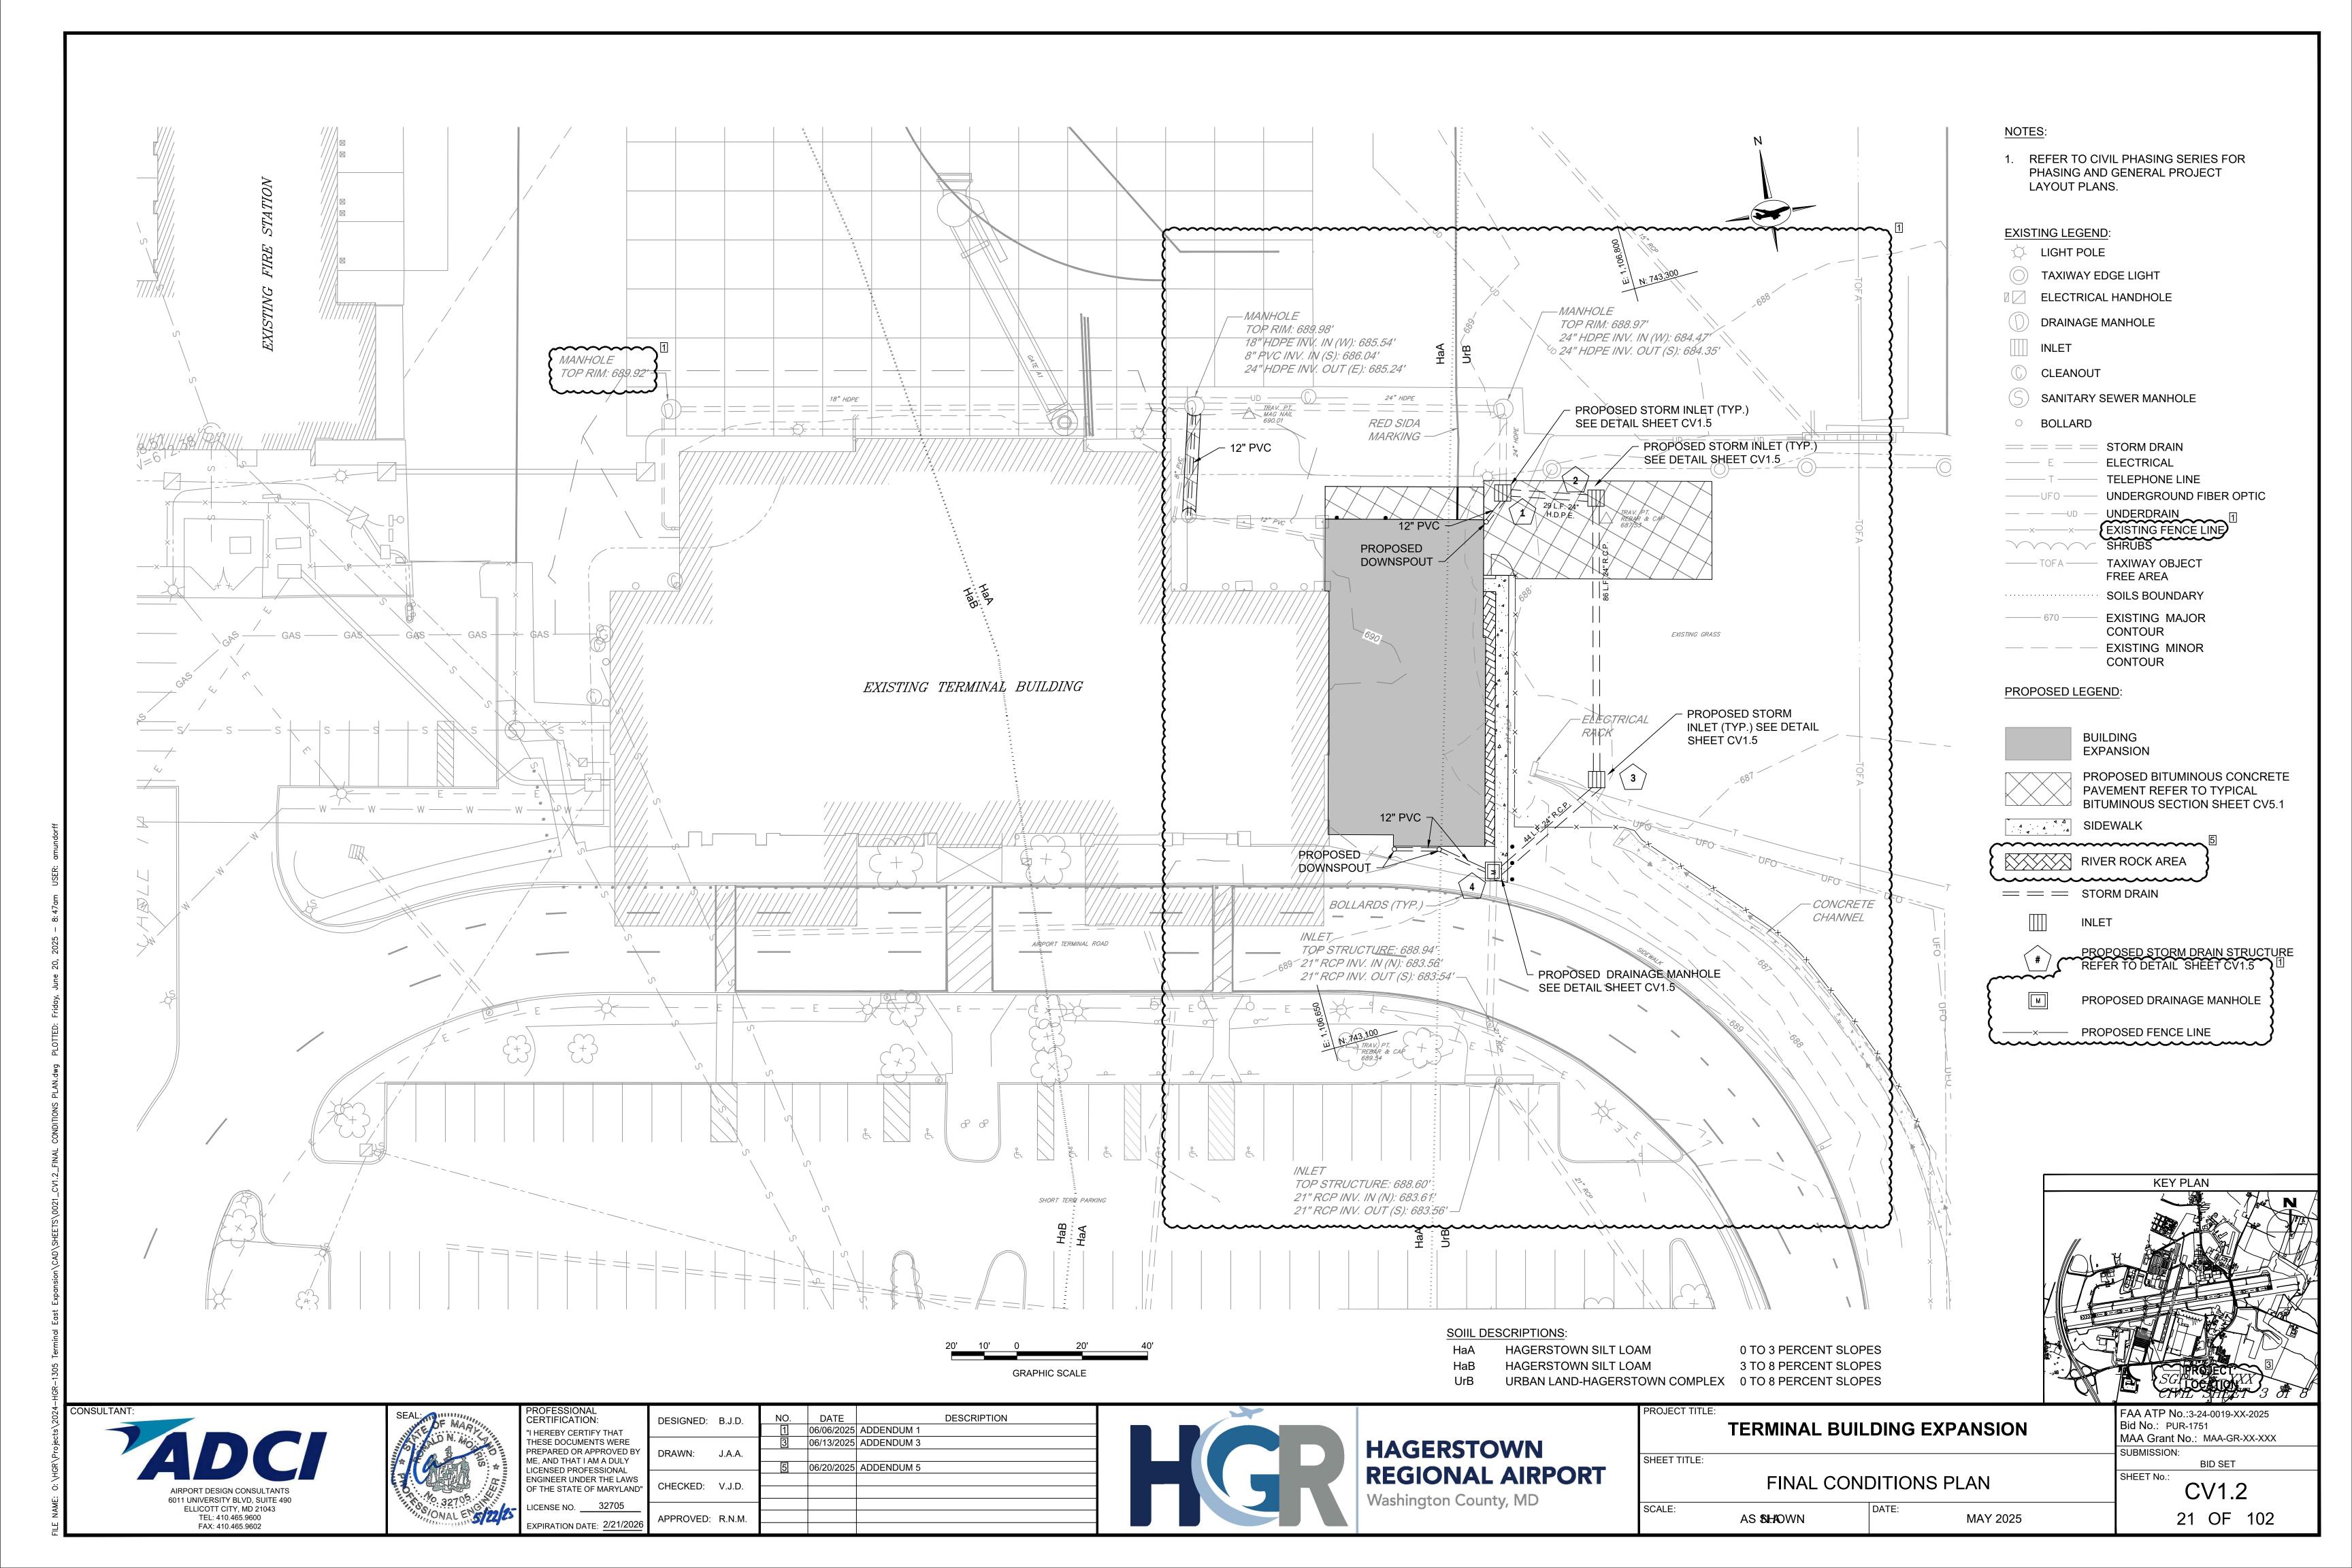

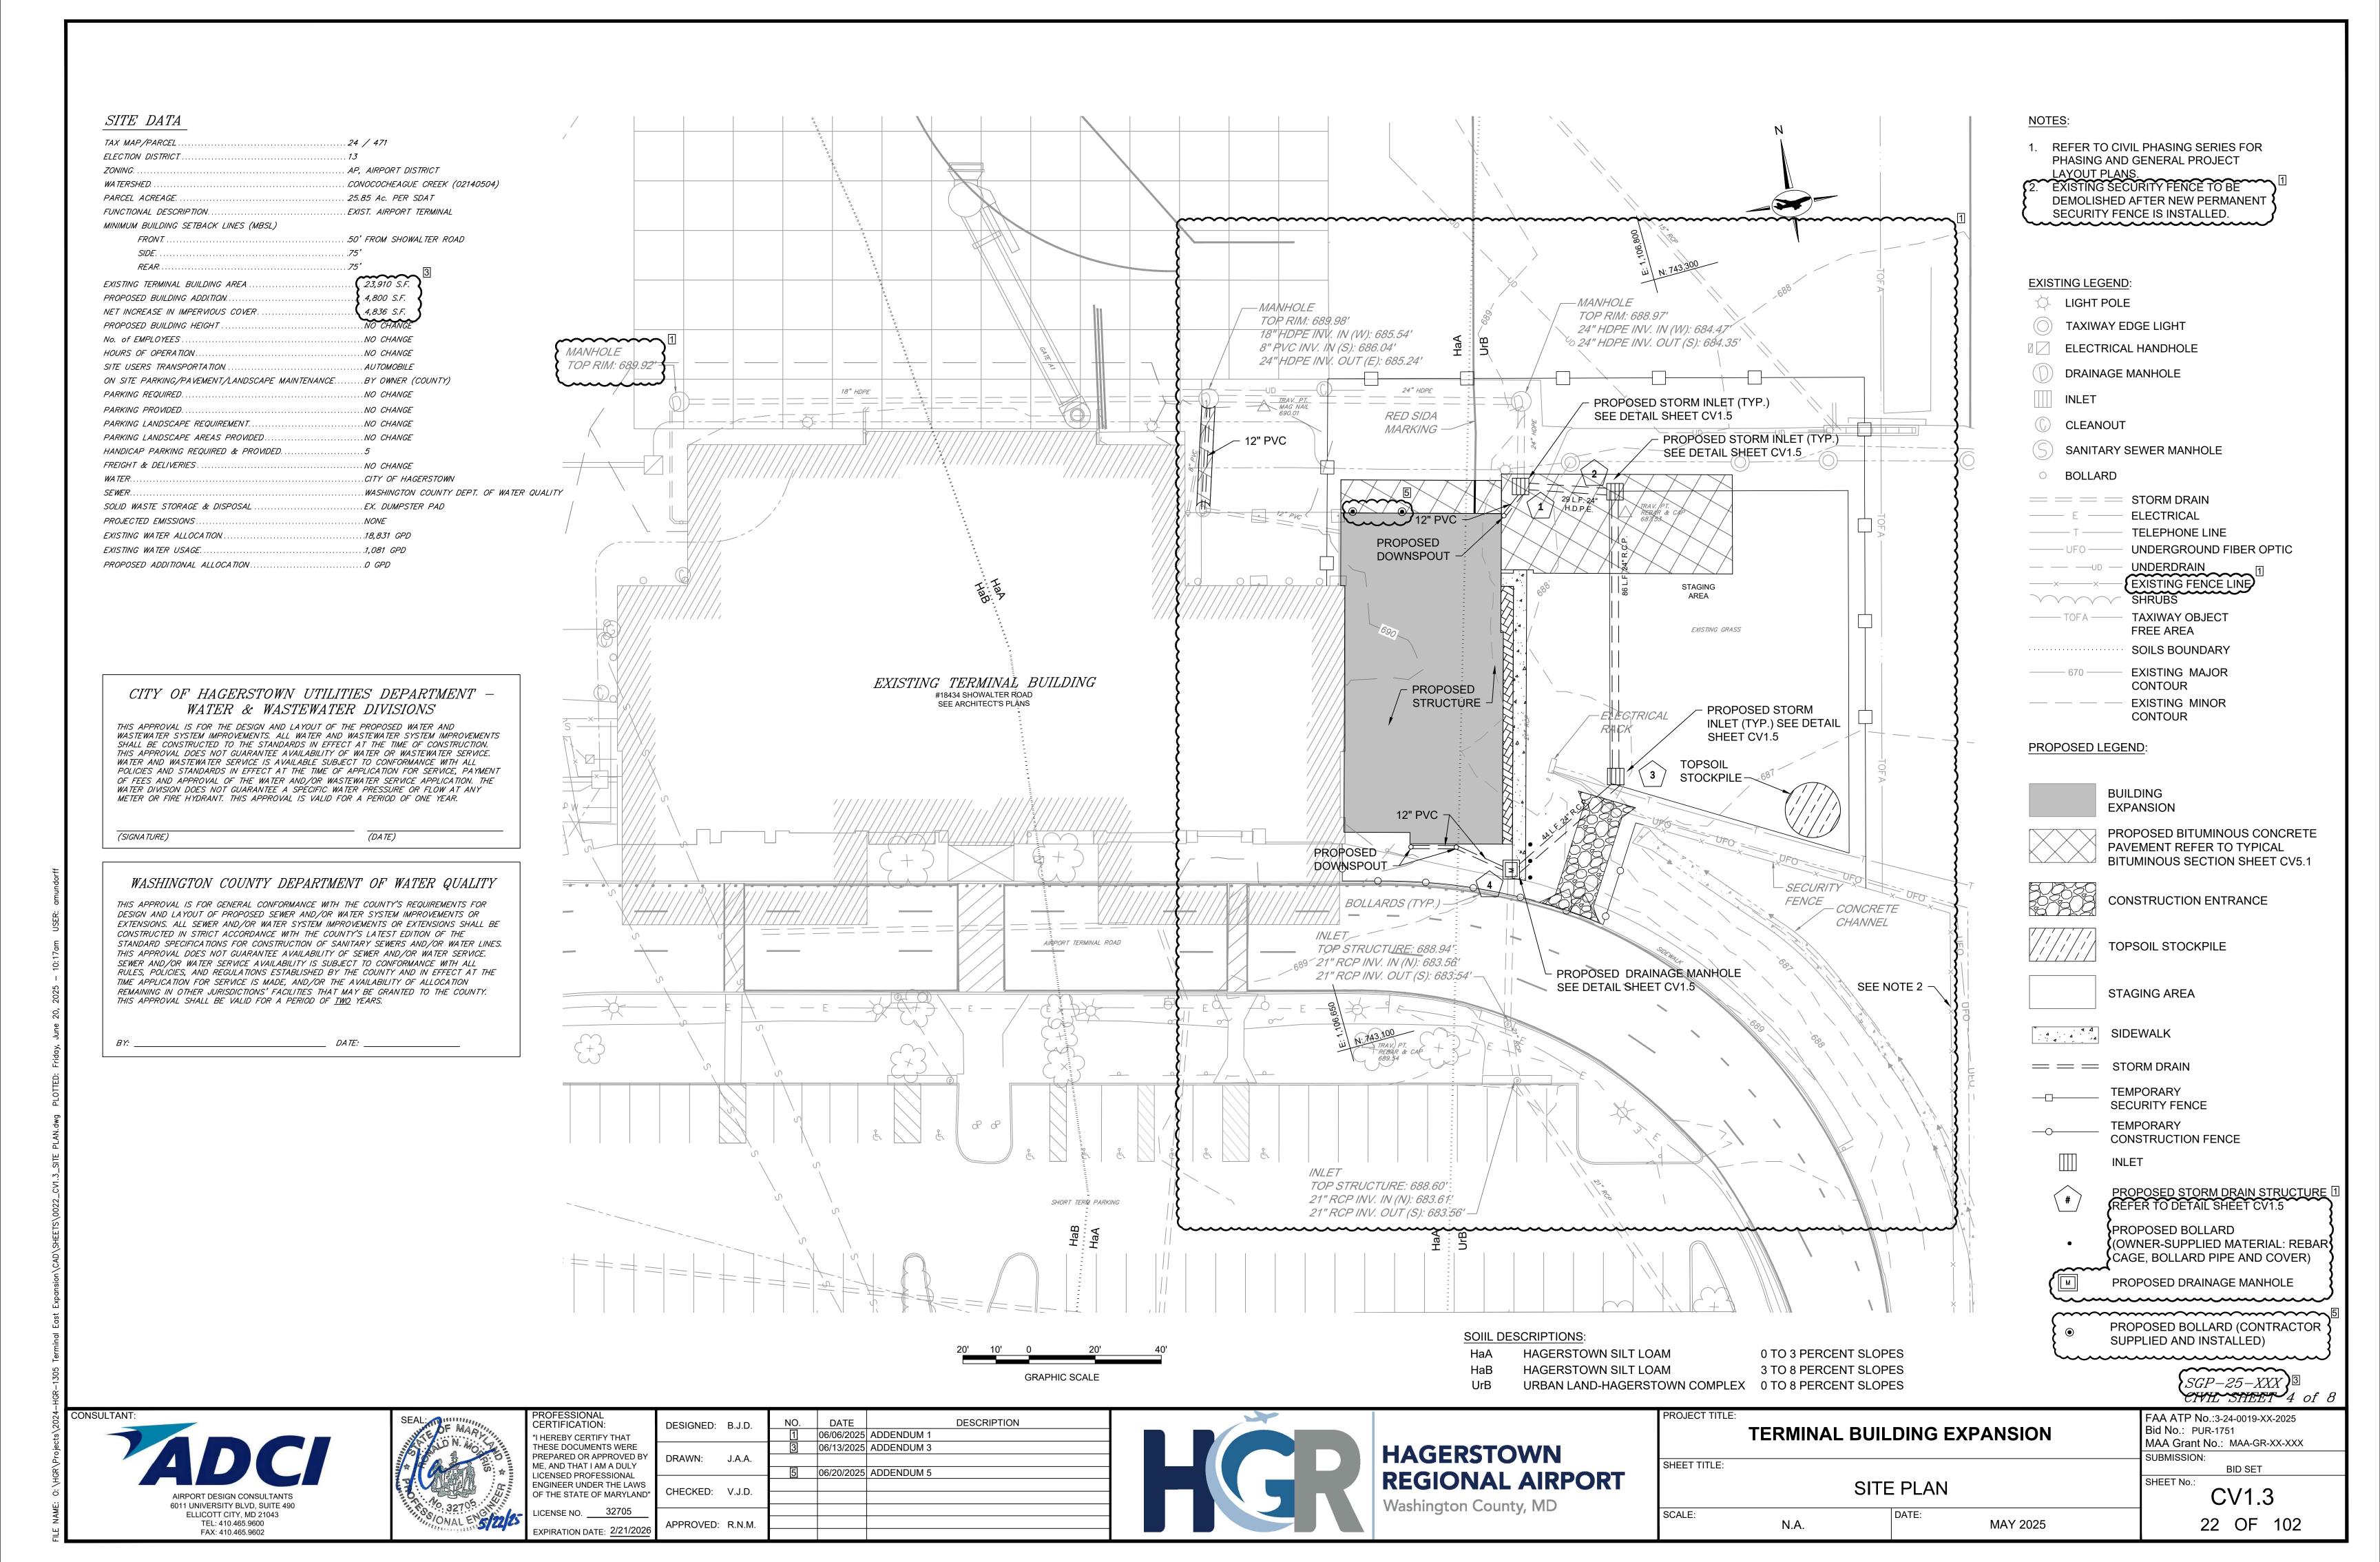

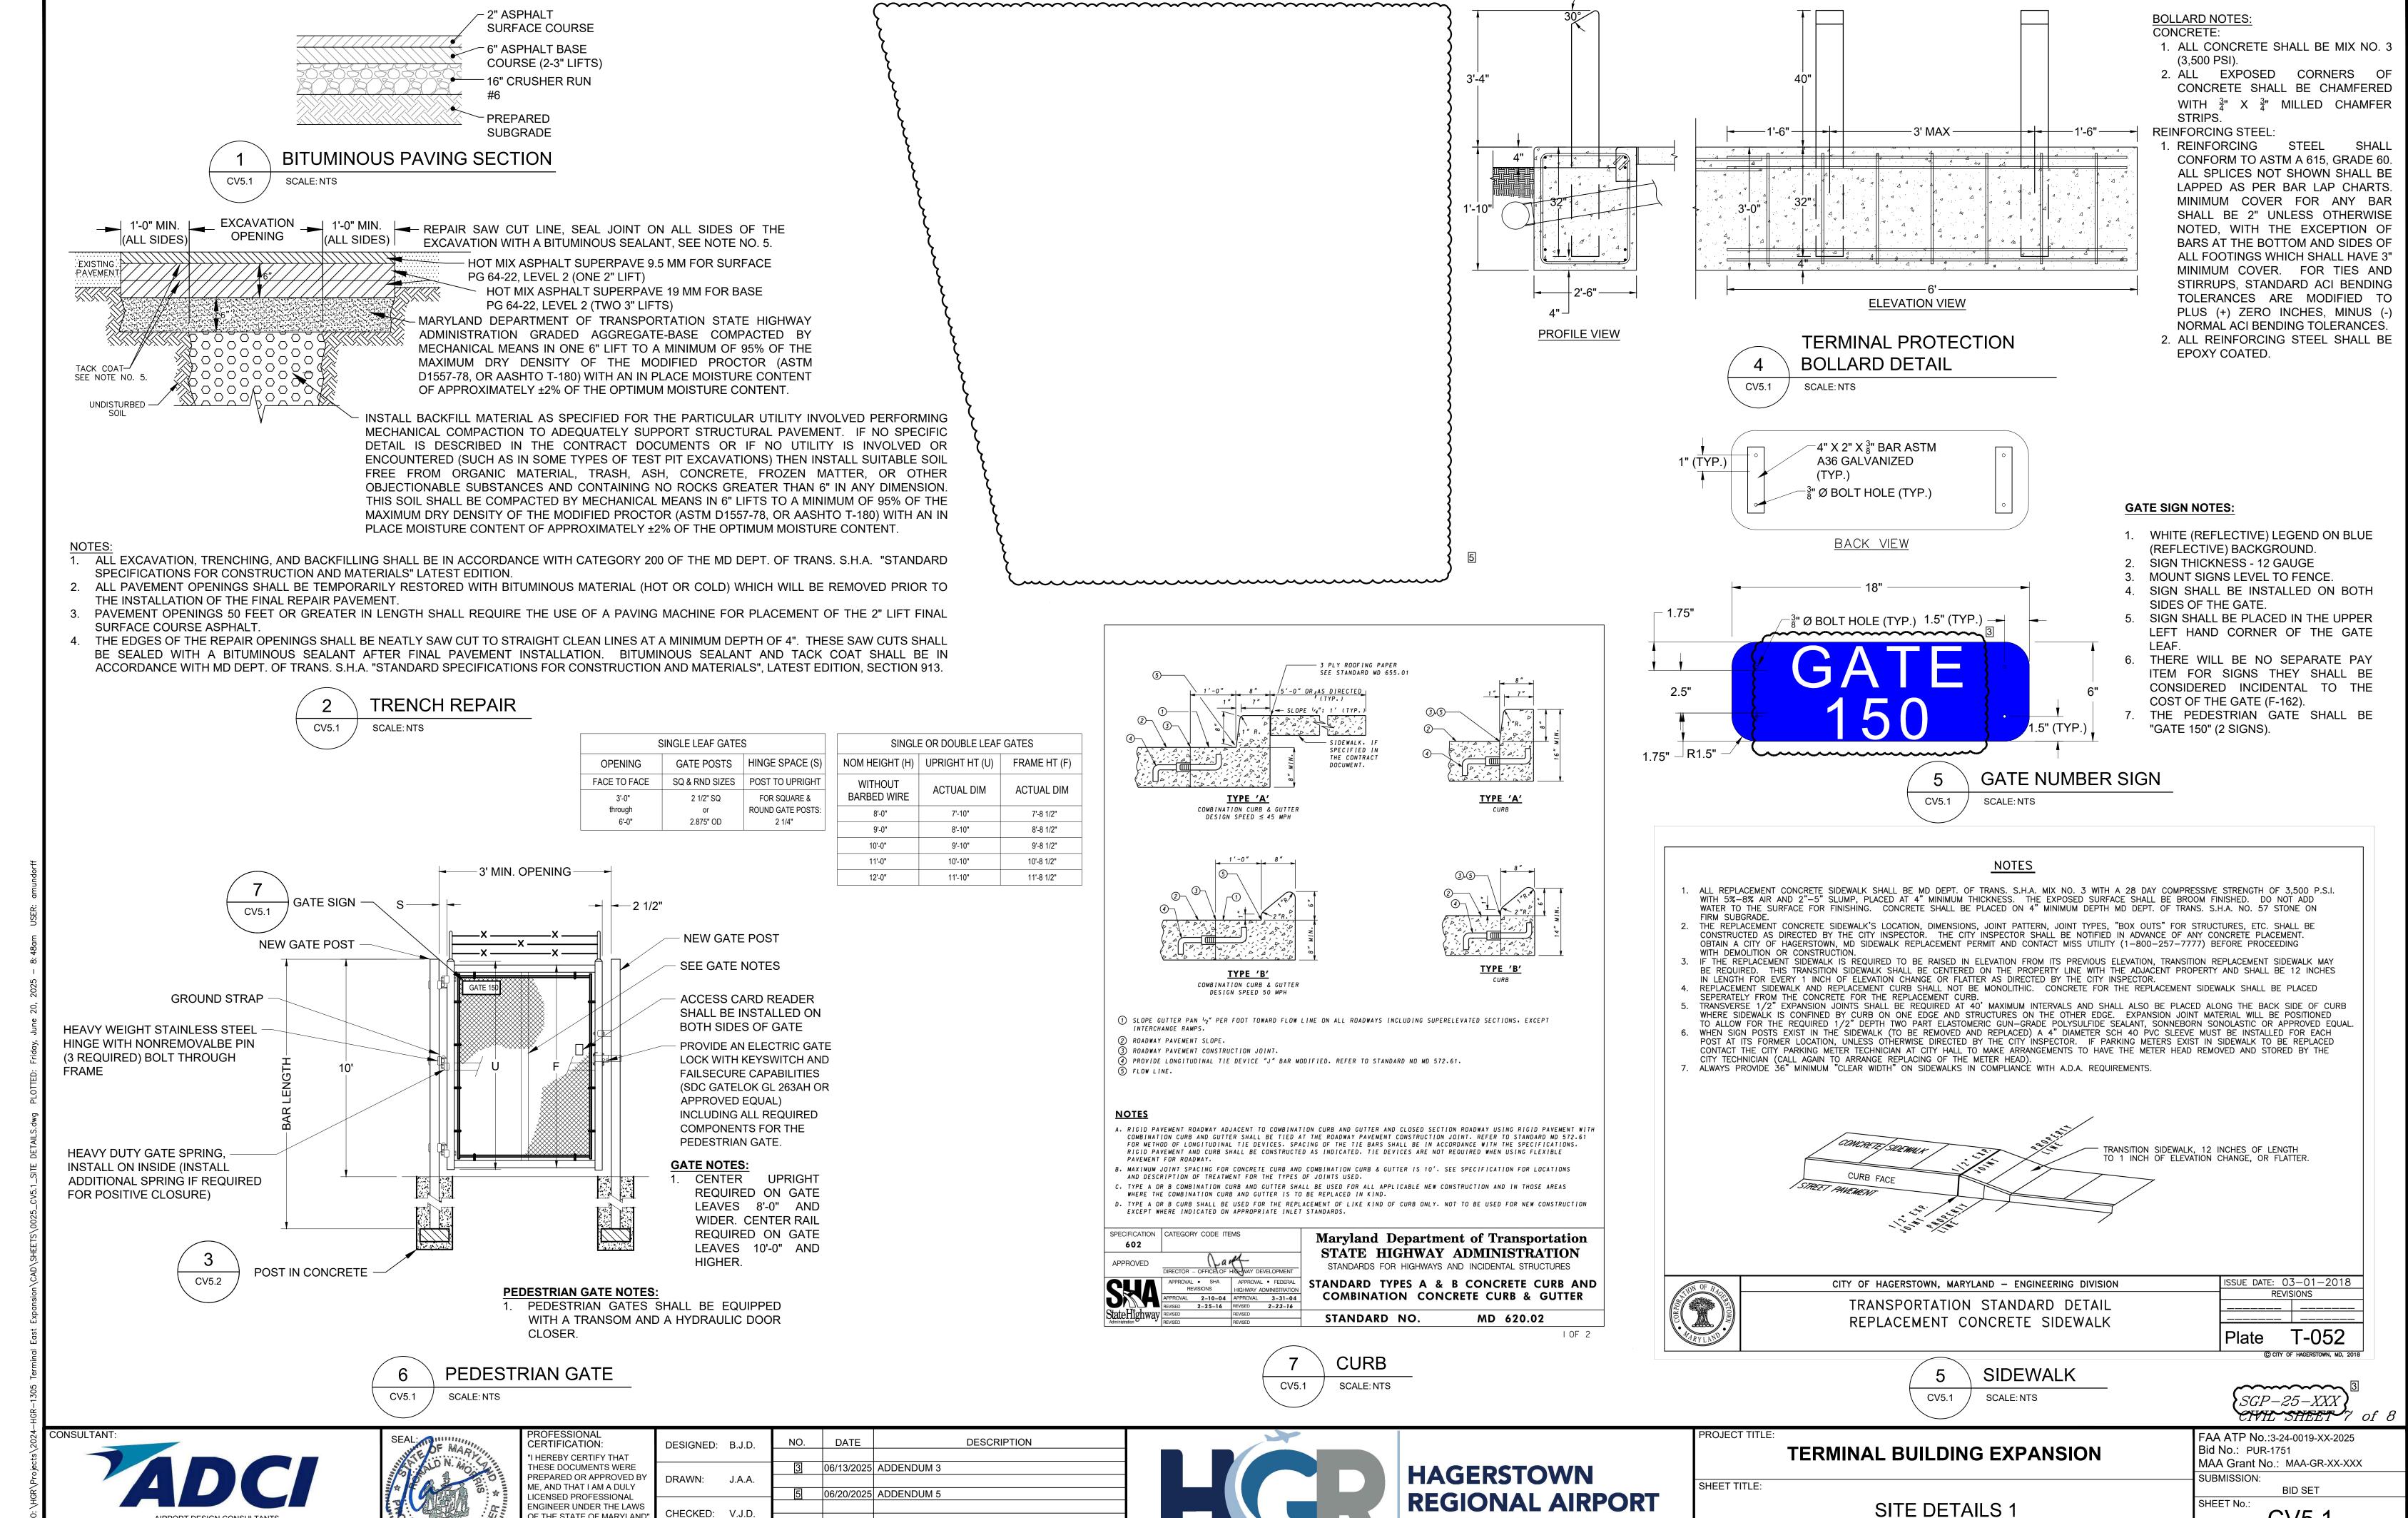

Washington County, MD

SCALE:

N.A.

CV5.1

MAY 2025

25 OF 102

CHECKED: V.J.D.

APPROVED: R.N.M.

OF THE STATE OF MARYLAND"

EXPIRATION DATE: 2/21/202

JICENSE NO. \_ 32705

6011 UNIVERSITY BLVD, SUITE 490

ELLICOTT CITY, MD 21043

TEL: 410.465.9600

FAX: 410.465.9602

# Attachment A



Originally designed in 1962, Eames Tandem Sling Seating has stood the test of time and provided a comfortable place for time and provided a comfortable place for millions waiting in airports and other public spaces throughout the years. The product first appeared in Chicago O'Hare Airport and Washington D.C. Dulles Airport, and its iconic form can now be found around the world.


With so many configuration options, the seating easily meets facility needs, and its sleek look complements spaces without overwhelming them, integrated power allows people to relax and plug in when they need to most.


# Designers Charles and Ray Eames


- Charging modules (USB or simplex)
   distributed evenly among seats
- and tables Durable, interchanging seats and pads without stitch lines that are


easy to care for



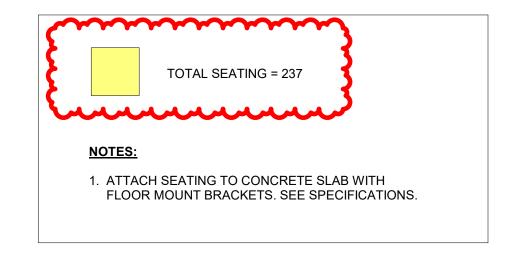

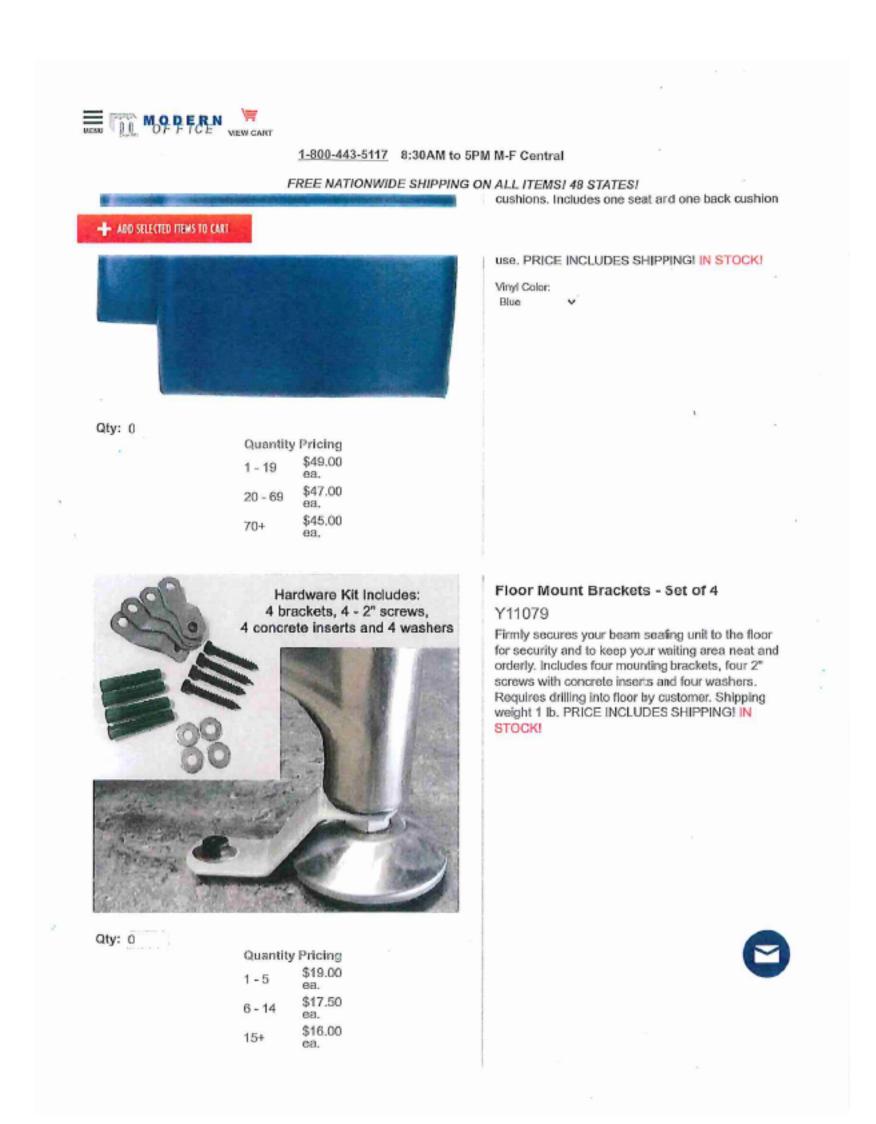

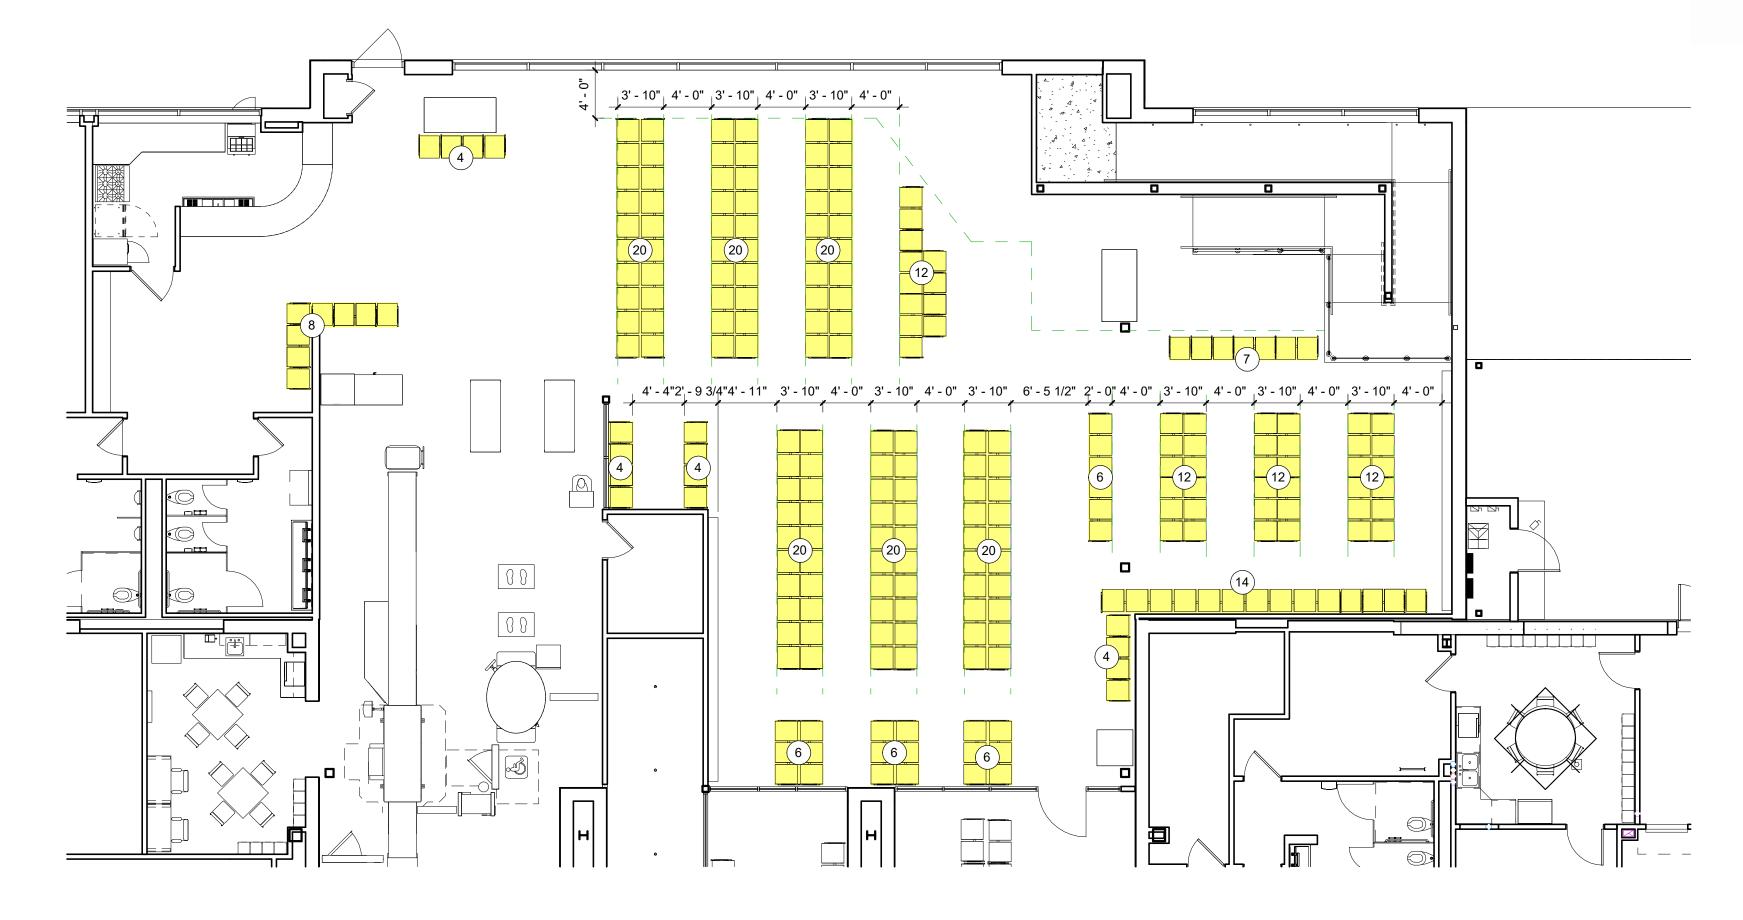

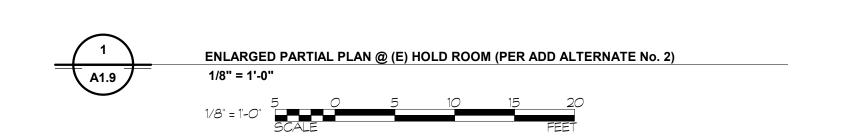



ELLICOTT CITY, MD 21043 PHONE: 410-465-9600

**473 NORTH POTOMAC STREET** 



rofessional Certification: hereby certify that these documents were prepared or approved by me, and that I am a duly licensed professional engineer under the laws of the State of Maryland. License No. 6157

DESCRIPTION DESIGNED: RAK 06.10.2025 Revised seating per owner (Addendum No. 1) Rev 2 06.19.2025 Revised seating per owner (Addendum No. 5) DRAWN: RAK CHECKED: NEM APPROVED: NEM Expiration Date: 09/07/2026



**HAGERSTOWN REGIONAL AIRPORT** Washington County, MD

PROJECT TITLE.	TERMINAL BUILDING EXPANSION	
SHEET TITLE:		

As indicated

ENLARGED PARTIAL PLAN @ (E) HOLD ROOM


MAY 2025

FAA AIP No.: 3-24-0019-XX-2025 Bid No.: PUR-1751 MAA Grant No.: MAA-GR-XX-XXX SUBMISSION: **BID SET** SHEET No.:


LOCATION

KEY PLAN

**44** OF **102** 

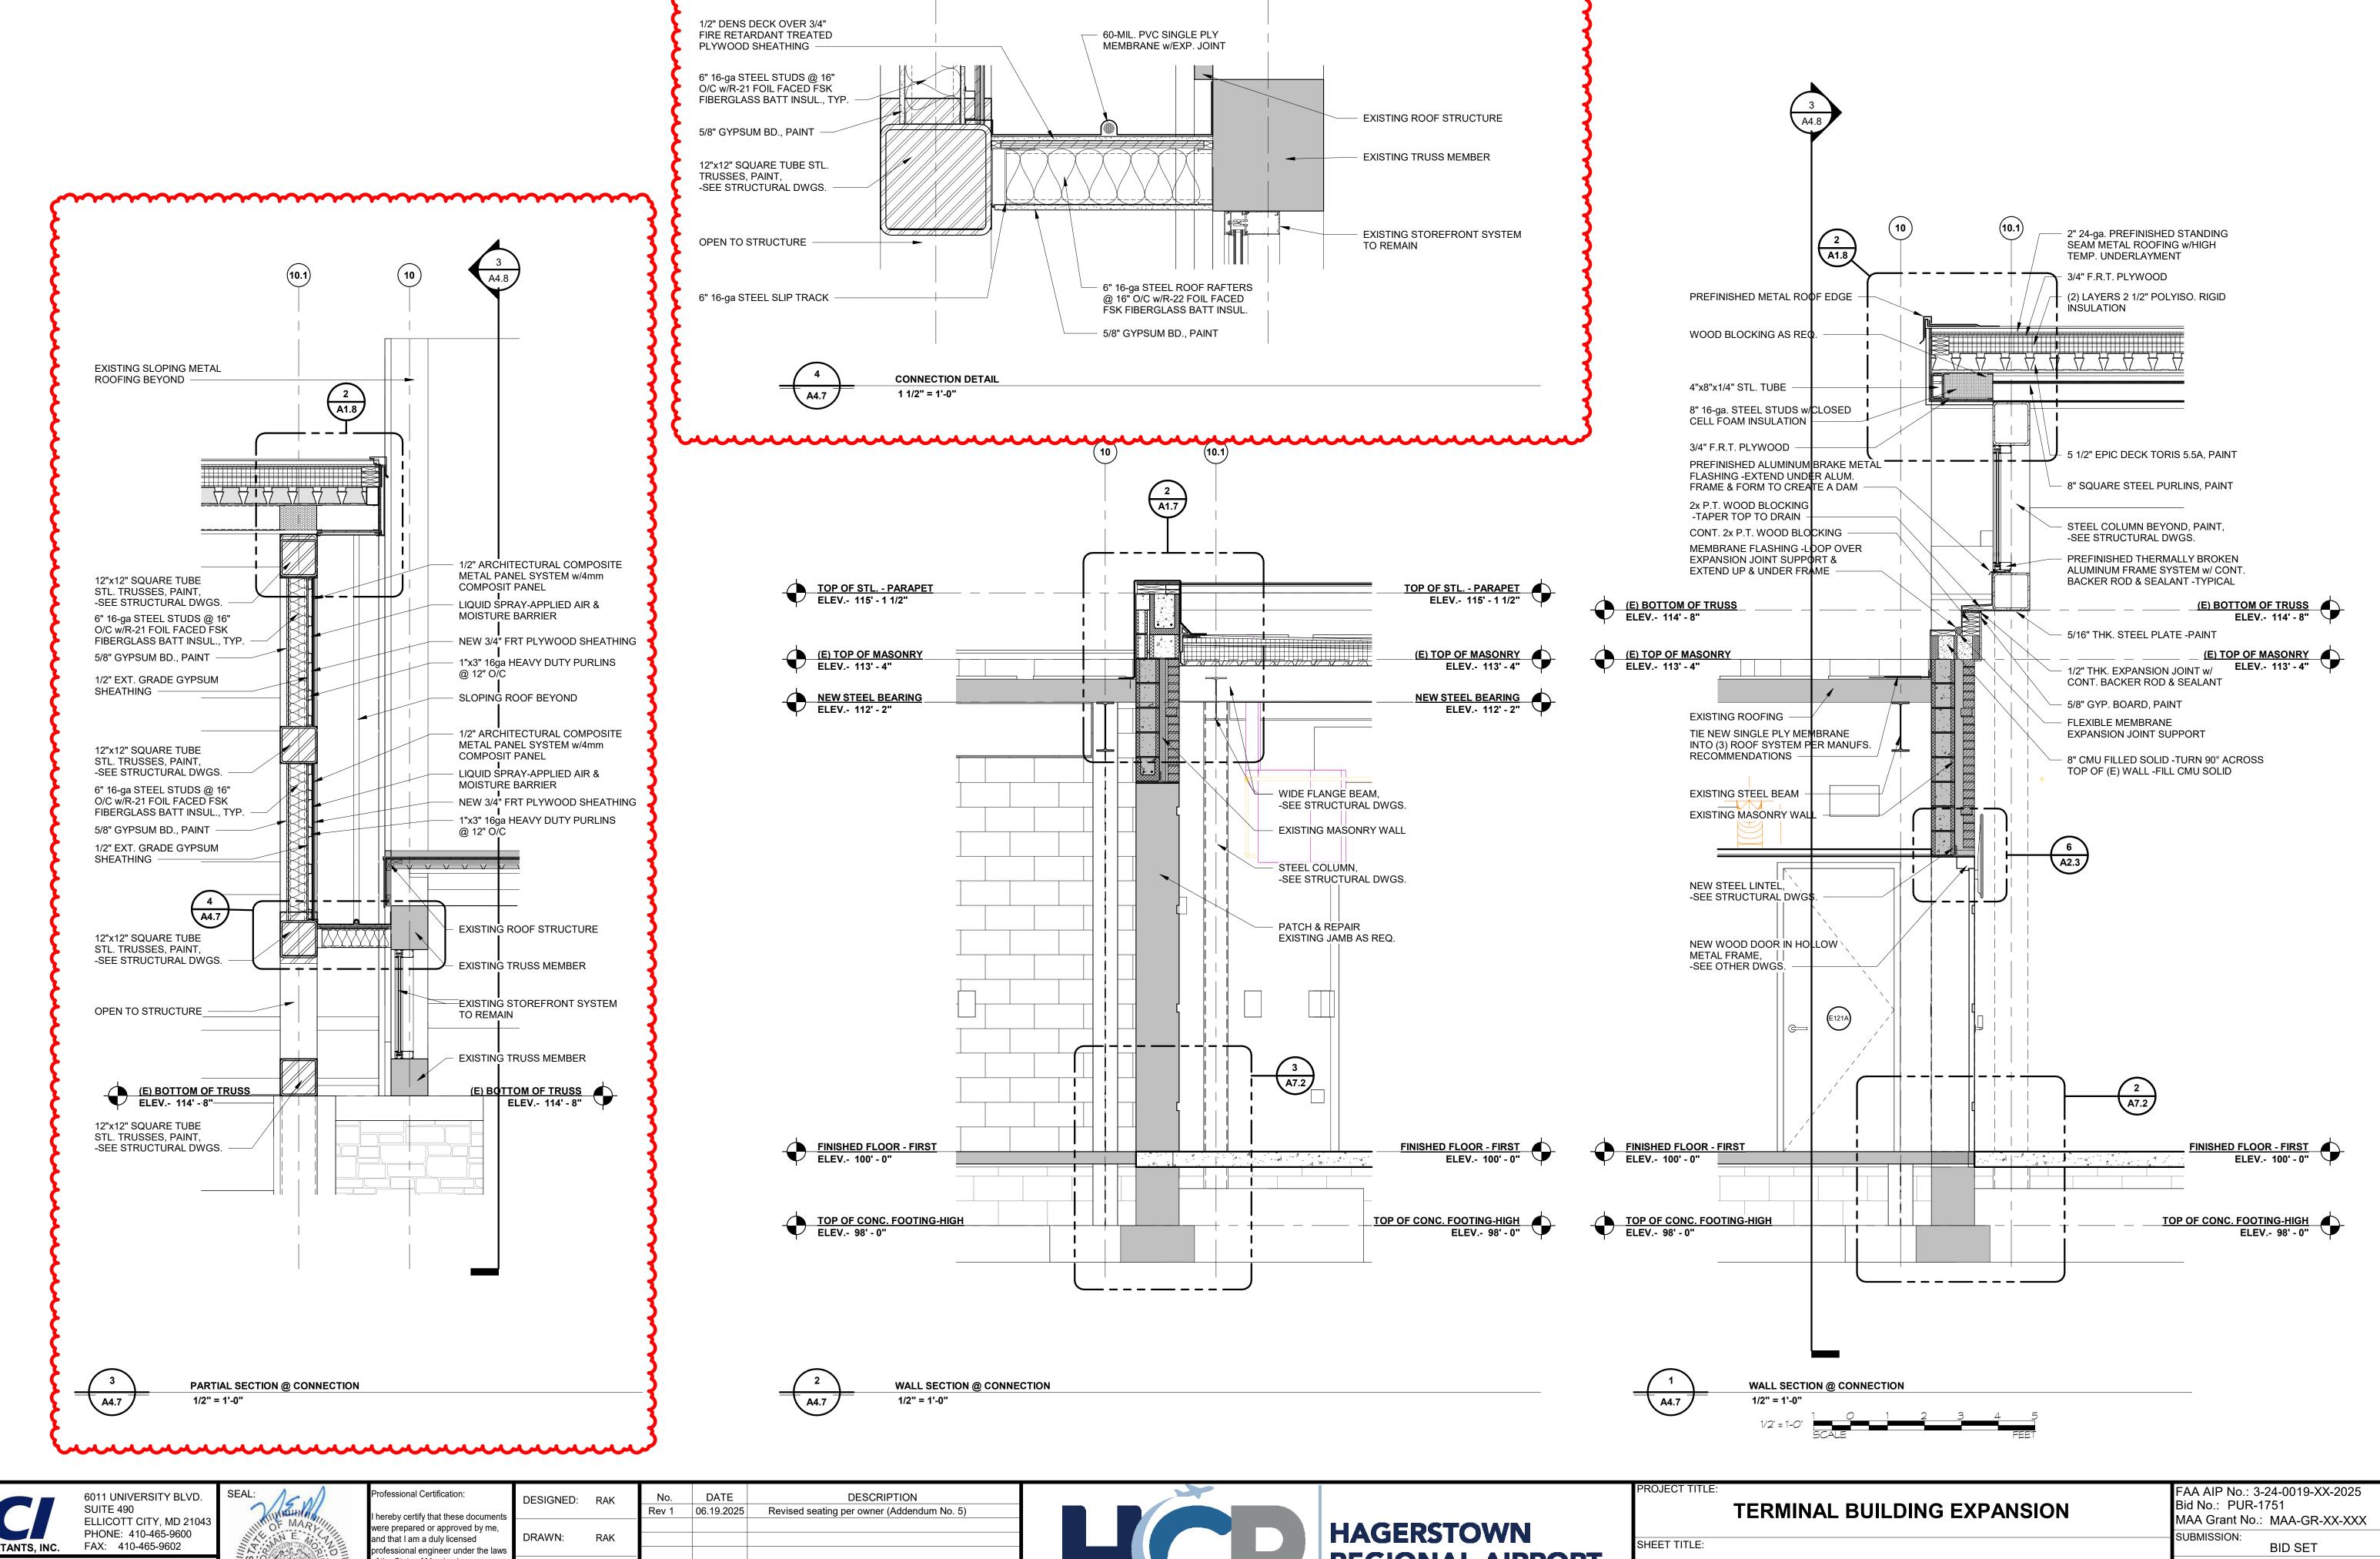



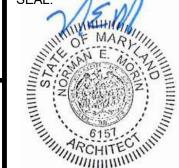


of the State of Maryland. License No. 6157 Expiration Date: 09/07/2026

	DECICIAED.	11/7/11			
ments			Rev 1	06.19.2025	Revised seating per owner (Addendum No. 5)
me, e laws	DRAWN:	RAK			
	CHECKED:	NEM			
5	APPROVED:	NEM			



TERMINAL BUILDING EXPANSION			FAA AIP No.: 3-24-0019-XX-2025 Bid No.: PUR-1751 MAA Grant No.: MAA-GR-XX-XXX
SHEET TITLE:			SUBMISSION: BID SET
	WALL S	SECTIONS	SHEET No.: A4.7
SCALE:		DATE:	57 or 100
ı	As indicated	MAY 2025	<b>57</b> OF <b>102</b>

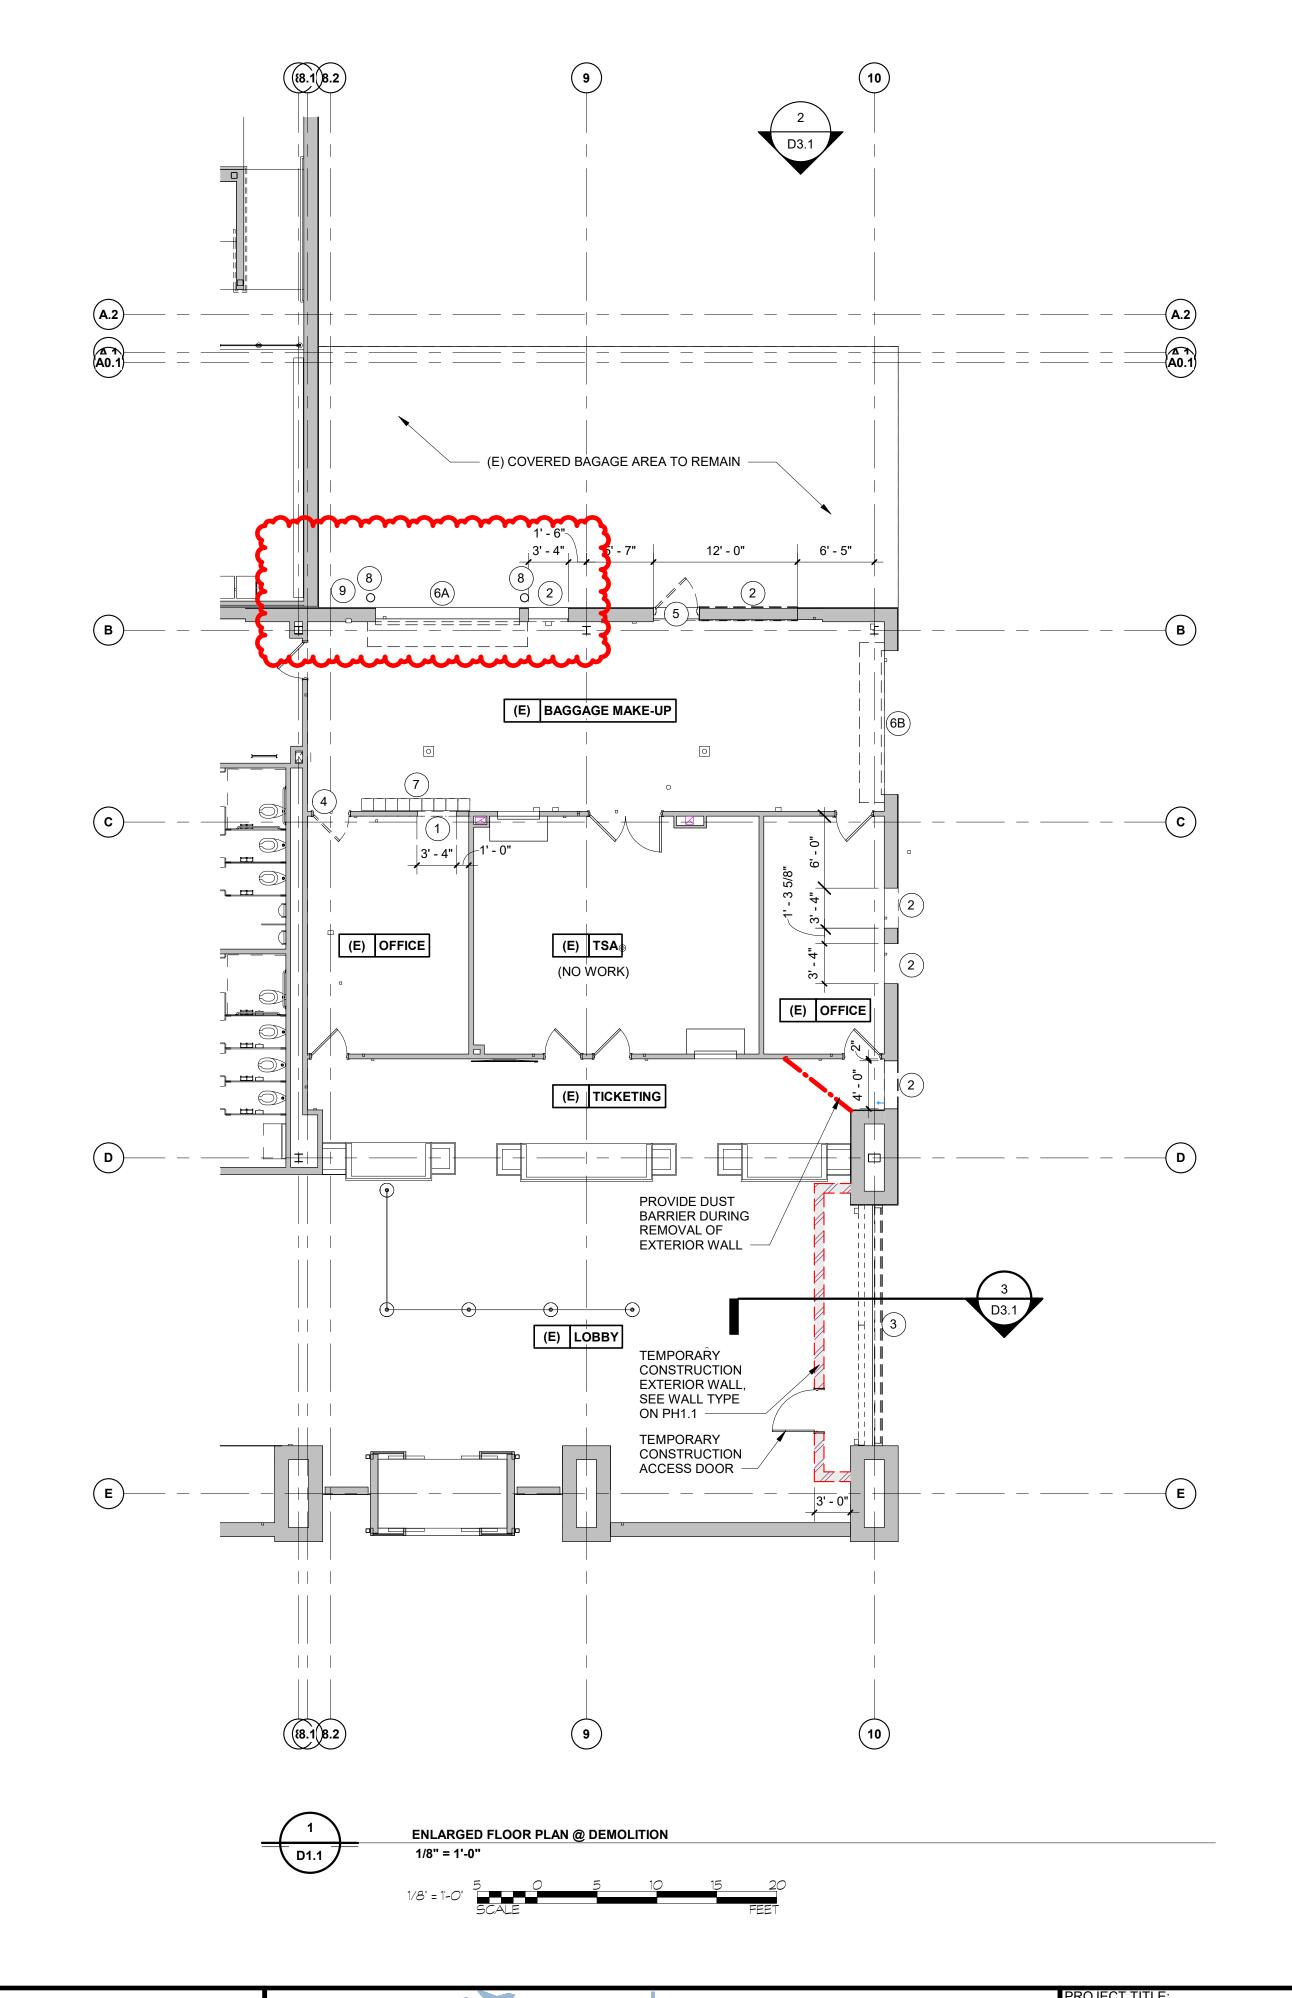


# **ATTACHMENT B**

## **DEMOLITION LEGEND**

- METAL STUD AND GYPSUM BOARD WALLS TO BE REMOVED. (ADD ALTERNATE No. 1)
- PORTION OF EXISTING MASONRY TO BE REMOVED FOR NEW OPENING. PATCH & REPAIR ADJACENT FINISHES AS REQ'D. (BASE BID)
- 3 EXISTING ALUMINUM STOREFRONT TO BE REMOVED. (BASE BID)
- FLUSH WOOD DOORS AND HOLLOW METAL FRAMES TO BE REMOVED. (ADD ALTERNATE No. 1)
- 5 EXISTING HOLLOW METAL DOOR & FRAME TO BE REMOVED. (BASE BID)
- EXISTING OVERHEAD DOOR & ASSOCIATED HARDWARE & TRIM TO BE REMOVED & SAVED FOR REUSE. PATCH & REPAIR ADJACENT MATERIALS AS REQUIRED. (BASE BID)
- EXISTING OVERHEAD DOOR & ASSOCIATED HARDWARE & TRIM TO BE REMOVED. PATCH & REPAIR ADJACENT MATERIALS AS REQUIRED. (BASE BID)
- 7 REMOVE AND RELOCATE EXISTING LOCKERS. SEE 1/A1.3. (ADD ALTERNATE No. 1)
- REMOVE EXISTING BOLLARD FOR CONSTRUCTION OF NEW ELECTRIC ROOM WALL.
- REMOVE EXISTING OVERHEAD DOOR CONTROLS FOR CONSTRUCTION OF NEW ELECTRIC ROOM WALL.



6011 UNIVERSITY BLVD. SUITE 490 ELLICOTT CITY, MD 21043 PHONE: 410-465-9600

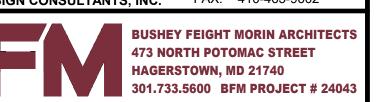



rofessional Certification: hereby certify that these documents ere prepared or approved by me, and that I am a duly licensed professional engineer under the laws of the State of Maryland. License No. 6157

Expiration Date: 09/07/2026

DESCRIPTION DESIGNED: RAK 06.17.2025 Revised (Addendum No. 3) Rev 2 06.18.2025 Revised (Addendum No. 4) DRAWN: RAK CHECKED: NEM APPROVED: NEM



HAGERSTOWN
REGIONAL AIRPORT
Washington County, MD

SCALE:


As indicated


1110020111122	TERMINAL BUILDING EXPANSION
SHEET TITLE:	
I EN	I ADCED EL COD DI ANI AT DEMOLITICAL


FAA AIP No.: 3-24-0019-XX-2025 Bid No.: PUR-1751 MAA Grant No.: MAA-GR-XX-XXX SUBMISSION: **BID SET** SHEET No.:


ENLARGED FLOOR PLAN AT DEMOLITION MAY 2025

31 OF 102

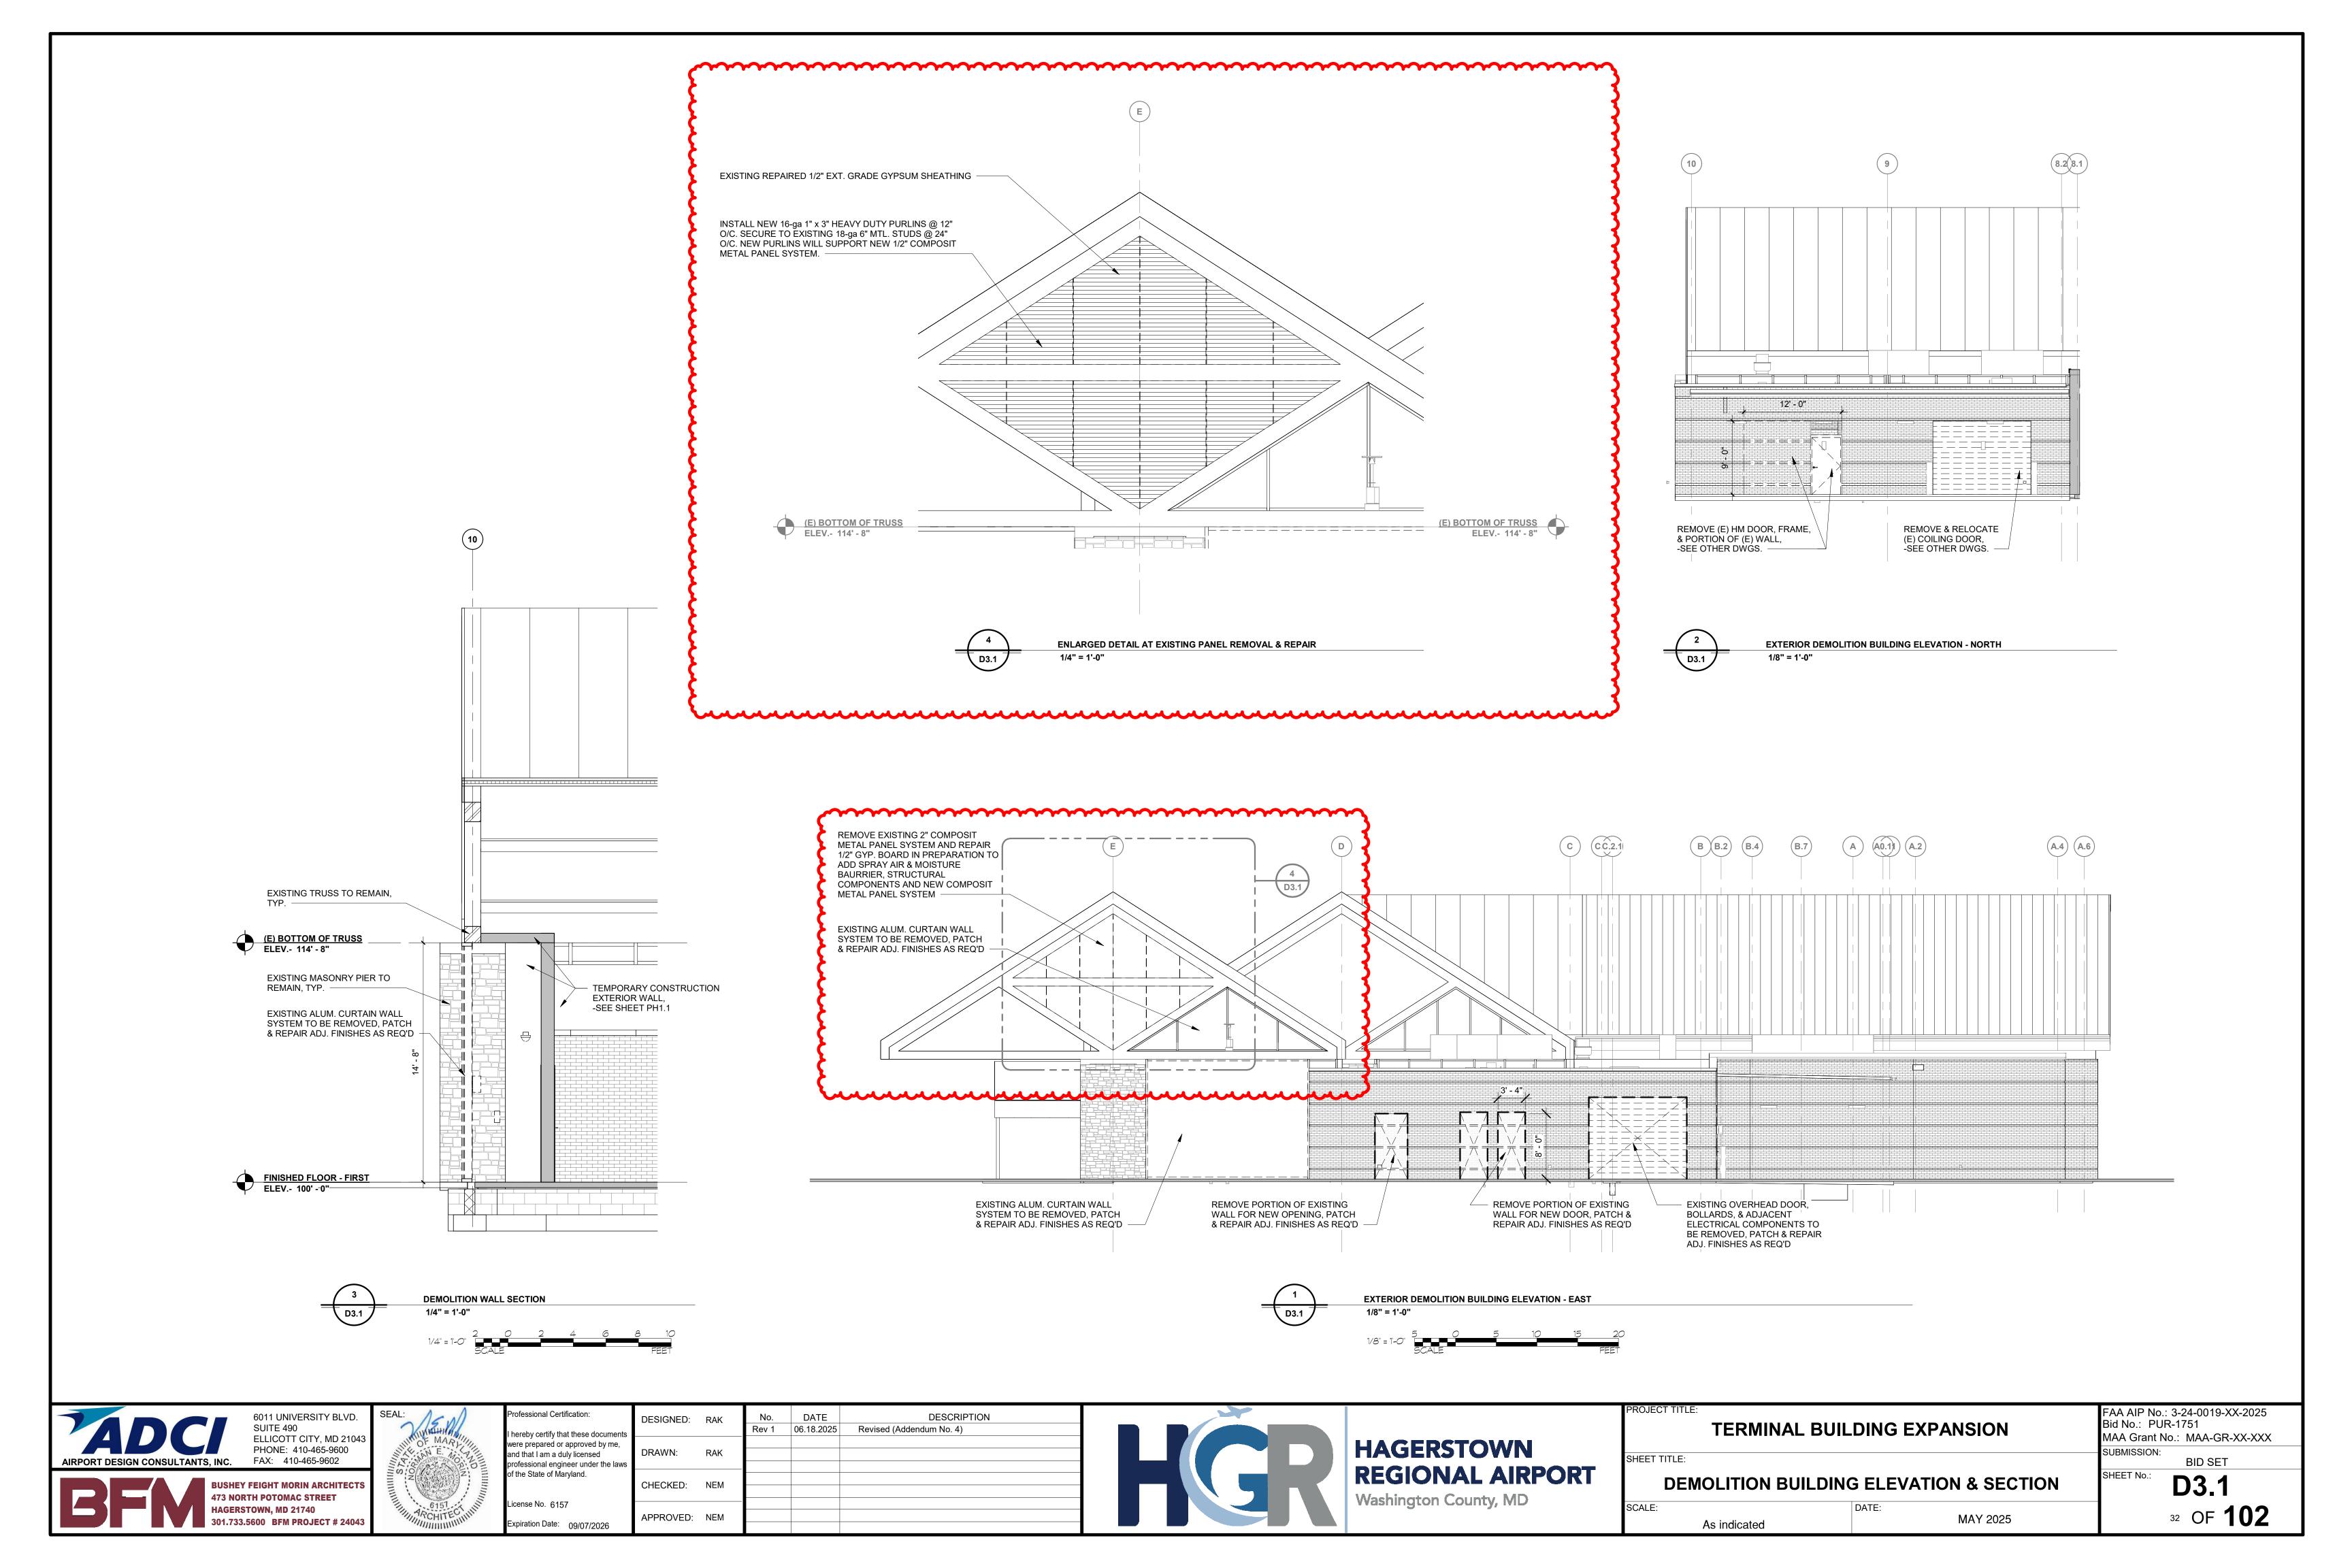

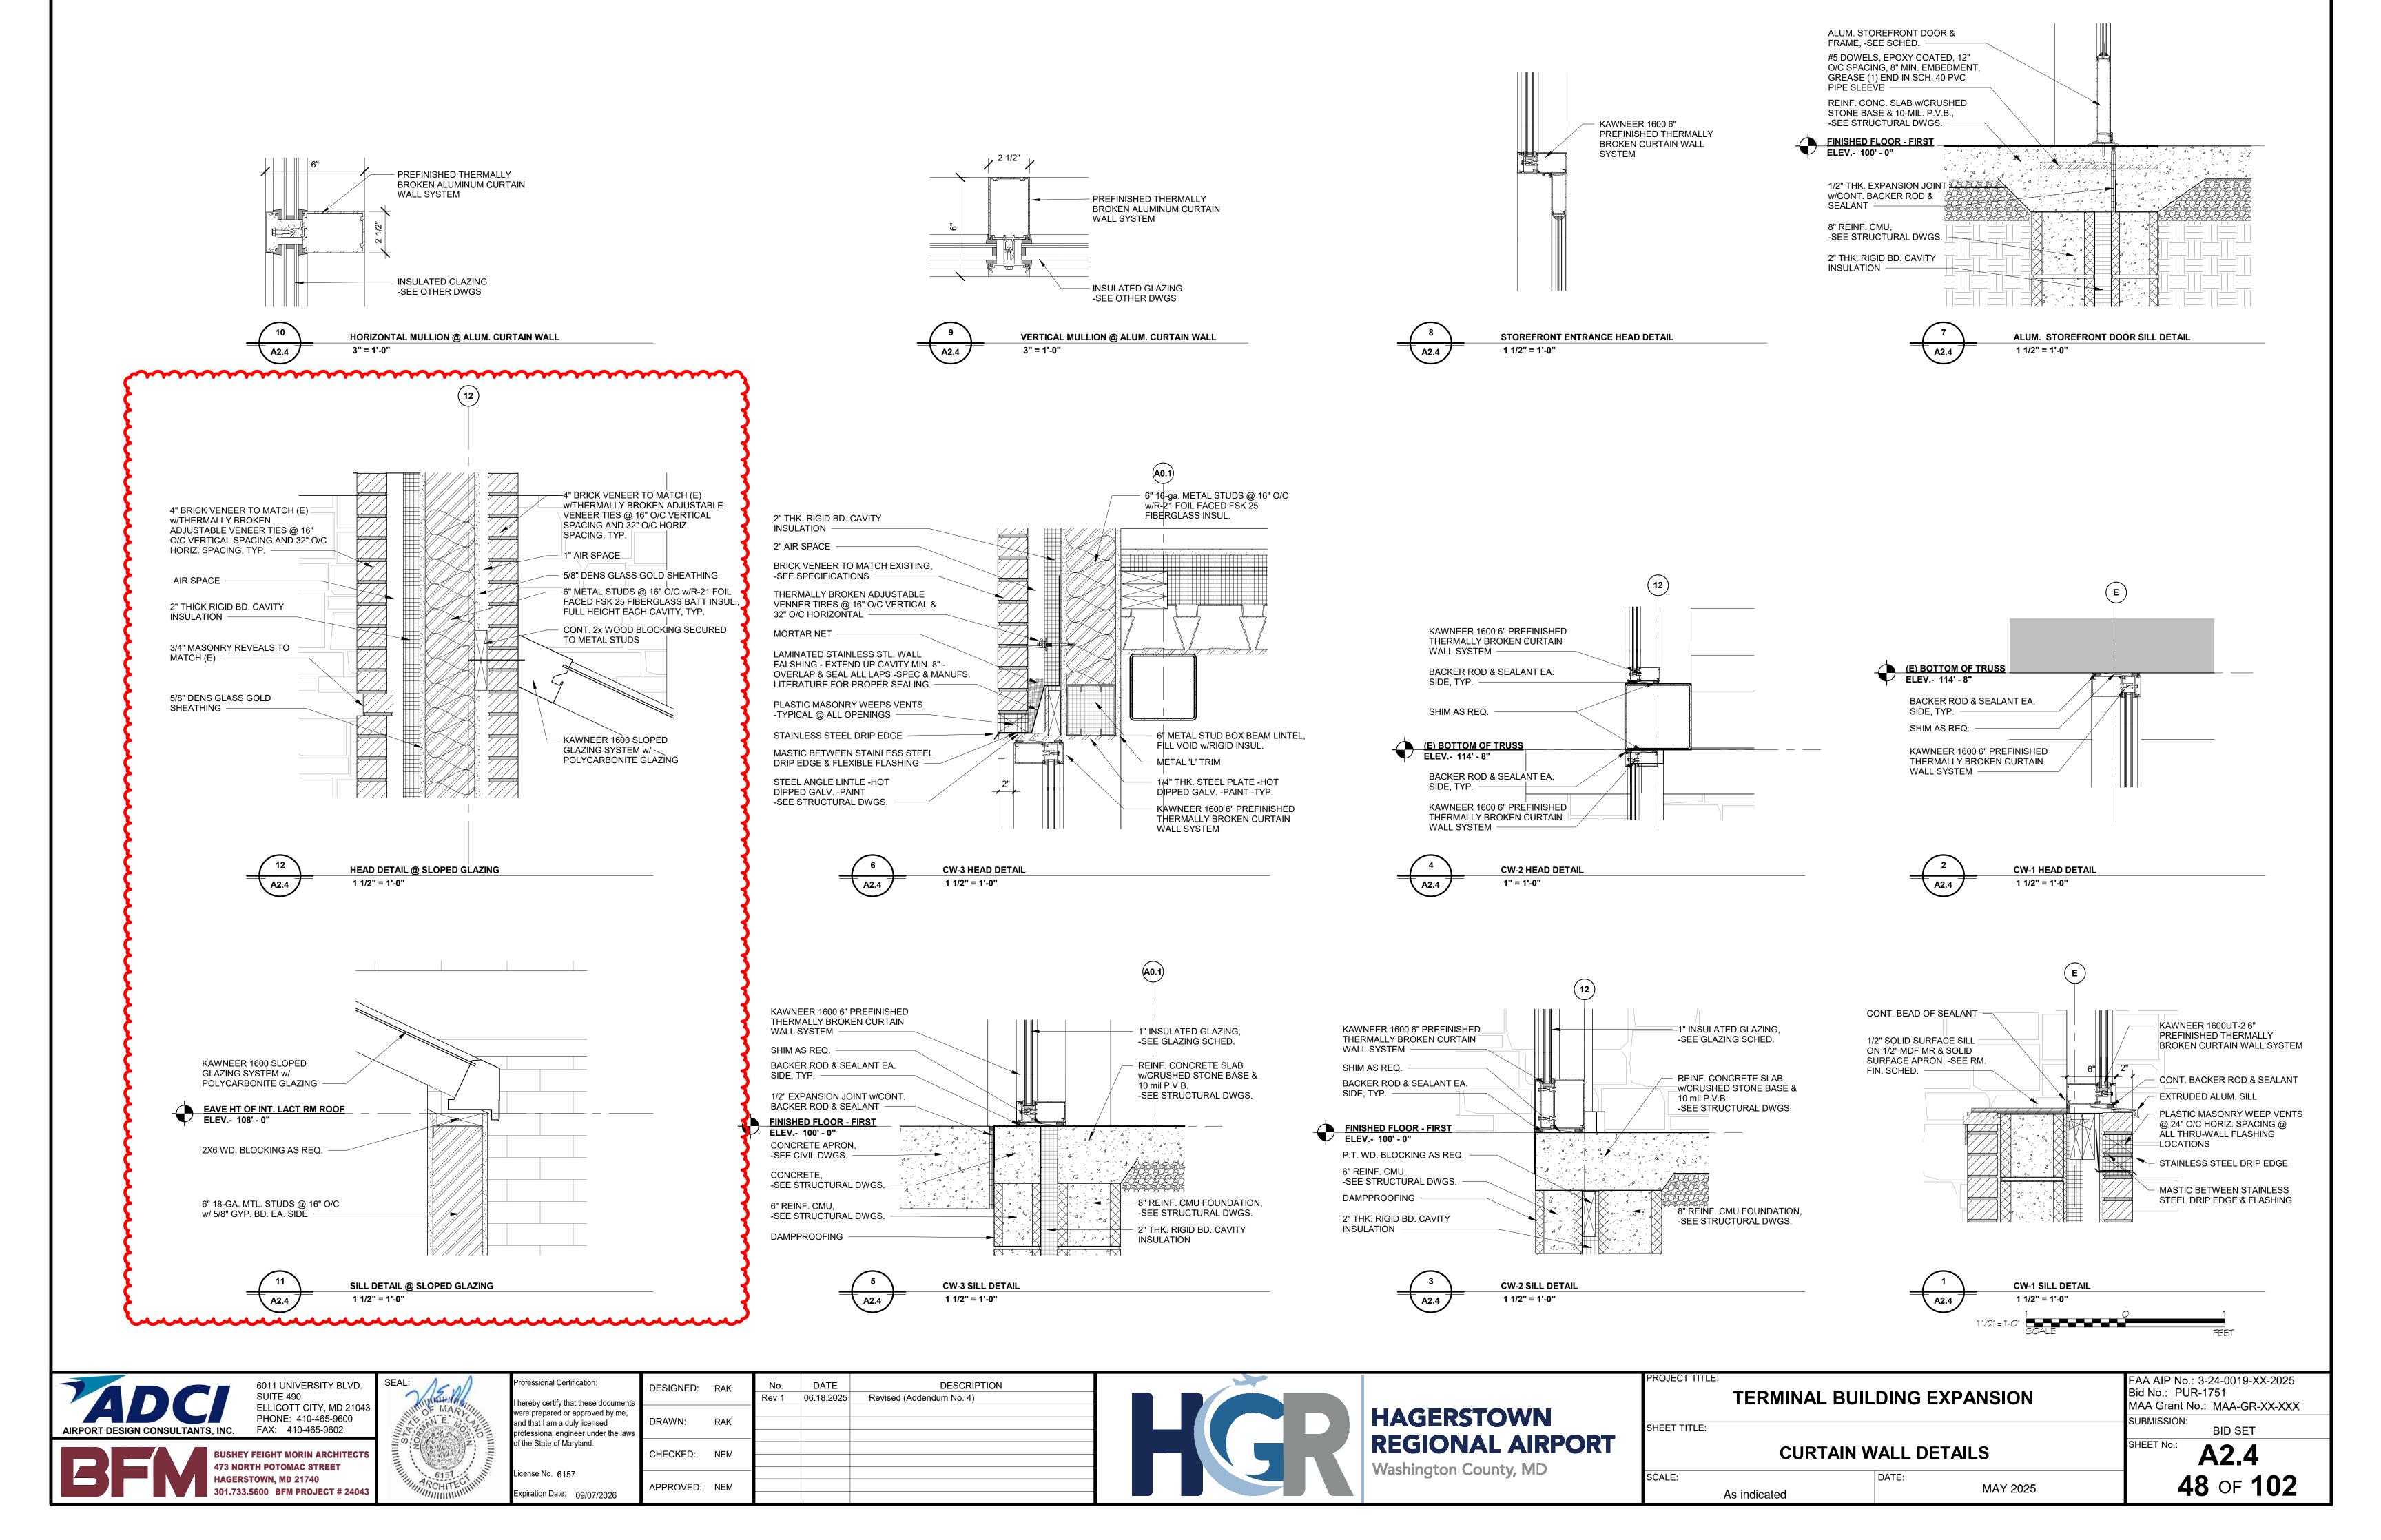

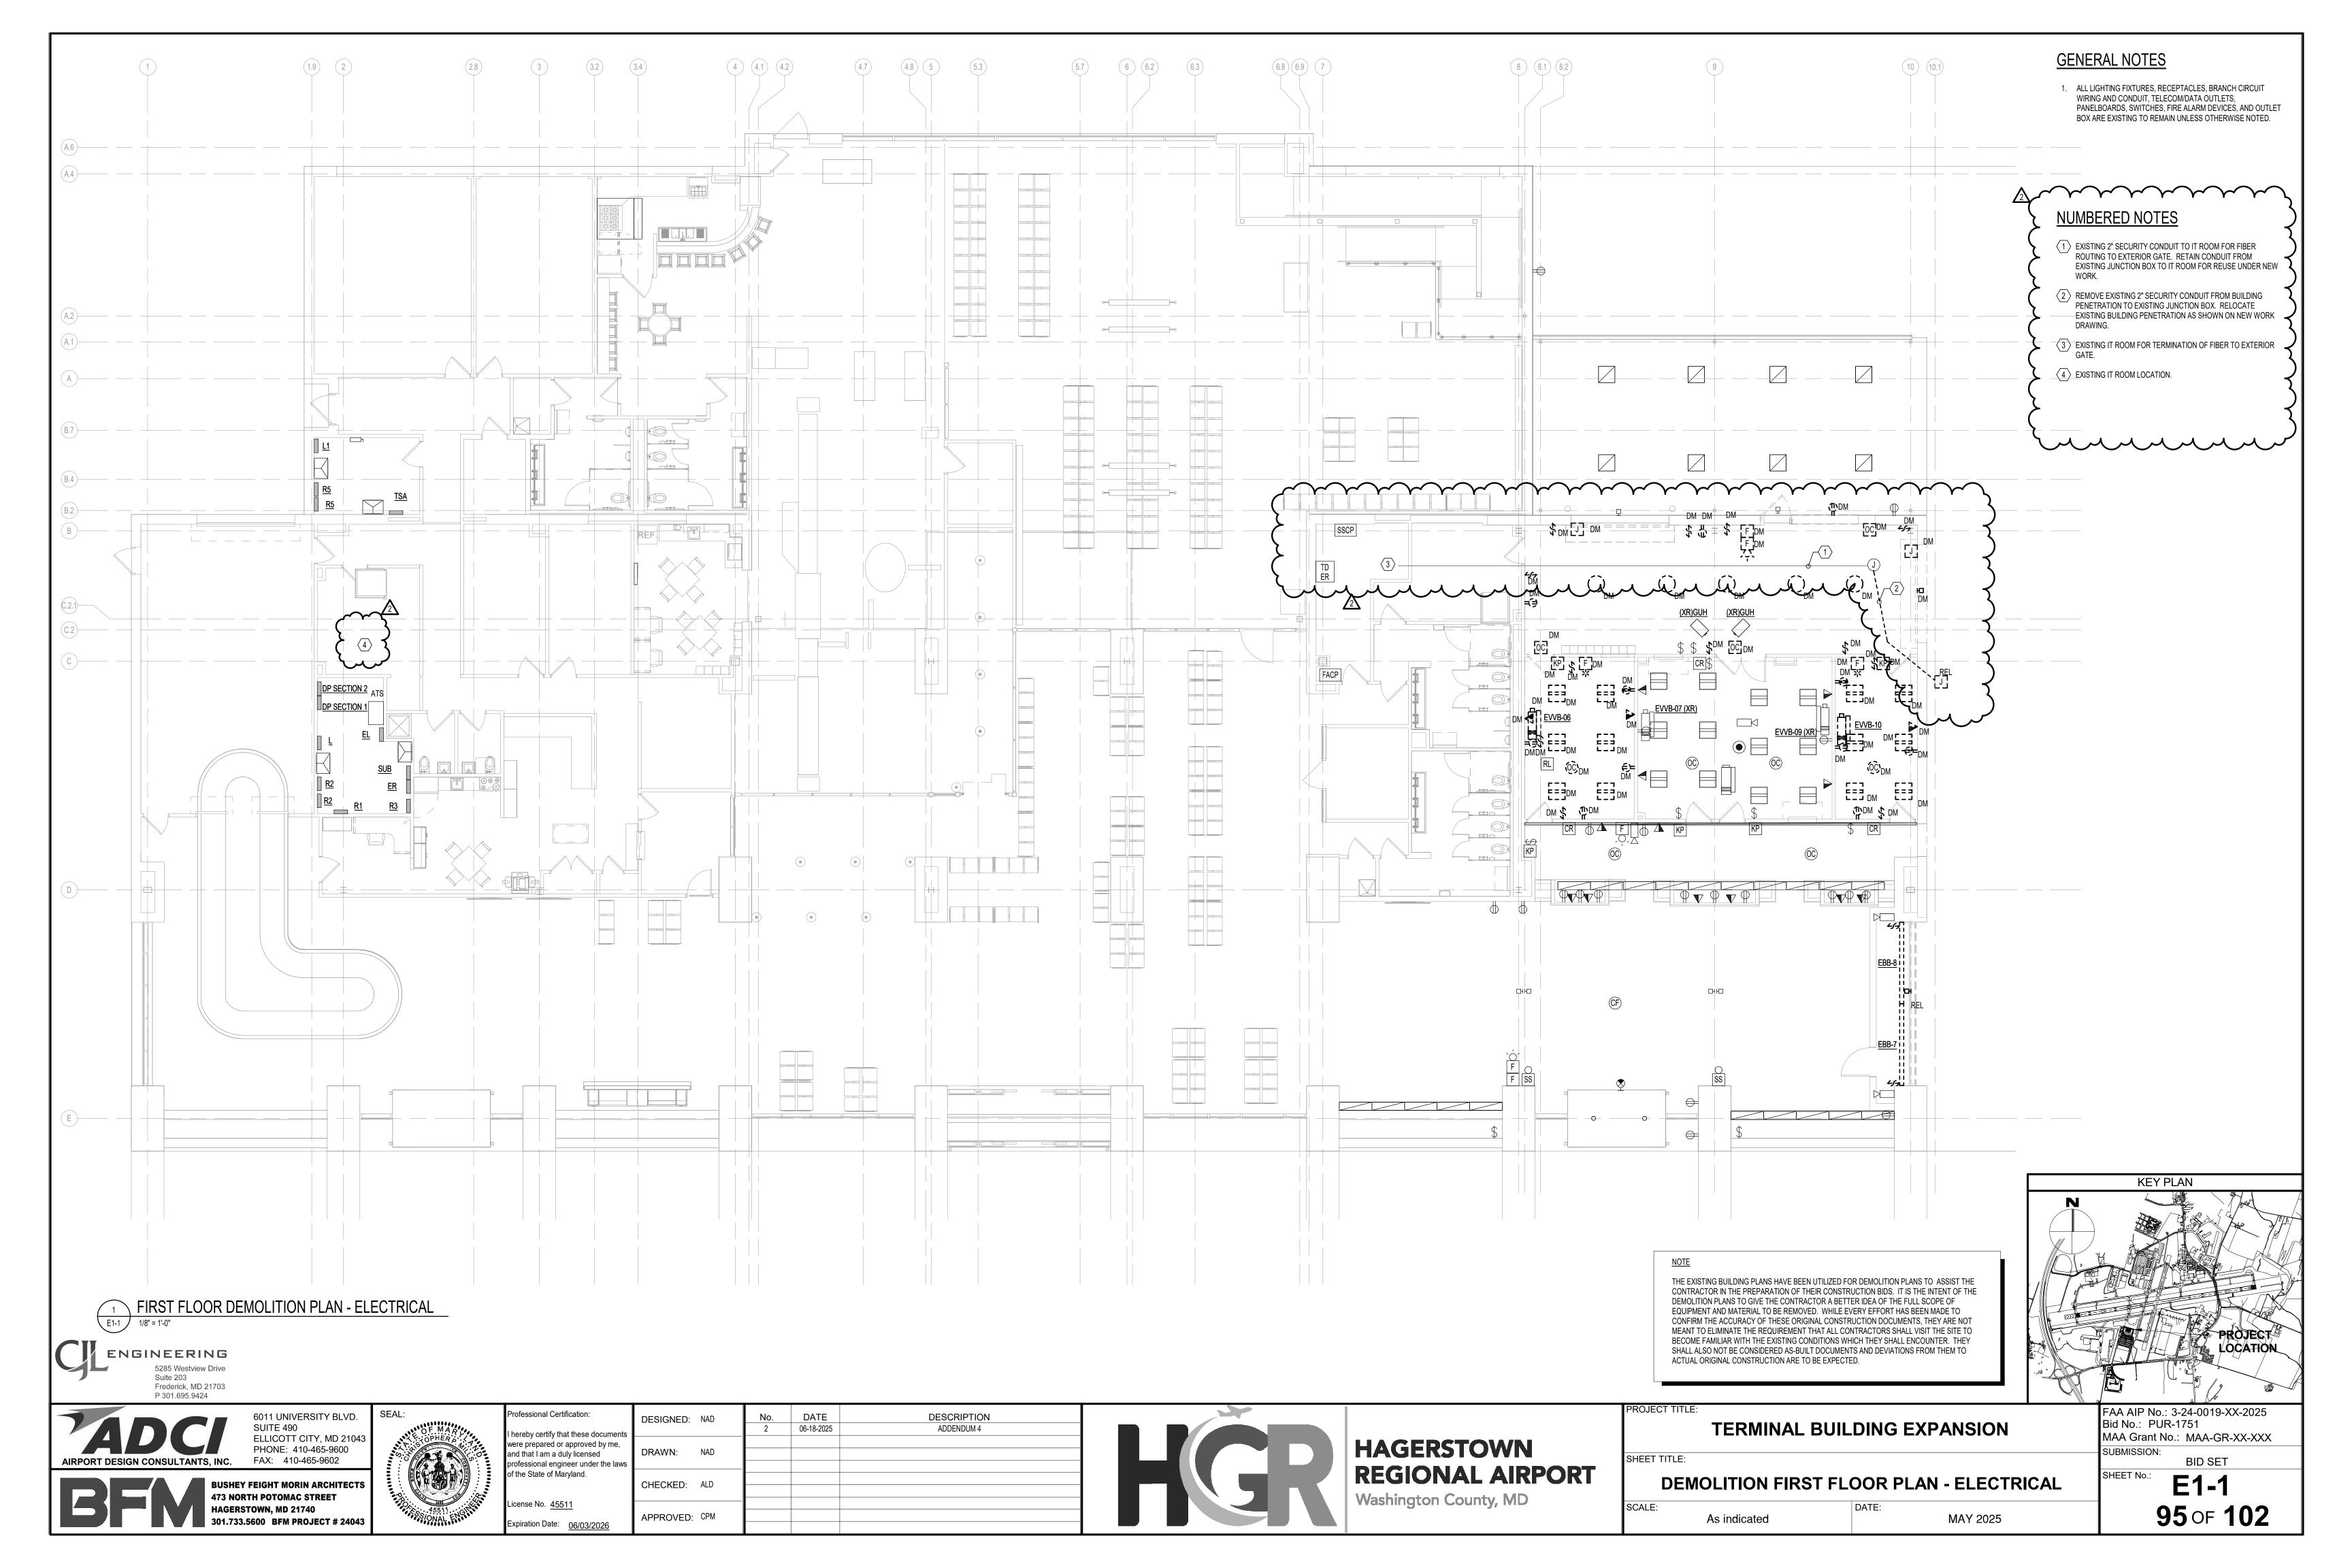

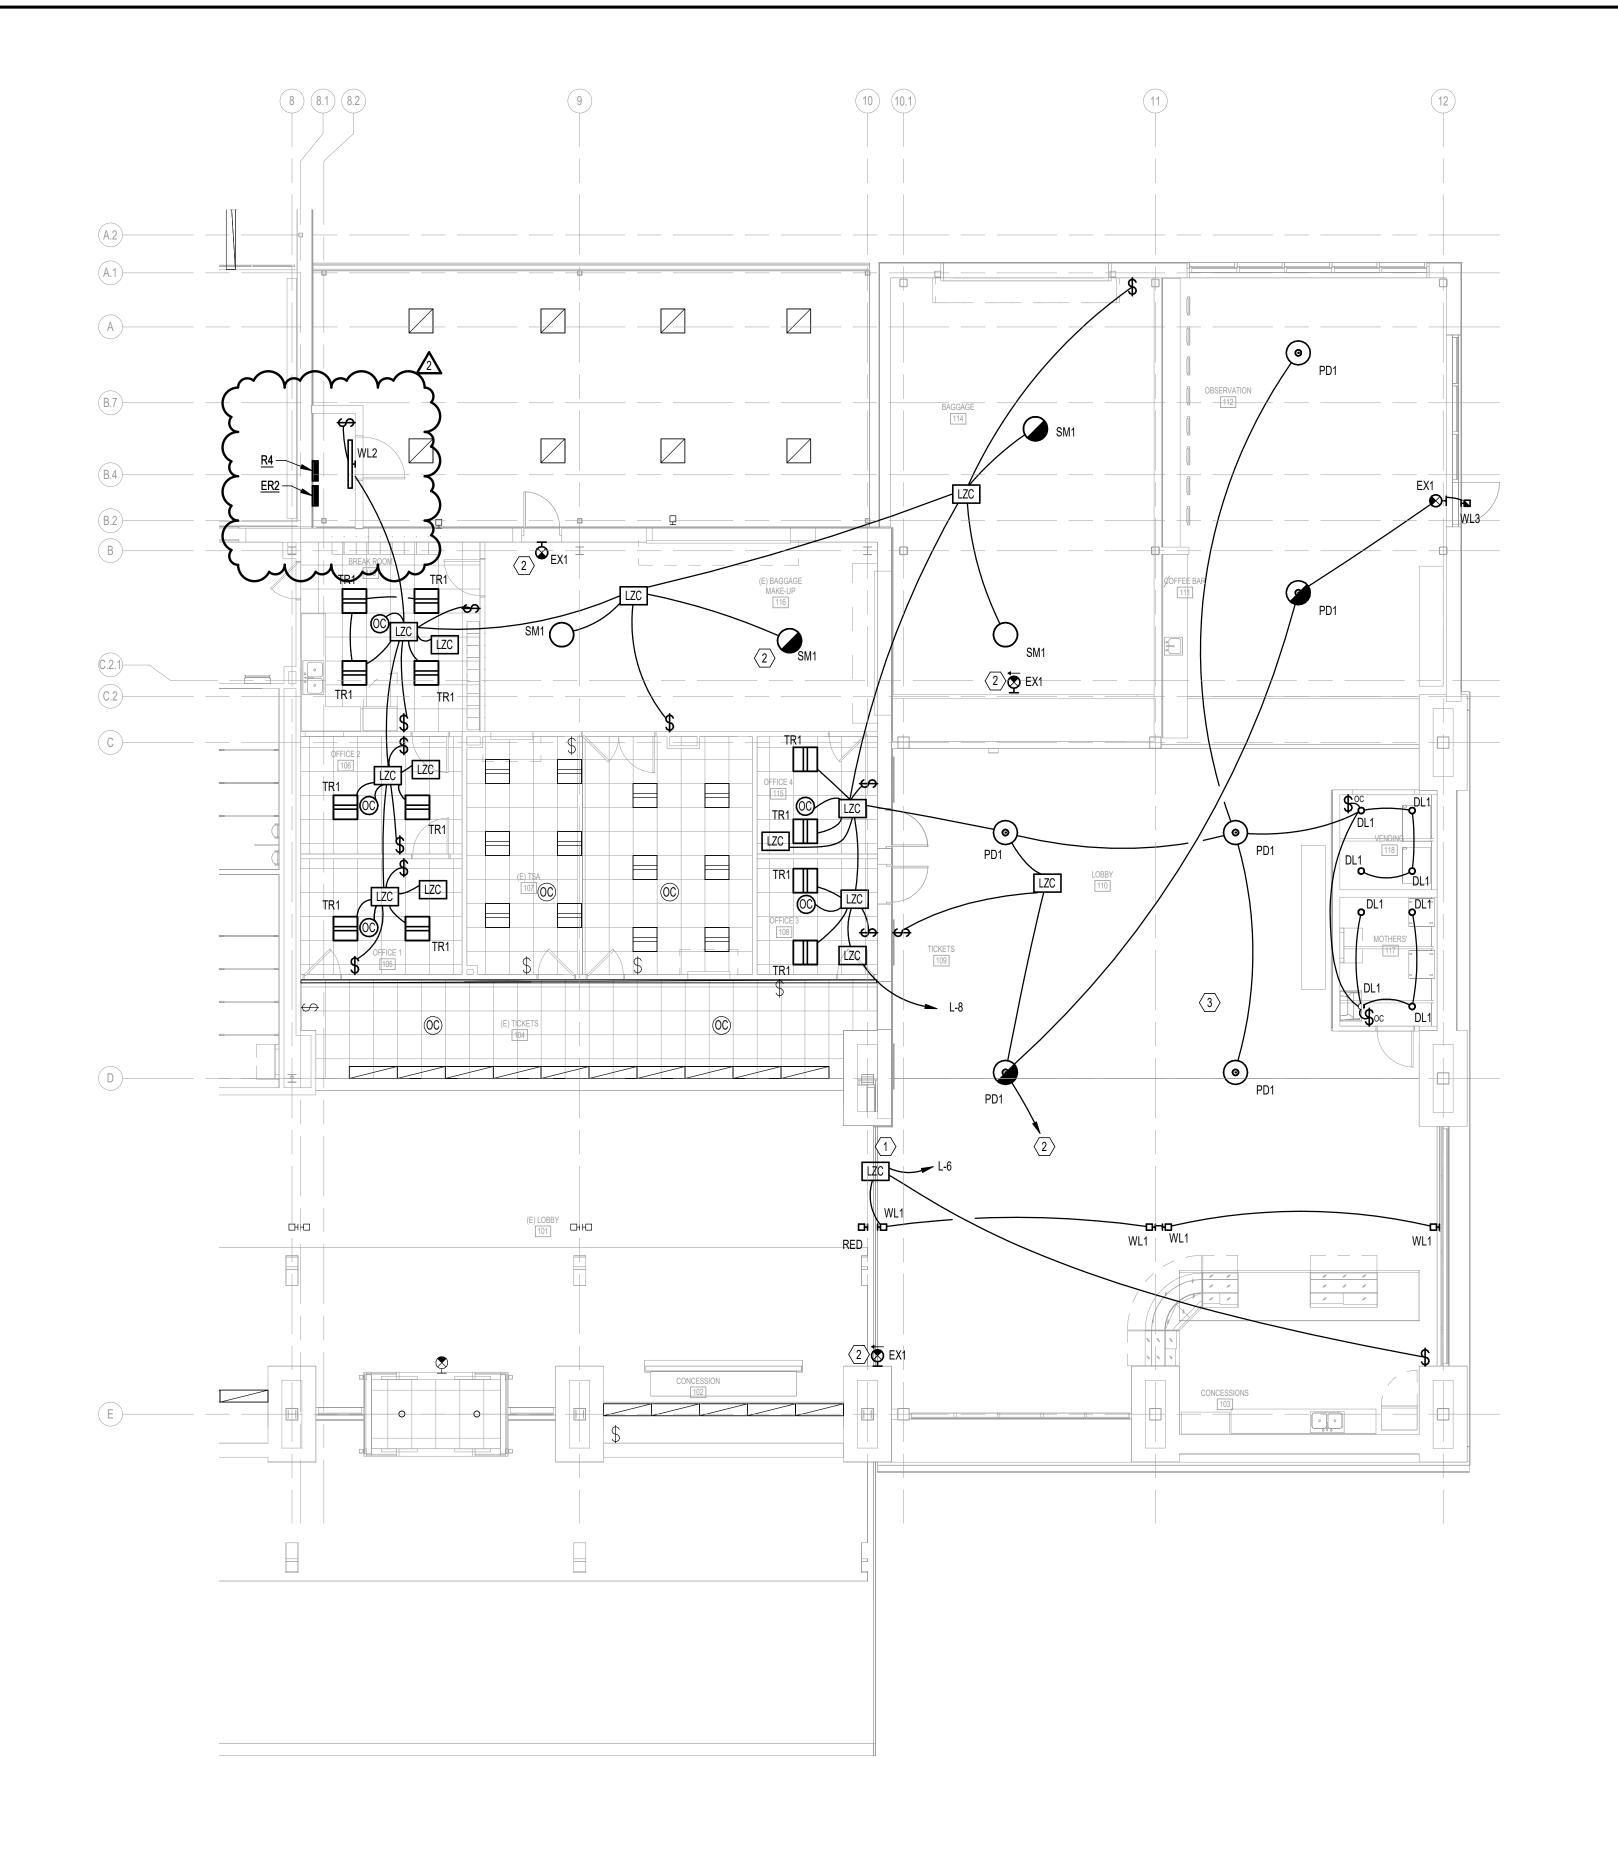




- 1. COORDINATE EXACT MOUNTING HEIGHT ABOVE FINISHED FLOOR AND LENGTH OF SUSPENSION CABLE REQUIRED WITH ARCHITECT. COORDINATE FINAL LOCATION WITH ARCHITECT PRIOR TO ROUGH IN. PROVIDE AND MOUNT TO A SWIVEL
- COORDINATE EXACT HEIGHT, LOCATION AND FINISH OF ALL FIXTURES WITH ARCHITECT PRIOR TO ROUGH IN.
- 3. LOBBY LIGHTING TO BE CONTROLLED BY EXISTING LMZC-301 ZONE CONTROLLER.
- 4. ALL EXIT SIGNS MUST BE CONNECTED TO NORMAL/EMERGENCY POWER CIRCUIT AHEAD OF SWITCHING AND LIGHTING CONTROL PANELS.

# NUMBERED NOTES

- $\langle 1 \rangle$  CONNECT TO EXISTING TIME CLOCK.
- (2) CONNECT TO EXISTING EMERGENCY LIGHTING CIRCUIT IN PANEL ER.
- ALL WIRING WITHIN THIS AREA WHERE METAL CEILING DECKING IS USED SHALL BE MC CABLE CONCEALED WITHIN DECKING SYSTEM TO THE LIGHT FIXTURE. COORDINATE WHERE ACCESS PANELS WILL BE REQUIRED AT FIXTURE LOCATIONS WITH THE GC. RUN CONDUIT ALONG THE PURLIN TO FEED THE ACCESS

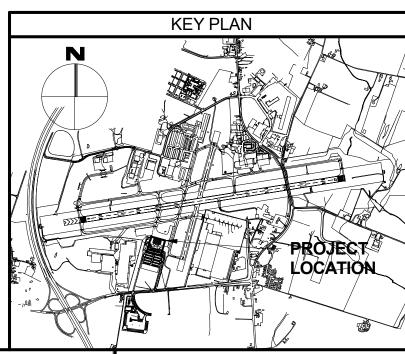





6011 UNIVERSITY BLVD.

**BUSHEY FEIGHT MORIN ARCHITECTS** 

473 NORTH POTOMAC STREET



rofessional Certification: hereby certify that these documents were prepared or approved by me, and that I am a duly licensed professional engineer under the laws of the State of Maryland. License No. <u>45511</u>

Expiration Date: <u>06/03/2026</u>

nts	DESIGNED:	NAD	No. 2	DATE 06-18-2025	DESCRIPTION ADDENDUM 4
ws	DRAWN:	NAD			
0	CHECKED:	ALD			
	APPROVED:	СРМ			

\ ENLARGED FIRST FLOOR PLAN - LIGHTING

E2-1 1/8" = 1'-0"



# **HAGERSTOWN REGIONAL AIRPORT** Washington County, MD

SHEET TITLE:	
	FIRST FLOOR PLAN - LIGHTING
SCALE:	DATE:


As indicated

TERMINAL BUILDING EXPANSION

MAY 2025

FAA AIP No.: 3-24-0019-XX-2025 Bid No.: PUR-1751 MAA Grant No.: MAA-GR-XX-XXX **BID SET** SHEET No.:

**E2-1** 96 OF 102

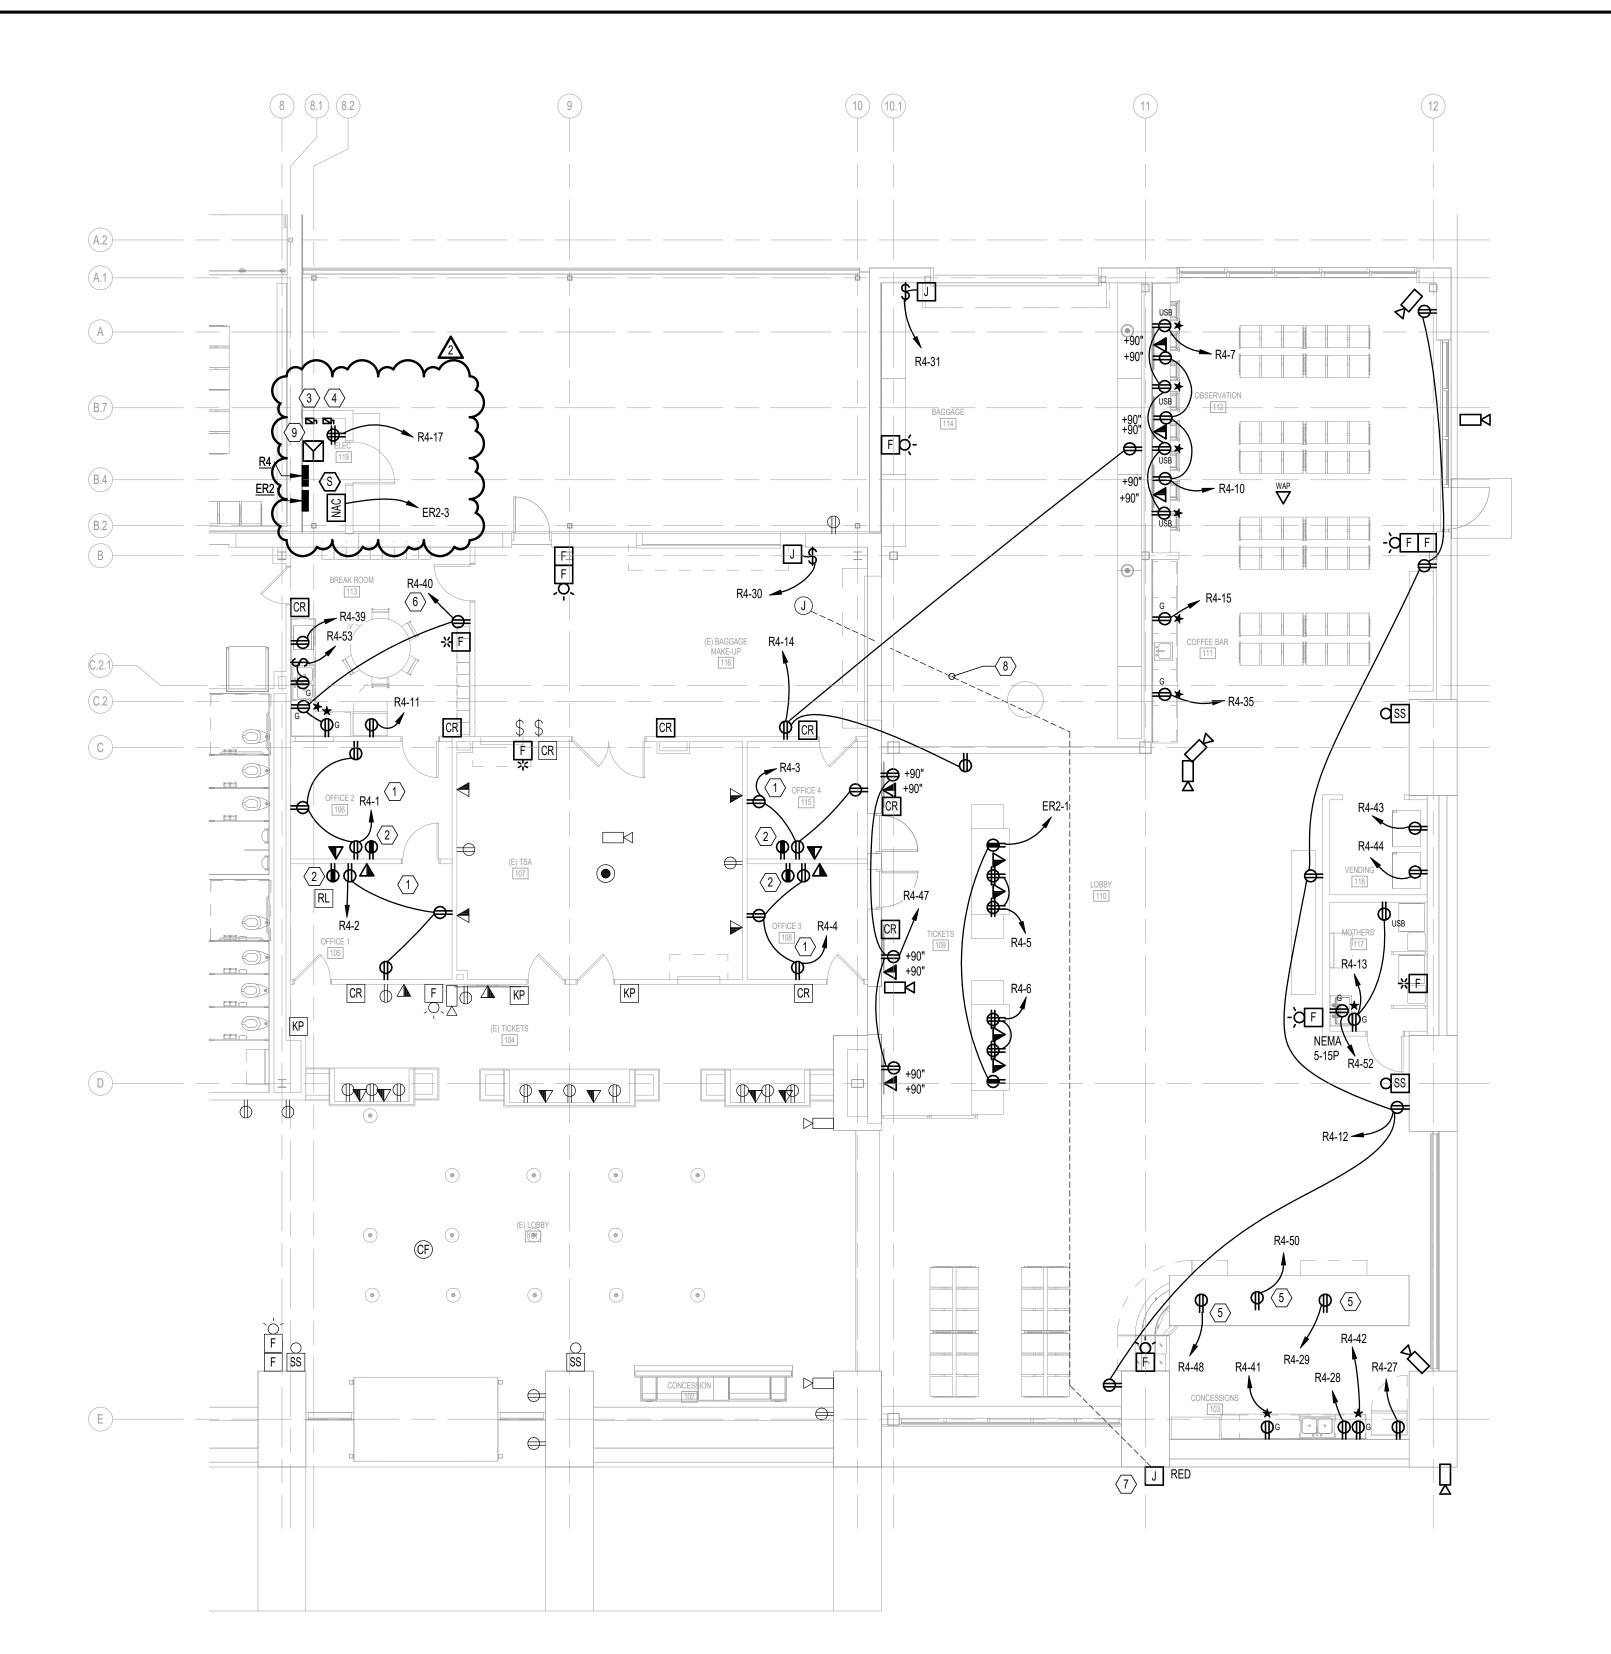


# **GENERAL NOTES**

- 1. ALL RECEPTACLES SHALL BE TAMPER RESISTANT UNLESS OTHERWISE NOTED.
- 2. SECURITY CAMERAS BY OTHERS. COORDINATE WITH ARCHITECT PRIOR TO ROUGH IN. COORDINATE EXACT MODEL NUMBERS WITH HGR SECURITY TEAM.
- 3. ALL VISUAL, AUDIO, AND AUDIO/VISUAL DEVICES MUST BE SYNCHRONIZED.

# NUMBERED NOTES

- The receptacles in Room shall be split controlled by occupancy sensor in space. Receptacle shall be labeled as such.
- (2) EMERGENCY RECEPTACLE SHALL NOT BE SPLIT CONTROLLED AND WILL BE ON PANEL ER2-2.
- 3 30A, 208V, 3P, NEMA 1, FUSED DISCONNECT, FUSED AT 30A.
- $\boxed{4}$  100A, 208V, 3P, NEMA 1, FUSED DISCONNECT, FUSED AT 70A.
- 5 RUN CONDUIT ALONG CASEWORK TO NEAREST FULL HEIGHT
- 6 RECEPTACLES ON GENERAL PURPOSE CIRCUIT WITHIN ROOM SHALL BE SPLIT CONTROLLED BY OCCUPANCY SENSOR IN
- RELOCATE JUNCTION BOX FOR EXISTING FIBER LINE TO ACCESS GATE. RELOCATE UNDERGROUND 2" SCHEDULE 80
  PVC CONDUIT FROM NEW JUNCTION BOX TO GATE LOCATION AS REQUIRED, MATCH EXISTING CONDITIONS. COORDINATE ALL WORK WITH CONCURRENT GATE RELOCATION PROJECT.
- (8) EXTEND EXISTING 2" CONDUITS AS REQUIRED FOR RELOCATED FIBER CABLING TO EXTERIOR GATE.
- $\left< 9 \right>$  15KVA TRANSFORMER STACKED OVER 45KVA TRANSFORMER.

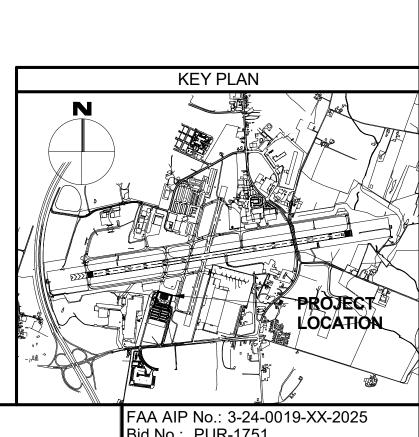





6011 UNIVERSITY BLVD. SUITE 490 ELLICOTT CITY, MD 21043 PHONE: 410-465-9600 **BUSHEY FEIGHT MORIN ARCHITECTS** 

473 NORTH POTOMAC STREET

HAGERSTOWN, MD 21740

Expiration Date: <u>06/03/2026</u>

rofessional Certification: hereby certify that these documents were prepared or approved by me, and that I am a duly licensed professional engineer under the laws of the State of Maryland. License No. <u>45511</u>

	DESIGNED:	NAD	<b>N</b> o.	DATE 06-12-2025	DESCRIPTION ADDENDUM 2
nts ,	DRAWN:	NAD	2	06-18-2025	ADDENDUM 4
WS	CHECKED:	ALD			
	APPROVED:	СРМ			
	APPROVED.	OI W			

\ ENLARGED FIRST FLOOR PLAN - POWER & DATA


HGR	HAGERSTOWN REGIONAL AIRPORT Washington County, MD
	wasnington County, MD

ROJECT TITLE:	TERMINAL BUILDING EXPANSION	
HEET TITLE:		
	FIRST FLOOR PLAN - POWER & DATA	

As indicated

MAY 2025

MAA Grant No.: MAA-GR-XX-XXX
SUBMISSION: BID SET
SHEET No.: E3-1
97 of 102

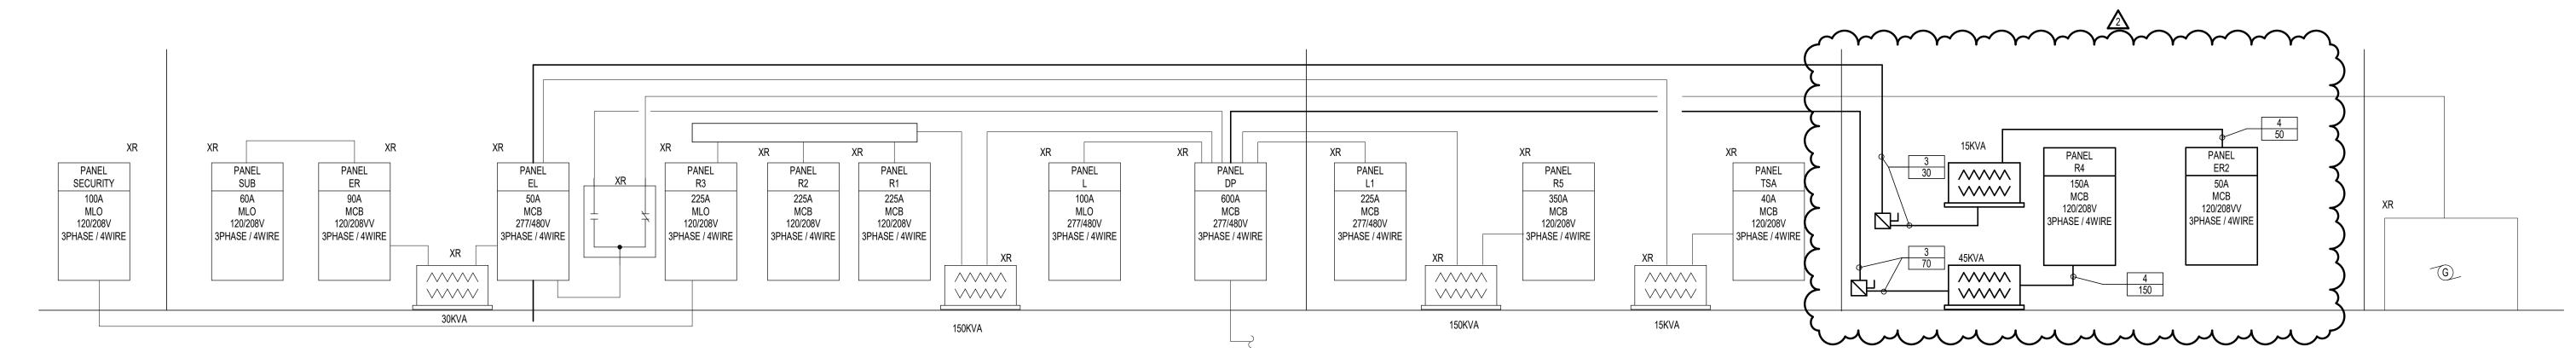

FEEDER TAG KEY

NUMBER OF WIRES

WIRE AMPS

0100

NEW RISER DIAGRAM E6-1 NO SCALE

> BRANCH CIRCUIT & FEEDER SCHEDULE - COPPER CONDUCTORS UPDATED 01-01-2013 NOTE: THIS TABLE IS FOR FEEDERS AND BRANCH CIRCUITS. IT IS NOT TO BE USED FOR SERVICE ENTRANCE, MOTORS, COPPER CONDUCTOR; THHN / THWN INSULATION, 600 V OR TRANSFORMERS. USE FOR ALL METAL CONDUITS & PVC - 40 & PVC - 80

SERVICE OCP RATING (AMPS)	TYPE 2 (1 PHASE- 2W)	TYPE 3 (1 PHASE - 3W ; 3 PHASE - 3W)	TYPE 4 (3 PHASE - 4W)
20	2 #12, 1 #12 GND - 3/4"C	3 #12, 1 #12 GND - 3/4"C	4 #12, 1 #12 GND - 3/4"C
25	2 #10, 1 #10 GND - 3/4"C	3 #10, 1 #10 GND - 3/4"C	4 #10, 1 #10 GND - 3/4"C
30	2 #10, 1 #10 GND - 3/4"C	3 #10, 1 #10 GND - 3/4"C	4 #10, 1 #10 GND - 3/4"C
35	2 #8, 1 #10 GND - 3/4"C	3 #8, 1 #10 GND - 3/4"C	4 #8, 1 #10 GND - 1"C
40	2 #8, 1 #10 GND - 3/4"C	3 #8, 1 #10 GND - 3/4"C	4 #8, 1 #10 GND - 1"C
45	2 #6, 1 #10 GND - 3/4"C	3 #6, 1 #10 GND - 1"C	4 #6, 1 #10 GND - 1"C
50	2 #6, 1 #10 GND - 3/4"C	3 #6, 1 #10 GND - 1"C	4 #6, 1 #10 GND - 1"C
60	2 #4, 1 #10 GND - 3/4"C	3 #4, 1 #10 GND - 1"C	4 #4, 1 #10 GND - 1 1/4"C
70	2 #4, 1 #8 GND - 1"C	3 #4, 1 #8 GND - 1"C	4 #4, 1 #8 GND - 1 1/4"C
80	2 #3, 1 #8 GND - 1"C	3 #3, 1 #8 GND - 1 1/4"C	4 #3, 1 #8 GND - 1 1/4"C
90	2 #2, 1 #8 GND - 1"C	3 #2, 1 #8 GND - 1 1/4"C	4 #2, 1 #8 GND - 1 1/2"C
100	2 #1, 1 #8 GND - 1 1/4"C	3 #1, 1 #8 GND - 1 1/4"C	4 #1, 1 #8 GND - 1 1/2"C
110	2 #1, 1 #6 GND - 1 1/4"C	3 #1, 1 #6 GND - 1 1/4"C	4 #1, 1 #6 GND - 1 1/2"C
125	2 #1, 1 #6 GND - 1 1/4"C	3 #1, 1 #6 GND - 1 1/4"C	4 #1, 1 #6 GND - 1 1/2"C
150	2 #1/0, 1 #6 GND - 1 1/4"C	3 #1/0, 1 #6 GND - 1 1/2"C	4 #1/0, 1 #6 GND - 2"C
175	2 #2/0, 1 #6 GND - 1 1/2"C	3 #2/0, 1 #6 GND - 2"C	4 #2/0, 1 #6 GND - 2"C
200	2 #3/0, 1 #6 GND - 1 1/2"C	3 #3/0, 1 #6 GND - 2"C	4 #3/0, 1 #6 GND - 2"C
225	2 #4/0, 1 #4 GND - 2"C	3 #4/0, 1 #4 GND - 2"C	4 #4/0, 1 #4 GND - 2 1/2"C
250	2-250 KCMIL, 1 #4 GND - 2"C	3-250 KCMIL, 1 #4 GND - 2 1/2"C	4-250 KCMIL, 1 #4 GND - 2 1/2"C
300	2-350 KCMIL, 1 #4 GND - 2 1/2"C	3-350 KCMIL, 1 #4 GND - 3"C	4-350 KCMIL, 1 #4 GND - 3"C
350	2-500 KCMIL, 1 #3 GND - 3"C	3-500 KCMIL, 1 #3 GND - 3"C	4-500 KCMIL, 1 #3 GND - 3 1/2"C
400	2-600 KCMIL, 1 #3 GND - 3"C	3-600 KCMIL, 1 #3 GND - 3"C	4-600 KCMIL, 1 #3 GND - 4"C
450	2 SETS EACH: 2 #4/0, 1 #2 GND - 2"C	2 SETS EACH: 3 #4/0, 1 #2 GND - 2"C	2 SETS EACH: 4 #4/0, 1 #2 GND - 2 1/2"C
500	2 SETS EACH: 2-250 KCMIL, 1 #2 GND - 2"C	2 SETS EACH: 3-250 KCMIL, 1 #2 GND - 2 1/2"C	2 SETS EACH: 4-250 KCMIL, 1 #2 GND - 2 1/2"C
600	2 SETS EACH: 2-350 KCMIL, 1 #1 GND - 3"C	2 SETS EACH: 3-350 KCMIL, 1 #1 GND - 3"C	2 SETS EACH: 4-350 KCMIL, 1 #1 GND - 3 1/2"C
700	2 SETS EACH: 2-500 KCMIL, 1 #1/0 GND - 3"C	2 SETS EACH: 3-500 KCMIL, 1 #1/0 GND - 3"C	2 SETS EACH: 4-500 KCMIL, 1 #1/0 GND - 3 1/2"C
800	2 SETS EACH: 2-600 KCMIL, 1 #1/0 GND - 3"C	2 SETS EACH: 3-600 KCMIL, 1 #1/0 GND - 3 1/2"C	2 SETS EACH: 4-600 KCMIL, 1 #1/0 GND - 4"C
1000	3 SETS EACH: 2-500 KCMIL, 1 #2/0 GND - 3"C	3 SETS EACH: 3-500 KCMIL, 1 #2/0 GND - 3"C	3 SETS EACH: 4-500 KCMIL, 1 #2/0 GND - 3 1/2"C
1200	3 SETS EACH: 2-600 KCMIL, 1 #3/0 GND - 3"C	3 SETS EACH: 3-600 KCMIL, 1 #3/0 GND - 3 1/2"C	3 SETS EACH: 4-600 KCMIL, 1 #3/0 GND - 4"C
1600	4 SETS EACH: 2-600 KCMIL, 1 #4/0 GND - 3"C	4 SETS EACH: 3-600 KCMIL, 1 #4/0 GND - 3 1/2"C	4 SETS EACH: 4-600 KCMIL, 1 #4/0 GND - 4"C
2000	5 SETS EACH: 2-600 KCMIL, 1-250 KCMIL GND - 3"C	5 SETS EACH: 3-600 KCMIL, 1-250 KCMIL GND - 3 1/2"C	5 SETS EACH: 4-600 KCMIL, 1-250 KCMIL GND - 4"C
2500	6 SETS EACH: 2-600 KCMIL, 1-350 KCMIL GND - 3"C	6 SETS EACH: 3-600 KCMIL, 1-350 KCMIL GND - 3 1/2"C	6 SETS EACH: 4-600 KCMIL, 1-350 KCMIL GND - 4"C
3000	8 SETS EACH: 2-500 KCMIL, 1-500 KCMIL GND - 3"C	8 SETS EACH: 3-500 KCMIL, 1-500 KCMIL GND - 3"C	8 SETS EACH: 4-500 KCMIL, 1-500 KCMIL GND - 4"C
3500	9 SETS EACH: 2-600 KCMIL, 1-500 KCMIL GND - 3"C	9 SETS EACH: 3-600 KCMIL, 1-500 KCMIL GND - 3 1/2"C	9 SETS EACH: 4-600 KCMIL, 1-500 KCMIL GND - 4"C
4000	10 SETS EACH: 2-600 KCMIL, 1-500 KCMIL GND - 3"C	10 SETS EACH: 3-600 KCMIL, 1-500 KCMIL GND - 3 1/2"C	10 SETS EACH: 4-600 KCMIL, 1-500 KCMIL GND - 4"C

NOTE: FOR CABLE INSULATION OTHER THAN THHN / THWN, SIZE CONDUIT PER NEC.

BRANCH CIRCUIT & FEEDER SCHEDULE - COPPER CONDUCTORS

NO SCALE

ENGINEERING
5285 Westview Drive
Suite 203
Frederick, MD 21703
D 204 COE 0424






	Professional Certification:
OF MAR OPHER D	I hereby certify that these do were prepared or approved and that I am a duly license professional engineer unde of the State of Maryland.
45511 C	License No. <u>45511</u>

	DESIGNED:	NAD	No.	DATE	DESCRIPTION
ments			1	06-12-2025	ADDENDUM 2
me,			2	06-18-2025	ADDENDUM 4
	DRAWN:	NAD			
e laws					
	CHECKED:	ALD			
	CHLONED.	ALD			
	APPROVED:	CPM			
	·				<u> </u>



PROJECT TITLE:  TERMINA	L BUILDING EXPANSION	FAA AIP No.: 3-24-0019-XX-2025 Bid No.: PUR-1751 MAA Grant No.: MAA-GR-XX-XXX
SHEET TITLE:		SUBMISSION: BID SET
	RISER DIAGRAMS	SHEET No.: <b>E6-1</b>
SCALE: NO SCALE	DATE: MAY 2025	100 of 102

KEY PLAN

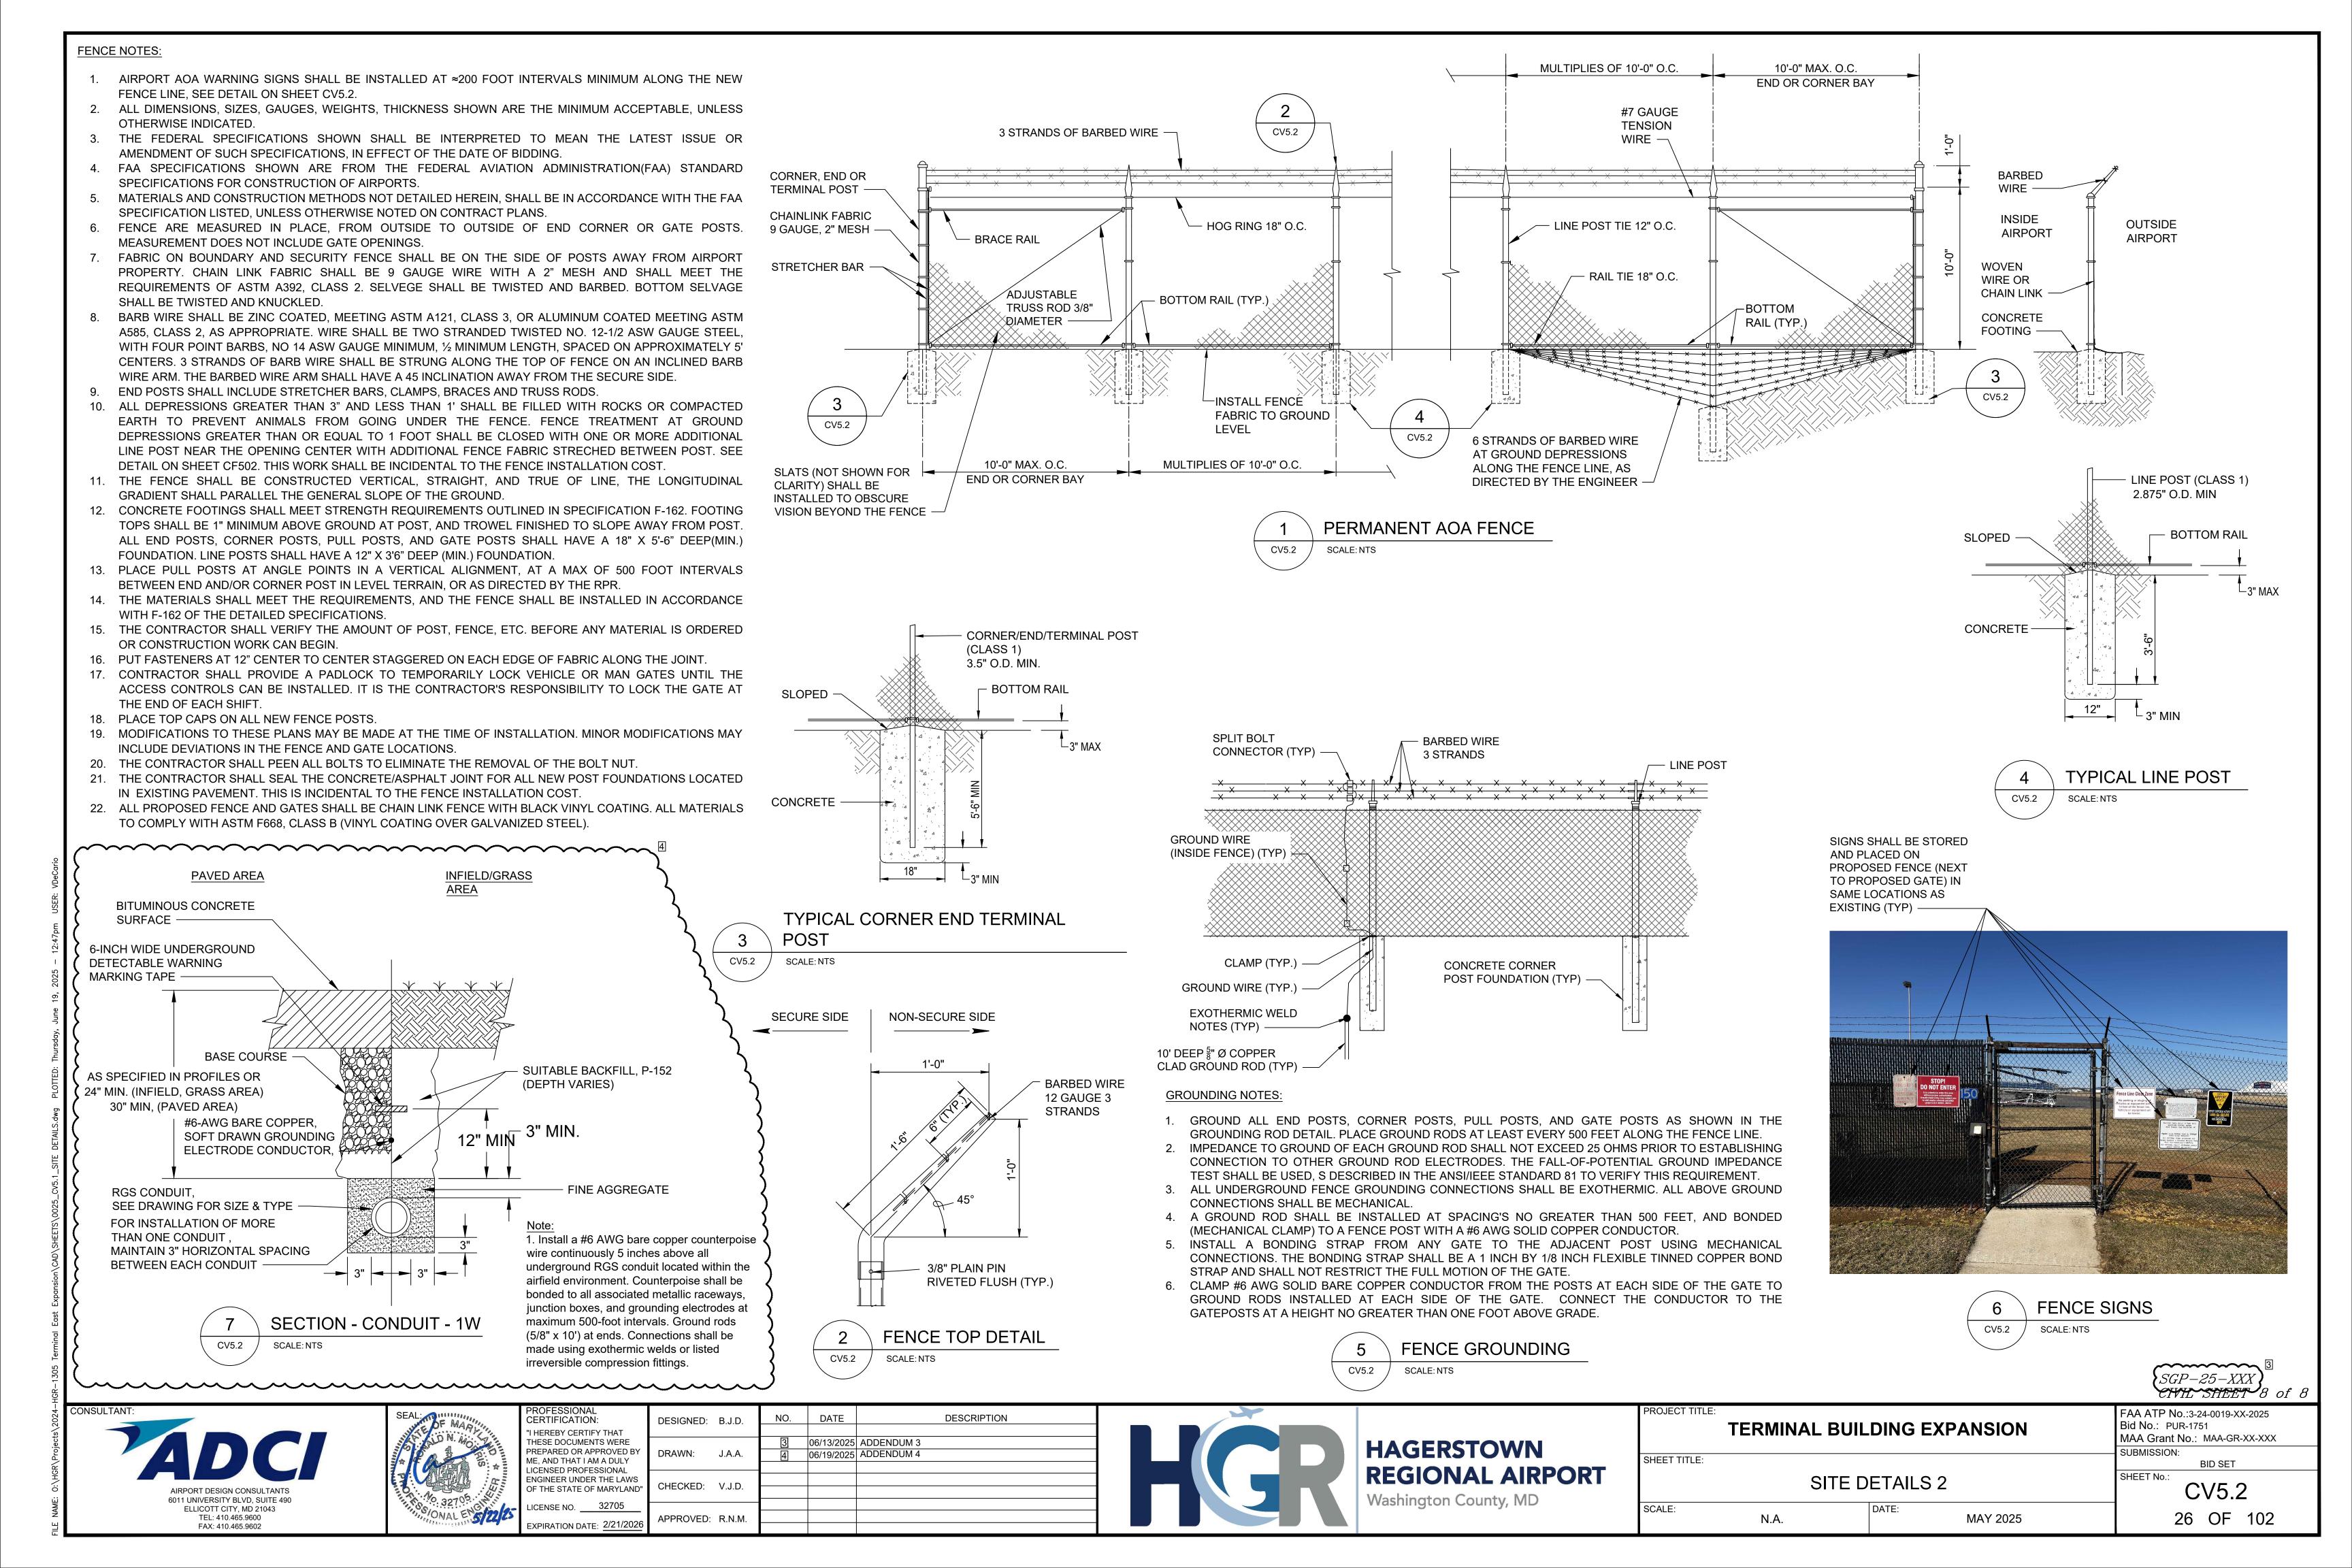

2. EXISTING UTILITY INFORMATION SHOWN HEREON IS FROM DRAWINGS AND/OR OTHER SOURCES PROVIDED BY OWNERS OF THE VARIOUS UTILITIES EXACT LOCATIONS SHALL BE DETERMINED IN THE FIELD BEFORE BEGINNING CONSTRUCTION. THE CONTRACTOR SHALL NOTIFY MISS UTILITY AT (1-800-257-7777) A MINIMUM OF 48 HOURS BEFORE BEGINNING ANY WORK SHOWN ON THESE DRAWINGS, ANY DAMAGE TO UTILITIES BY THE CONTRACTOR SHALL BE REPAIRED BY THE CONTRACTOR AT HIS EXPENSE AND TO THE SATISFACTION OF THE UTILITY OWNER. HAND PIT EXCAVATION SHALL BE PROVIDED AS NEEDED BY CONTRACTOR TO LOCATE EXISTING UNDERGROUND

THE CONTRACTOR SHALL NOTIFY THE APPLICABLE MUNICIPAL, COUNTY AND/OR STATE AUTHORITIES AT LEAST 48 HOURS BEFORE BEGINNING ANY WORK WITHIN PUBLIC RIGHT (S) OF WAY.

THE CONTRACTOR SHALL VERIFY ALL SURFACE AND SUBSURFACE CONDITIONS (LOCATIONS AND ELEVATIONS) PRIOR TO BIDDING AND START OF CONSTRUCTION. ANY DISCREPANCIES BETWEEN THE DRAWINGS AND ACTUAL FIELD CONDITIONS SHALL BE REPORTED TO THE OWNER AND/OR ENGINEER BEFORE PROCEEDING IF THEY AFFECT THE DESIGN FEASIBILITY OF THIS PROJECT. ANY DAMAGE TO FACILITIES, STRUCTURES, PAVEMENT OR OTHER MAN-MADE ITEMS ON OR ADJACENT TO THE SITE OR NOT SPECIFICALLY INDICATED FOR THE DEMOLITION SHALL BE REPAIRED OR REPLACED AT CONTRACTOR'S EXPENSE AND TO THE SATISFACTION OF THE OWNER.

THE CONTRACTOR SHALL BE RESPONSIBLE FOR OBTAINING ALL NECESSARY PERMITS AND FOR COMPLYING WITH ALL APPLICABLE LEGAL AND REGULATORY REQUIREMENTS. CONTRACTOR SHALL OBTAIN ANY BONDS REQUIRED BY COUNTY/STATE FOR WORK WITHIN COUNTY/STATE RIGHT-OF-WAYS.

TEMPORARY EROSION CONTROL MEASURES WILL BE USED TO CORRECT CONDITIONS THAT DEVELOP DURING CONSTRUCTION THAT ARE UNFORESEEN DURING THE DESIGN STAGE OR THAT ARE NEEDED TO TEMPORARILY CONTROL EROSION THAT DEVELOPS DURING NORMAL CONSTRUCTION PRACTICES.

ADCI WILL NOT BE RESPONSIBLE FOR ANYTHING TO DO WITH CONSTRUCTION UNLESS CONTRACTED BY THE OWNER OR CONTRACTOR TO PERFORM A

8. JOB SITE SAFETY SHALL BE THE SOLE RESPONSIBILITY OF THE CONTRACTOR.

EXISTING UTILITIES SHOWN HEREON ARE FOR INFORMATIONAL PURPOSES ONLY. EXACT LOCATIONS SHALL BE DETERMINED IN THE FIELD BEFORE BEGINNING

TO US BY OTHERS. PROPERTY LINE INFORMATION HAS BEEN TAKEN FROM DEED (S) OF RECORD AND NOT FIELD VERIFIED. 11. SITE CONTRACTOR MAY HAVE TO MODIFY FINISH GRADES SHOWN NEXT TO

10. NO TITLE REPORT HAS BEEN CONDUCTED BY THIS COMPANY OR FURNISHED

BUILDINGS DUE TO TYPE OF WALL CONSTRUCTION PROVIDED. GENERALLY A MINIMUM FINISH GRADE 6 INCHES BELOW FINISH FLOOR FOR MASONRY CONSTRUCTION AND 12 INCHES BELOW FINISH FLOOR FOR WOOD\SIDING CONSTRUCTION SHOULD BE MAINTAINED. CONTRACTOR MUST PROVIDE POSITIVE SURFACE DRAINAGE AWAY FROM ALL UNITS.

12. ALL GRADING FOR THIS PROJECT SHALL BE THE FULL RESPONSIBILITY OF THE

13. ALL PROPOSED STORM DRAIN PIPES MUST BE PLACED ON 95% COMPACTED FILL ACCORDING TO AASHTO T180A STANDARDS.

14. PARKING AND DRIVE AISLES SHALL BE MAINTAINED BY PROPERTY OWNER.

15. NO PERMANENT STRUCTURES (E.G. FENCES, SHEDS, PLAY EQUIPMENT RETAINING WALLS) SHALL BE PERMITTED WITHIN ANY STORMWATER OR STORM DRAINAGE EASEMENT ON THIS PROPERTY.

16. THERE IS NO 100 YEAR FLOODPLAIN ON THIS SUBJECT PROJECT AREA AS SHOWN ON FEMA PANEL No. 240070128D EFFECTIVE DATE AUGUST 15, 2017.

17. THERE ARE NO KNOWN HABITATS OF THREATENED OR ENDANGERED SPECIES IDENTIFIED BY THE U.S. FISH AND WILDLIFE SERVICE PER 50 CFR AS REQUIRED TO BE SHOWN BY SECTION 314 OF THE SUBDIVISION ORDINANCE AND SECTION 4.21 OF THE ZONING ORDINANCE.

THERE ARE NO AREAS OF STEEP SLOPES AS DEFINED BY THE WASHINGTON COUNTY SOIL CONSERVATION DISTRICT PER ARTICLE 28.631 ON THE LANDS SHOWN HEREON. THERE ARE NO WETLANDS ON THIS SITE PER MAPPING BY THE U.S. DEPARTMENT OF THE INTERIOR, FISH AND WILDLIFE SERVICE.

19. A COMPLETE SET OF APPROVED PLANS AND A COPY OF THE THE GRADING PERMIT MUST BE ON SITE AND AVAILABLE FOR USE BY THE INSPECTOR, OR OTHER REPRESENTATIVES OF WASHINGTON COUNTY PUBLIC WORKS.


20. A PRE-CONSTRUCTION MEETING SHALL BE HELD FOR ALL PROJECTS REGARDLESS OF THE AMOUNT OF DISTURBANCE. CONTACT THE WASHINGTON COUNTY DIVISION OF PUBLIC WORKS — ENGINEERING & CONSTRUCTION AT 240-313-2400 FIVE (5) DAYS PRIOR TO THE START OF CONSTRUCTION.

21. THERE ARE NO KNOWN FOREST CONSERVATION AREAS OR WETLANDS WITHIN 200 ft. OF THE PROPOSED CONSTRUCTION AREA.

# SITE PLAN

# HAGERSTOWN REGIONAL AIRPORT TERMINAL EXPANSION

SITUATE AT 18434 SHOWALTER ROAD, HAGERSTOWN, MD 21742 **ELECTION DISTRICT 13** WASHINGTON COUNTY, MARYLAND

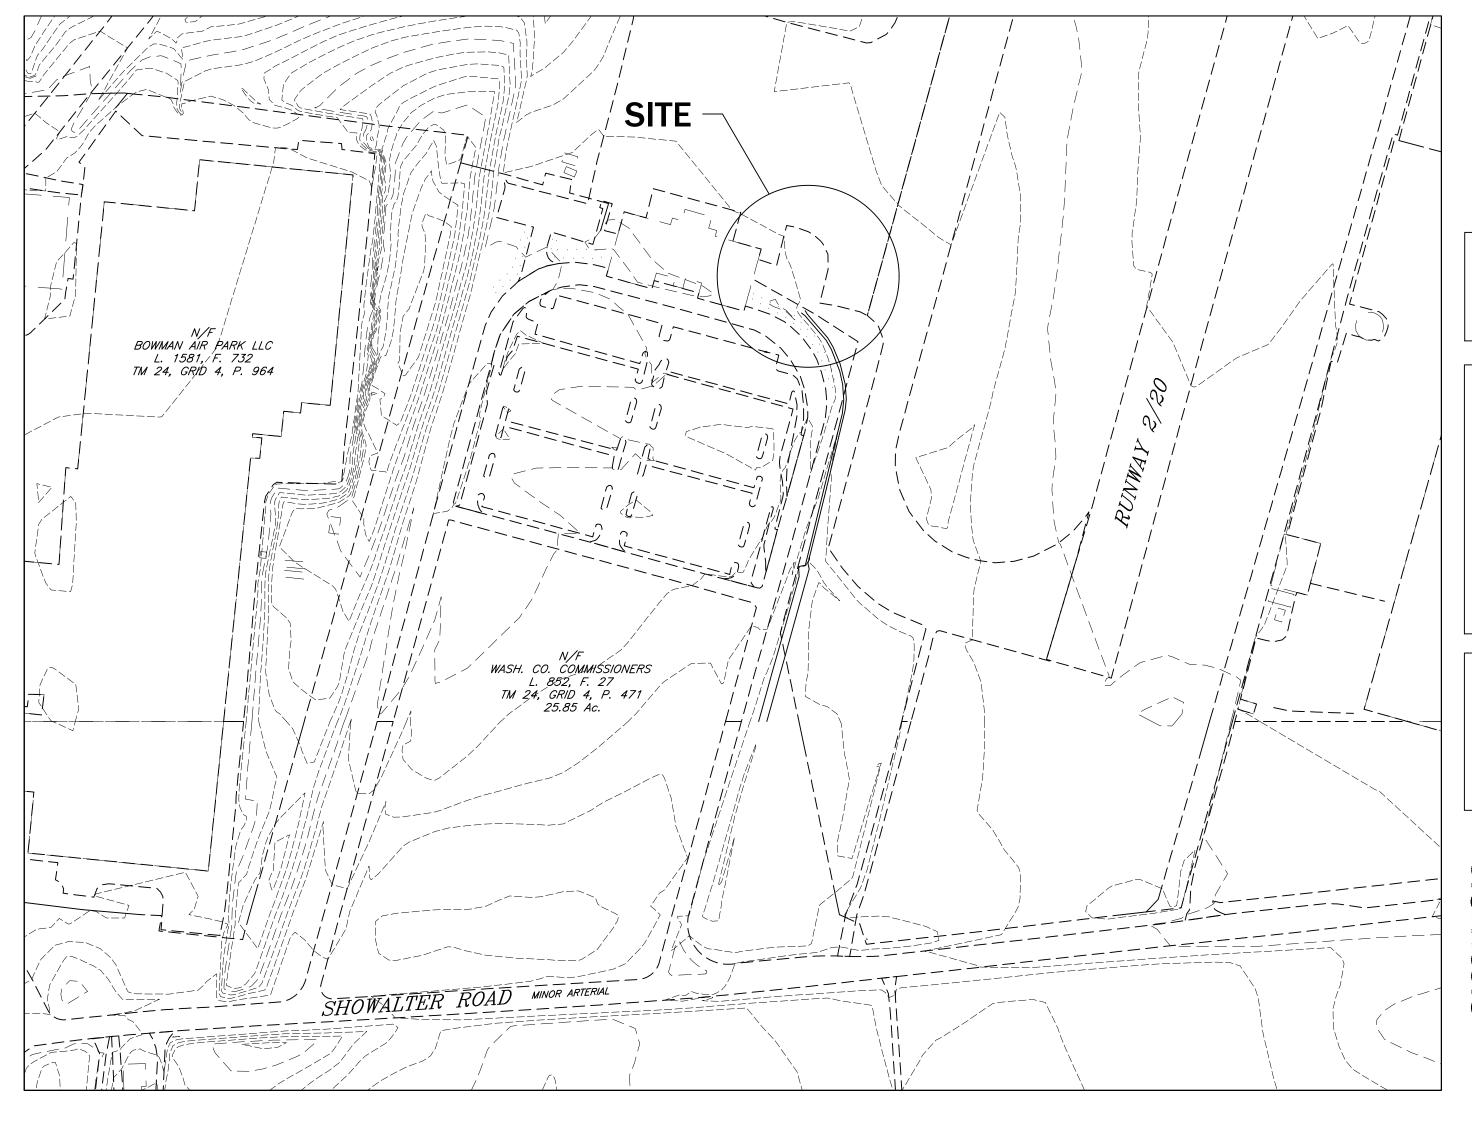

GRAPHIC SCALE

1 inch = 150 ft

OWNER / DEVELOPER

WASHINGTON COUNTY COMMISSIONERS 100 WEST WASHINGTON STREET

HAGERSTOWN, MD 21740

240-313-2200

APPROVED: DISTURBED AREA QUANTITIES WASHINGTON COUNTY DIVISION OF PLAN REVIEW & PERMITTING THE TOTAL AREA TO BE DISTURBED SPOUNT ON THESE PLANS HAS BEEN DETERMINED TO BE APPROXIMATELY 25,688 SF/ 0.59 ACRES AND THE TOTAL AMOUNT OF EXCAVATION AND THE AS SHOWN ON THESE PLANS HAS BEEN COMPUTED TO BE APPROXIMATELY

### WASHINGTON COUNTY DEPARTMENT OF WATER QUALITY

THIS APPROVAL IS FOR GENERAL CONFORMANCE WITH THE COUNTY'S REQUIREMENTS FOR DESIGN AND LAYOUT OF PROPOSED SEWER AND/OR WATER SYSTEM IMPROVEMENTS OR EXTENSIONS. ALL SEWER AND/OR WATER SYSTEM IMPROVEMENTS OR EXTENSIONS SHALL BE CONSTRUCTED IN STRICT ACCORDANCE WITH THE COUNTY'S LATEST EDITION OF THE STANDARD SPECIFICATIONS FOR CONSTRUCTION OF SANITARY SEWERS AND/OR WATER LINES. THIS APPROVAL DOES NOT GUARANTEE AVAILABILITY OF SEWER AND/OR WATER SERVICE. SFWFR AND/OR WATER SERVICE AVAILABILITY IS SUBJECT TO CONFORMANCE WITH ALL RULES, POLICIES, AND REGULATIONS ESTABLISHED BY THE COUNTY AND IN EFFECT AT THE TIME APPLICATION FOR SERVICE IS MADE, AND/OR THE AVAILABILITY OF ALLOCATION REMAINING IN OTHER JURISDICTIONS' FACILITIES THAT MAY BE GRANTED TO THE COUNTY. THIS APPROVAL SHALL BE VALID FOR A PERIOD OF <u>TWO</u> YEARS.

THIS PLAN/PLAT HAS BEEN REVIEWED BY THE WASHINGTON COUNTY DEPARTMENT OF WATER QUALITY FOR INCLUSION INTO THE COUNTY CAPACITY MANAGEMENT PLAN FOR THE SYSTEM THAT SERVES THIS PROJECT. ALLOCATION GRANTED FOR CONSTRUCTION SHOWN ON THIS PLAN/PLAT SHALL BE IN ACCORDANCE WITH THE CAPACITY MANAGEMENT PLAN DEVELOPED FOR THIS SYSTEM BASED ON AVAILABILITY OF ALLOCATION REMAINING IN THE FACILITY.

WASHINGTON COUNTY DEPARTMENT OF WATER QUALITY

**Atttachment C** 

# STORMWATER MANAGEMENT NARRATIVE

INDEX OF SHEETS

FINAL CONDITIONS PLAN.

SITE DETAILS 1 SITE DETAILS 2

EXISTING CONDITIONS PLAN/DEMOLITION PLAN.

COVER SHEET, GENERAL CONSTRUCTION and SAFETY NOTES.

GRADING/SEDIMENT CONTROL PLAN, BORING PLAN and BORING LOG

DRAINAGE and EROSION/SEDIMENT CONTROL NOTES and DETAILS.

SCALE:

STORMWATER MANAGEMENT FACILITIES. THESE PONDS WERE DESIGNED AND CONSTRUCTED TO PROVIDE QUANTITY AND QUALITY CONTROLS FOR ALL EXISTING AND FUTURE DEVELOPMENT AT HGR PER THE AIRPORT LAYOUT PLAN (ALP). SINCE THESE PONDS ARE EXISTING, PROJECTS INCLUDED ARE GRANDFATHERED UNDER THE REGULATIONS IN FORCE AT THIS TIME RUNOFF FROM THIS PROJECT DRAINS UNDER US11 INTO HGR REGIONAL POND BMP 3, LOCATED SOUTHEAST OF THE INTERSECTION OF US 11 AND AIR VIEW ROAD. THIS PROJECT INCREASES THE IMPERVIOUS AREA IN THAT WATERSHED BY 0.11 ACRES BUT WILL BE COVERED BY AVAILABLE CREDITS(5.04 ACRES).

·····

THE HAGERSTOWN REGIONAL AIRPORT (HGR) HAS TWO REGIONAL

OWNER/DEVELOPERS CERTIFICATION FOR CO. DPW

RICHARD A HENSON

WASHINGTON/COUNTY

SCALE: 1" = 2000'

COPYRIGHT ADC THE MAP PEOPLE PERMIT USE NUMBER 21004221

PARCEL 471

(240) 313-2400

(301) 739-8577 X 653 (301) 582-5271

(301) 797–6821 X 3 (301) 797–1835 (301) 790–7135

TAX MAP 24

ED NORMAN

RICK USARY

DENISE PRICE

KEN BUCKLER

JULIE LUDWIG

AGENCY & UTILITY CONTACTS

THE SOIL CONSERVATION DISTRICT MAKES NO REPRESENTATION AS TO THE EXISTENCE OR

CONSTRUCTION DRAWINGS ARE THOSE UTILITIES WHICH HAVE BEEN IDENTIFIED. IT IS THE RESPONSIBILITY OF THE LANDOWNERS OR OPERATORS AND CONTRACTORS TO ASSURE THEMSELVES THAT NO HAZARD EXISTS OR DAMAGE WILL OCCUR TO UTILITIES. IT IS REQUIRED

\* THESE QUANTITIES ARE APPROXIMATE AND SHALL NOT BE USED BY THE CONTRACTOR

ENGINEER PROFESSIONAL CERTIFICATION

ENGINEER/ARCHITECT DESIGN CERTIFICATION

HEREBY CERTIFY THIS PLAN FOR SOIL EROSION AND SEDIMENT CONTROL HAS BEEN

DESIGNED IN ACCORDANCE WITH LOCAL ORDINANCES, COMAR 26.17.01.07, MARYLAND

STANDARDS AND SPECIFICATIONS FOR SOIL EROSION AND SEDIMENT CONTROL.

HEREBY CERTIFY THAT THESE DOCUMENTS WERE PREPARED OR APPROVED BY ME,

AND THAT I AM A DULY LICENSED PROFESSIONAL ENGINEER UNDER THE LAWS OF THE

NONEXISTENCE OF ANY UTILITIES AT THE CONSTRUCTION SITE. SHOWN ON THESE

BY LAW THAT MISS UTILITY BE CONTACTED AT: PHONE No. 1-800-257-7777.

COUNTY D.P.W. - ENGINEERING AND CONSTRUCTION

CITY UTILITIES DEPT., WATER & SEWER DIVISION

UTILITY NOTIFICATION:

STATE OF MARYLAND.

BUSINESS AIR PARK

I/WE CERTIFY THAT ALL CLEARING, GRADING, CONSTRUCTION AND/OR DEVELOPMENT WILL BE DONE PURSUANT TO THIS PLAN AND IN ACCORDANCE WITH THE STORMWATER MANAGEMENT ORDINANCE OF WASHINGTON COUNTY AND THE POLICY ON CONSTRUCTION OF SUBDIVISION INFRASTRUCTURE FOR ACCEPTANCE AND OWNERSHIP BY WASHINGTON

AIRPORT DIRECTOR

TOTAL TAX GRID INFO: 24-04-0689-00000

A. N.G.S. MONUMENT AJ7986 "MIDDLE 2"

APPROX. BOUNDARY

OF TM 24/P. 689

378 AC. ±

POTOMAC EDISON

ANTIETAM CABLE

(NAD83, NAVD 88)

N 745.943.925

E 1,109,153.128

ELEV. = 695.66'

N 744,254.673

E 1,107,883.953

ELEV. = 696.05

(NAD83, NAVD 88)

3. 550 MTS

SIGNATURE

RONALD N. MORRIS

# OWNER/DEVELOPER CERTIFICATION - SCD

I/WE CERTIFY ALL/ANY PARTIES RESPONSIBLE FOR CLEARING, GRADING, CONSTRUCTION, AND/OR DEVELOPMENT WILL; BE DONE PURSUANT TO THIS PLAN AND RESPONSIBLE PERSONNEL INVOLVED IN THE CONSTRUCTION PROJECT WILL HAVE A CERTIFICATE OF TRAINING AT A MARYLAND DEPARTMENT OF THE ENVIRONMENT APPROVED TRAINING PROGRAM FOR THE CONTROL OF SOIL EROSION AND SEDIMENT. NEIL DORAN,

AIRPORT DIRECTOR

MAY 2025

WASHINGTON COUNTY SOIL CONSERVATION DISTRICT SOIL EROSION AND SEDIMENT CONTROL PLAN APPROVAL

(PLAN IS VALID FOR TWO YEARS FROM DATE OF APPROVAL)

SGP-25-XXXCIVIL SHEET 1

SIGNATURE





**CERTIFICATION:** 

HEREBY CERTIFY THAT THESE DOCUMENTS WERE PREPARED OR APPROVED BY ME. AND THAT I AM A DULY ICENSED PROFESSIONAL **ENGINEER UNDER THE LAWS** OF THE STATE OF MARYLAND" JICENSE NO. 32705 EXPIRATION DATE: 2/21/202

DATE DESCRIPTION DESIGNED: B.J.D. 06/13/2025 ADDENDUM 3 CHECKED: V.J.D. APPROVED: R.N.M.



**HAGERSTOWN REGIONAL AIRPORT** Washington County, MD


TERMINAL BUILDING EXPANSION

COVER SHEET, GENERAL CONSTRUCTION AND SAFETY NOTES

FAA ATP No.:3-24-0019-XX-2025 Bid No.: PUR-1751 MAA Grant No.: MAA-GR-XX-XXX SUBMISSION:

> CV1.0 19 OF 102

BID SET SHEET No.:

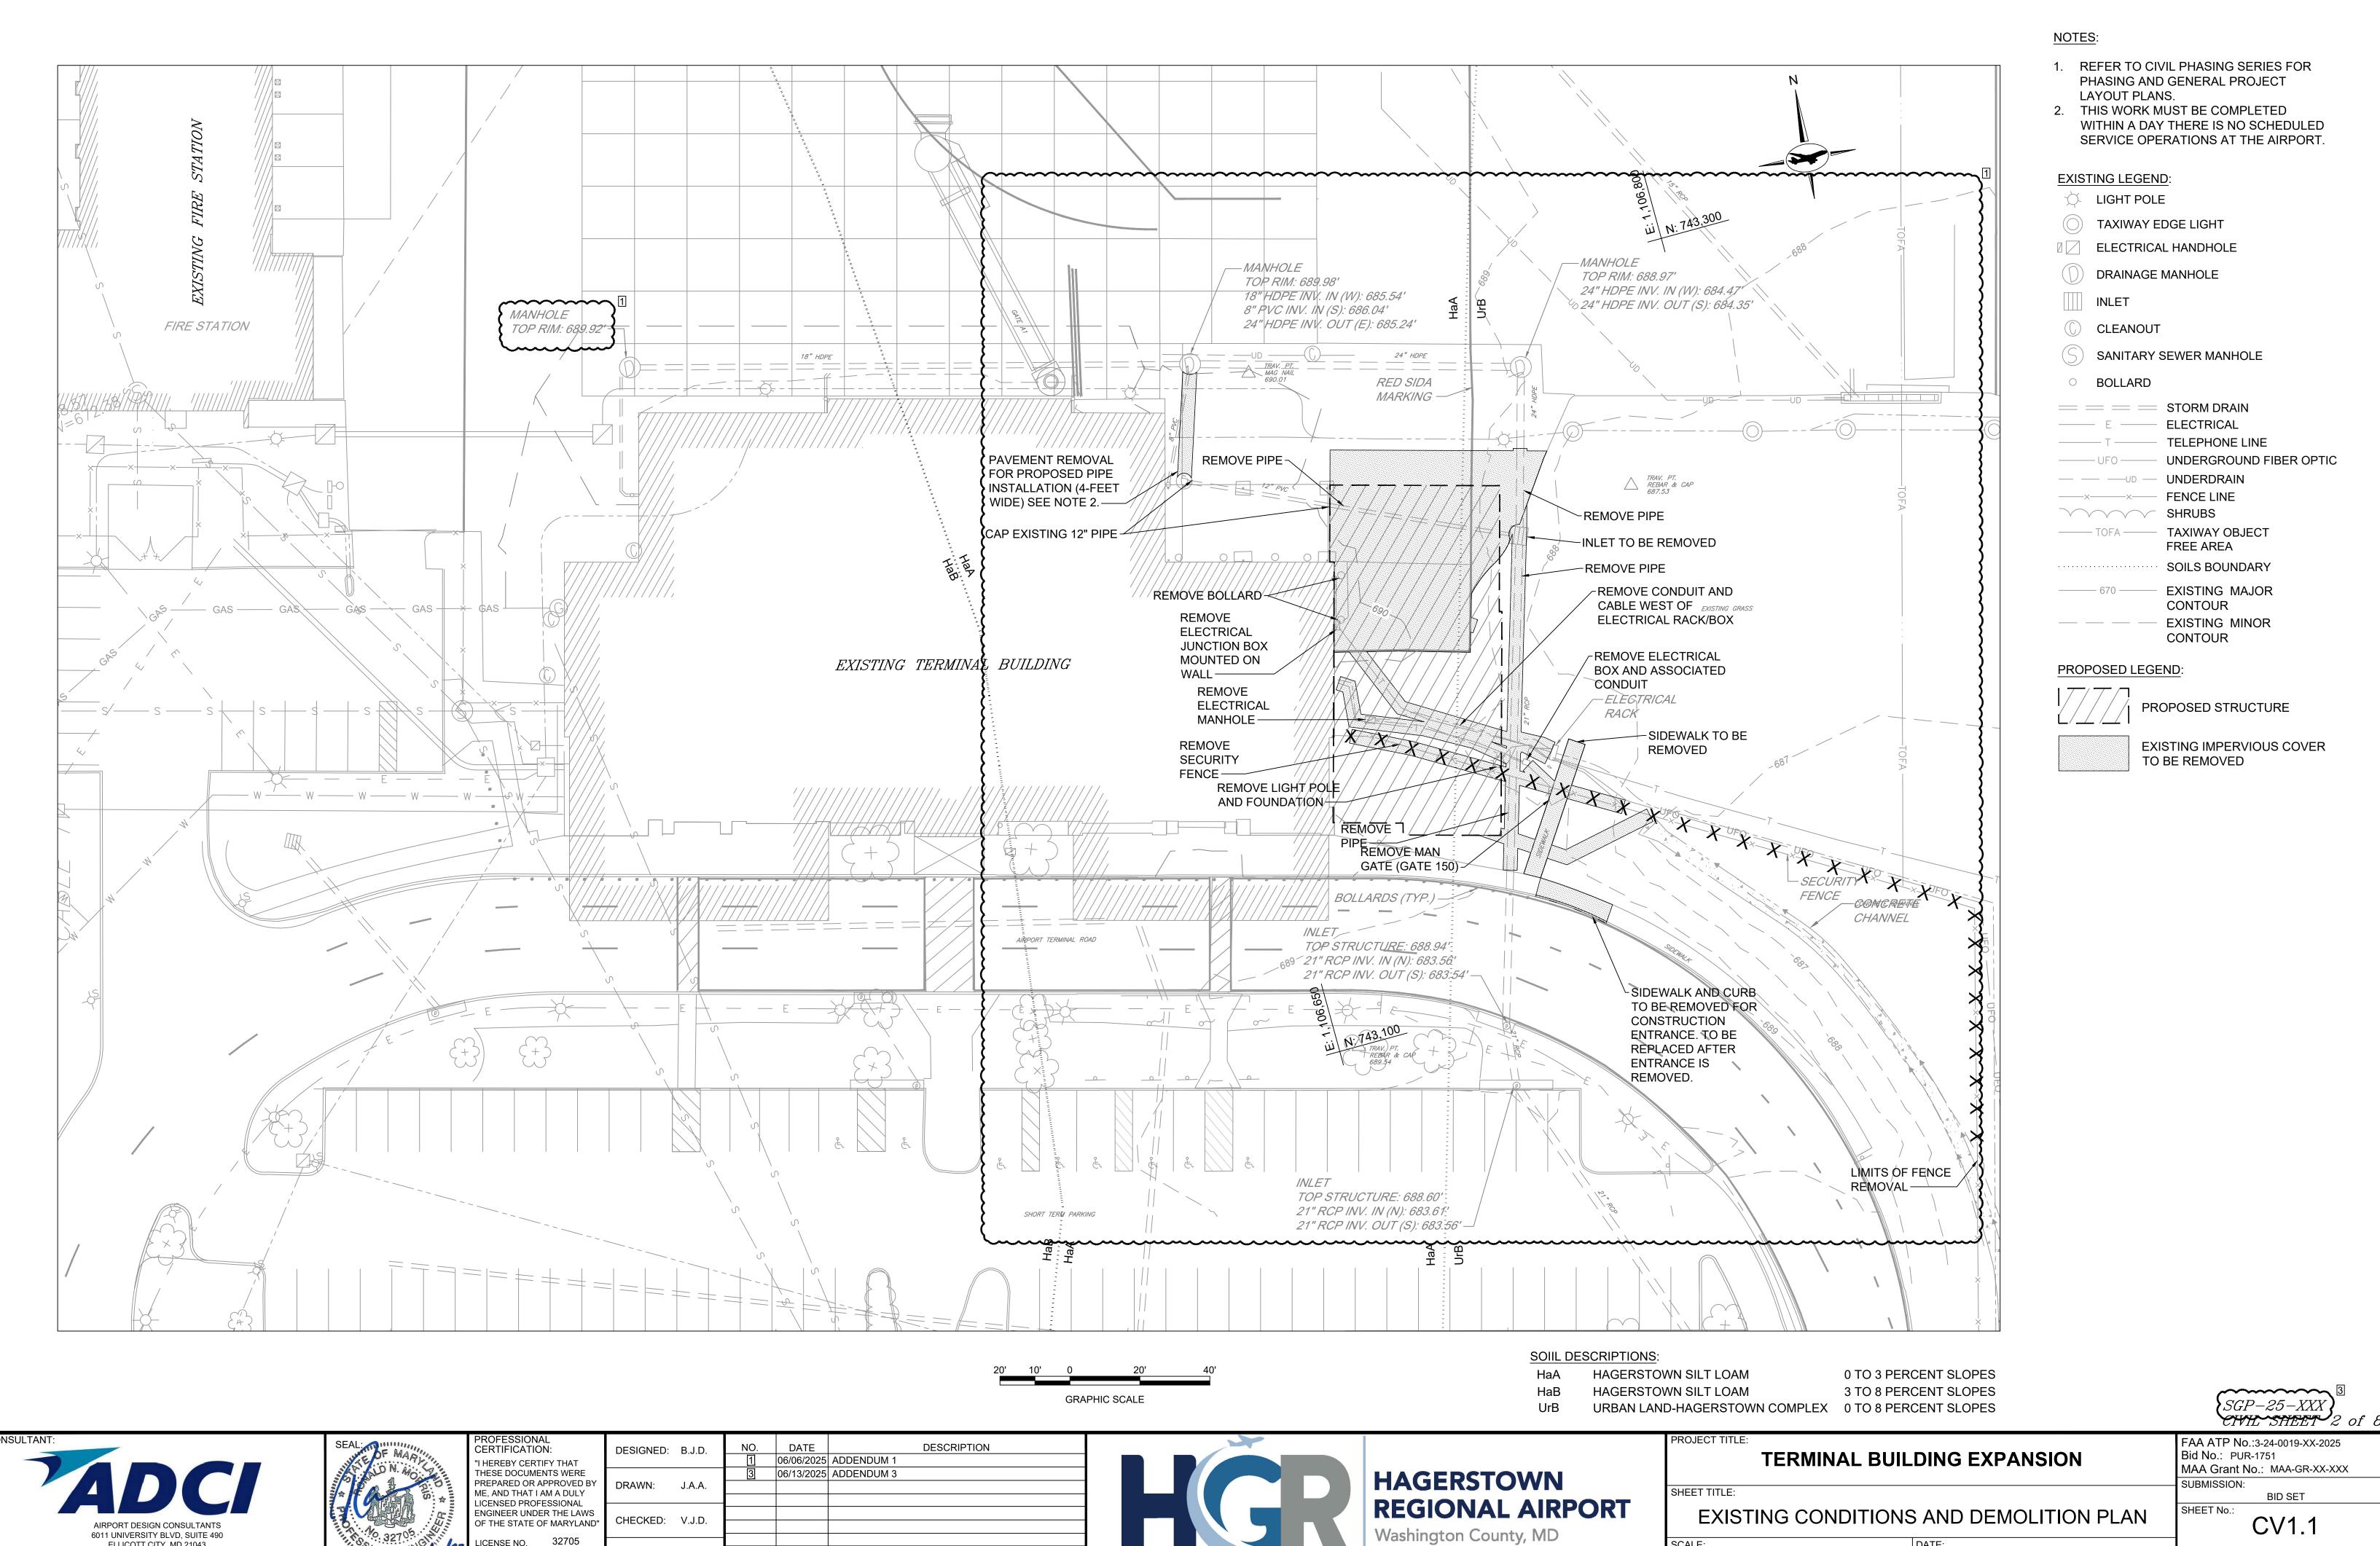

SCALE:

1" = 20'

20 OF 102

MAY 2025


ELLICOTT CITY, MD 21043 TEL: 410.465.9600


FAX: 410.465.9602

LICENSE NO. 32705

EXPIRATION DATE: 2/21/202

APPROVED: R.N.M.

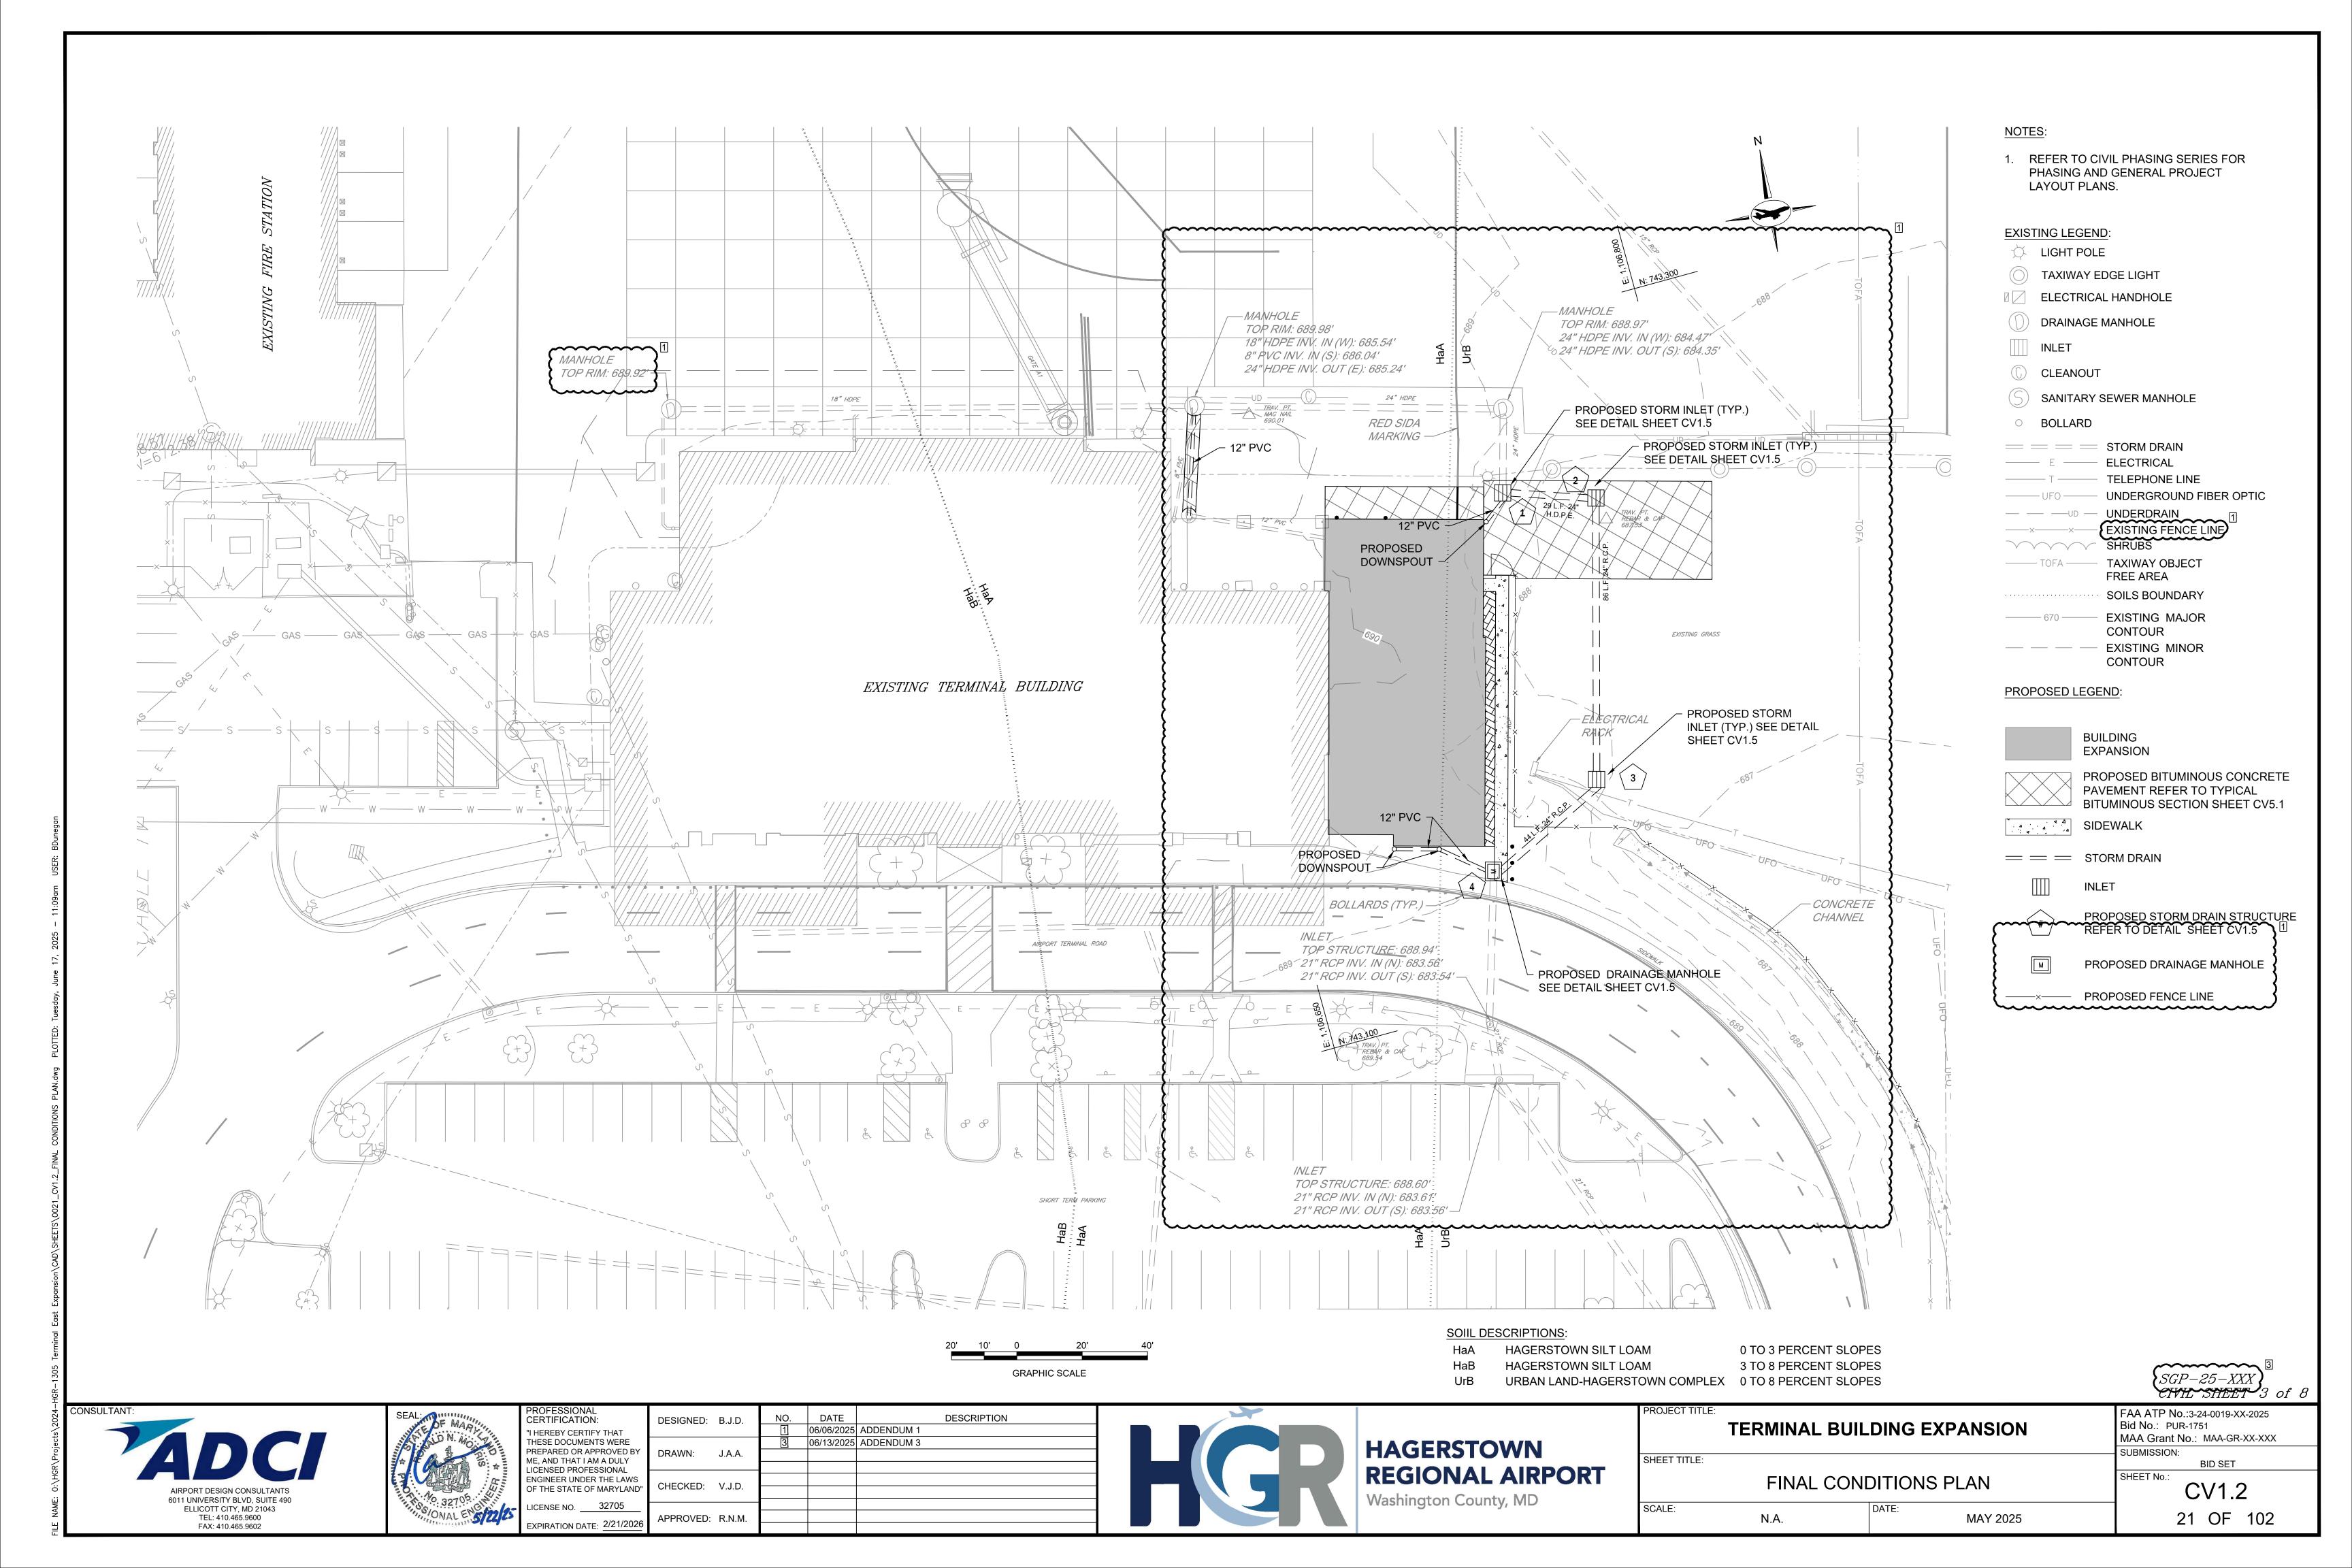

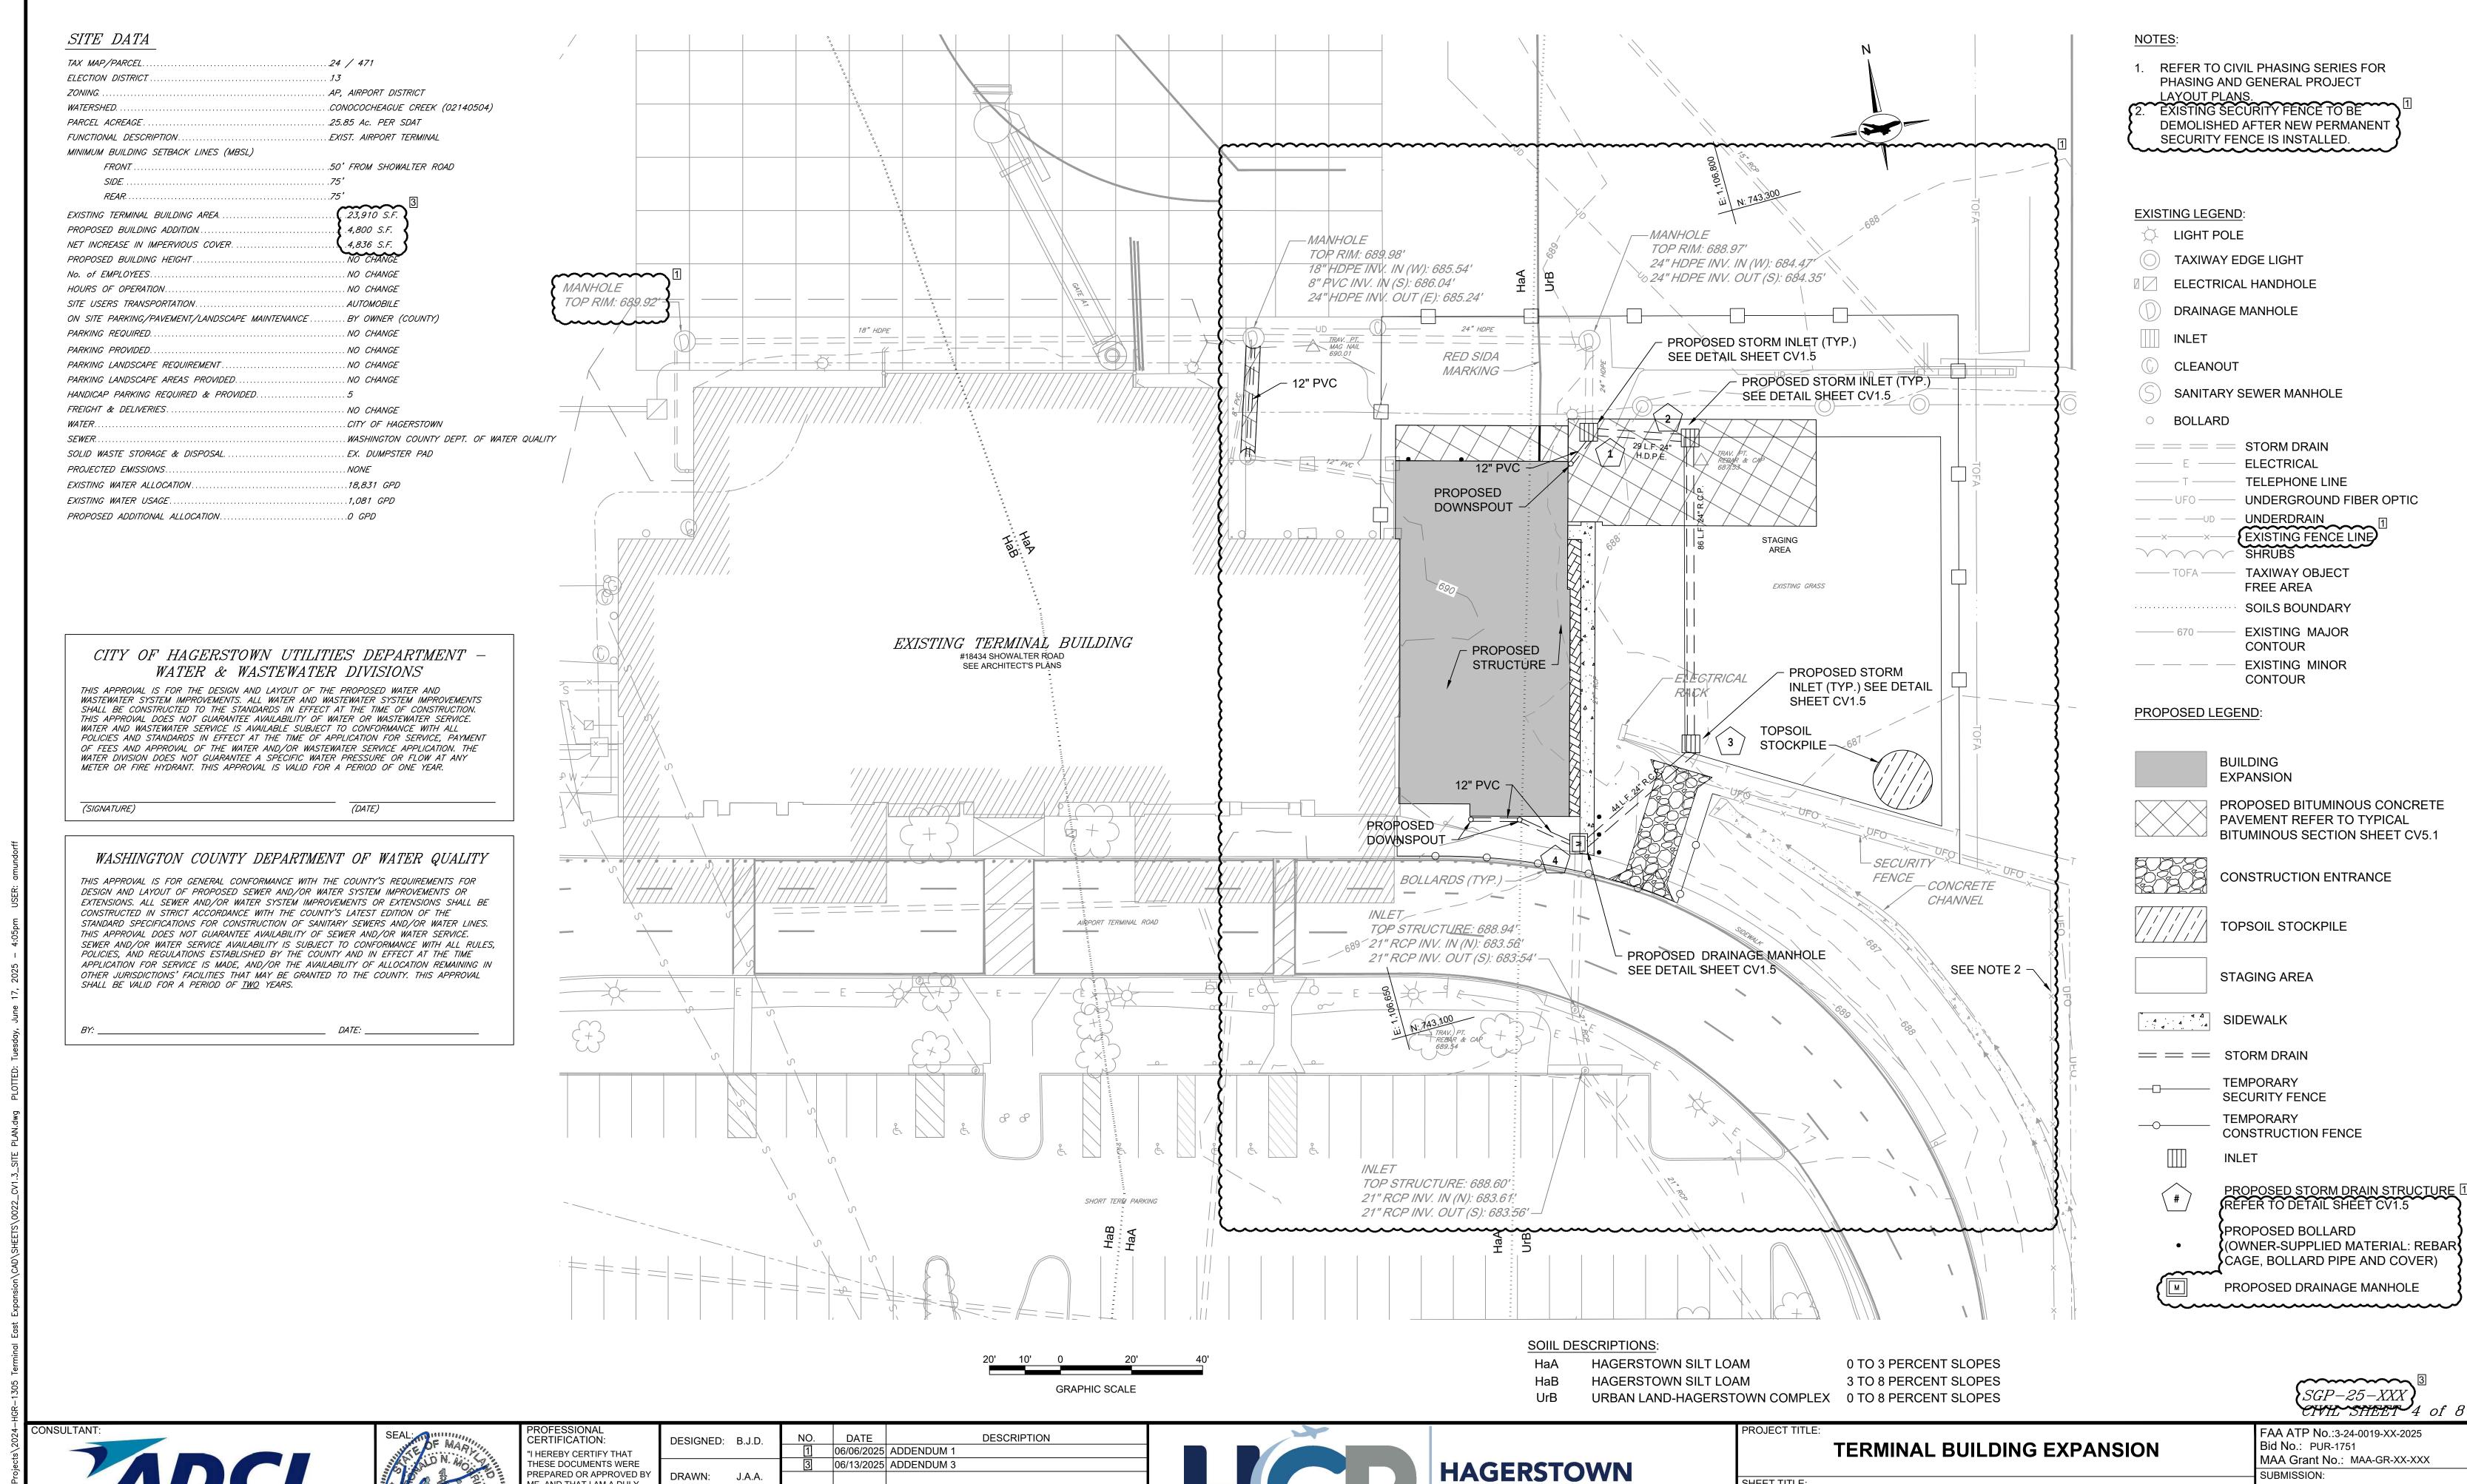

SHEET TITLE:

N.A.

SCALE:

SITE PLAN

MAY 2025

**REGIONAL AIRPORT** 

Washington County, MD

**BID SET** 

CV1.3

22 OF 102

SHEET No.:

6011 UNIVERSITY BLVD, SUITE 490

ELLICOTT CITY, MD 21043

TEL: 410.465.9600

FAX: 410.465.9602

ME, AND THAT I AM A DULY

ICENSED PROFESSIONAL

LICENSE NO. 32705


EXPIRATION DATE: 2/21/202


**ENGINEER UNDER THE LAWS** 


OF THE STATE OF MARYLAND"

CHECKED: V.J.D.

APPROVED: R.N.M.

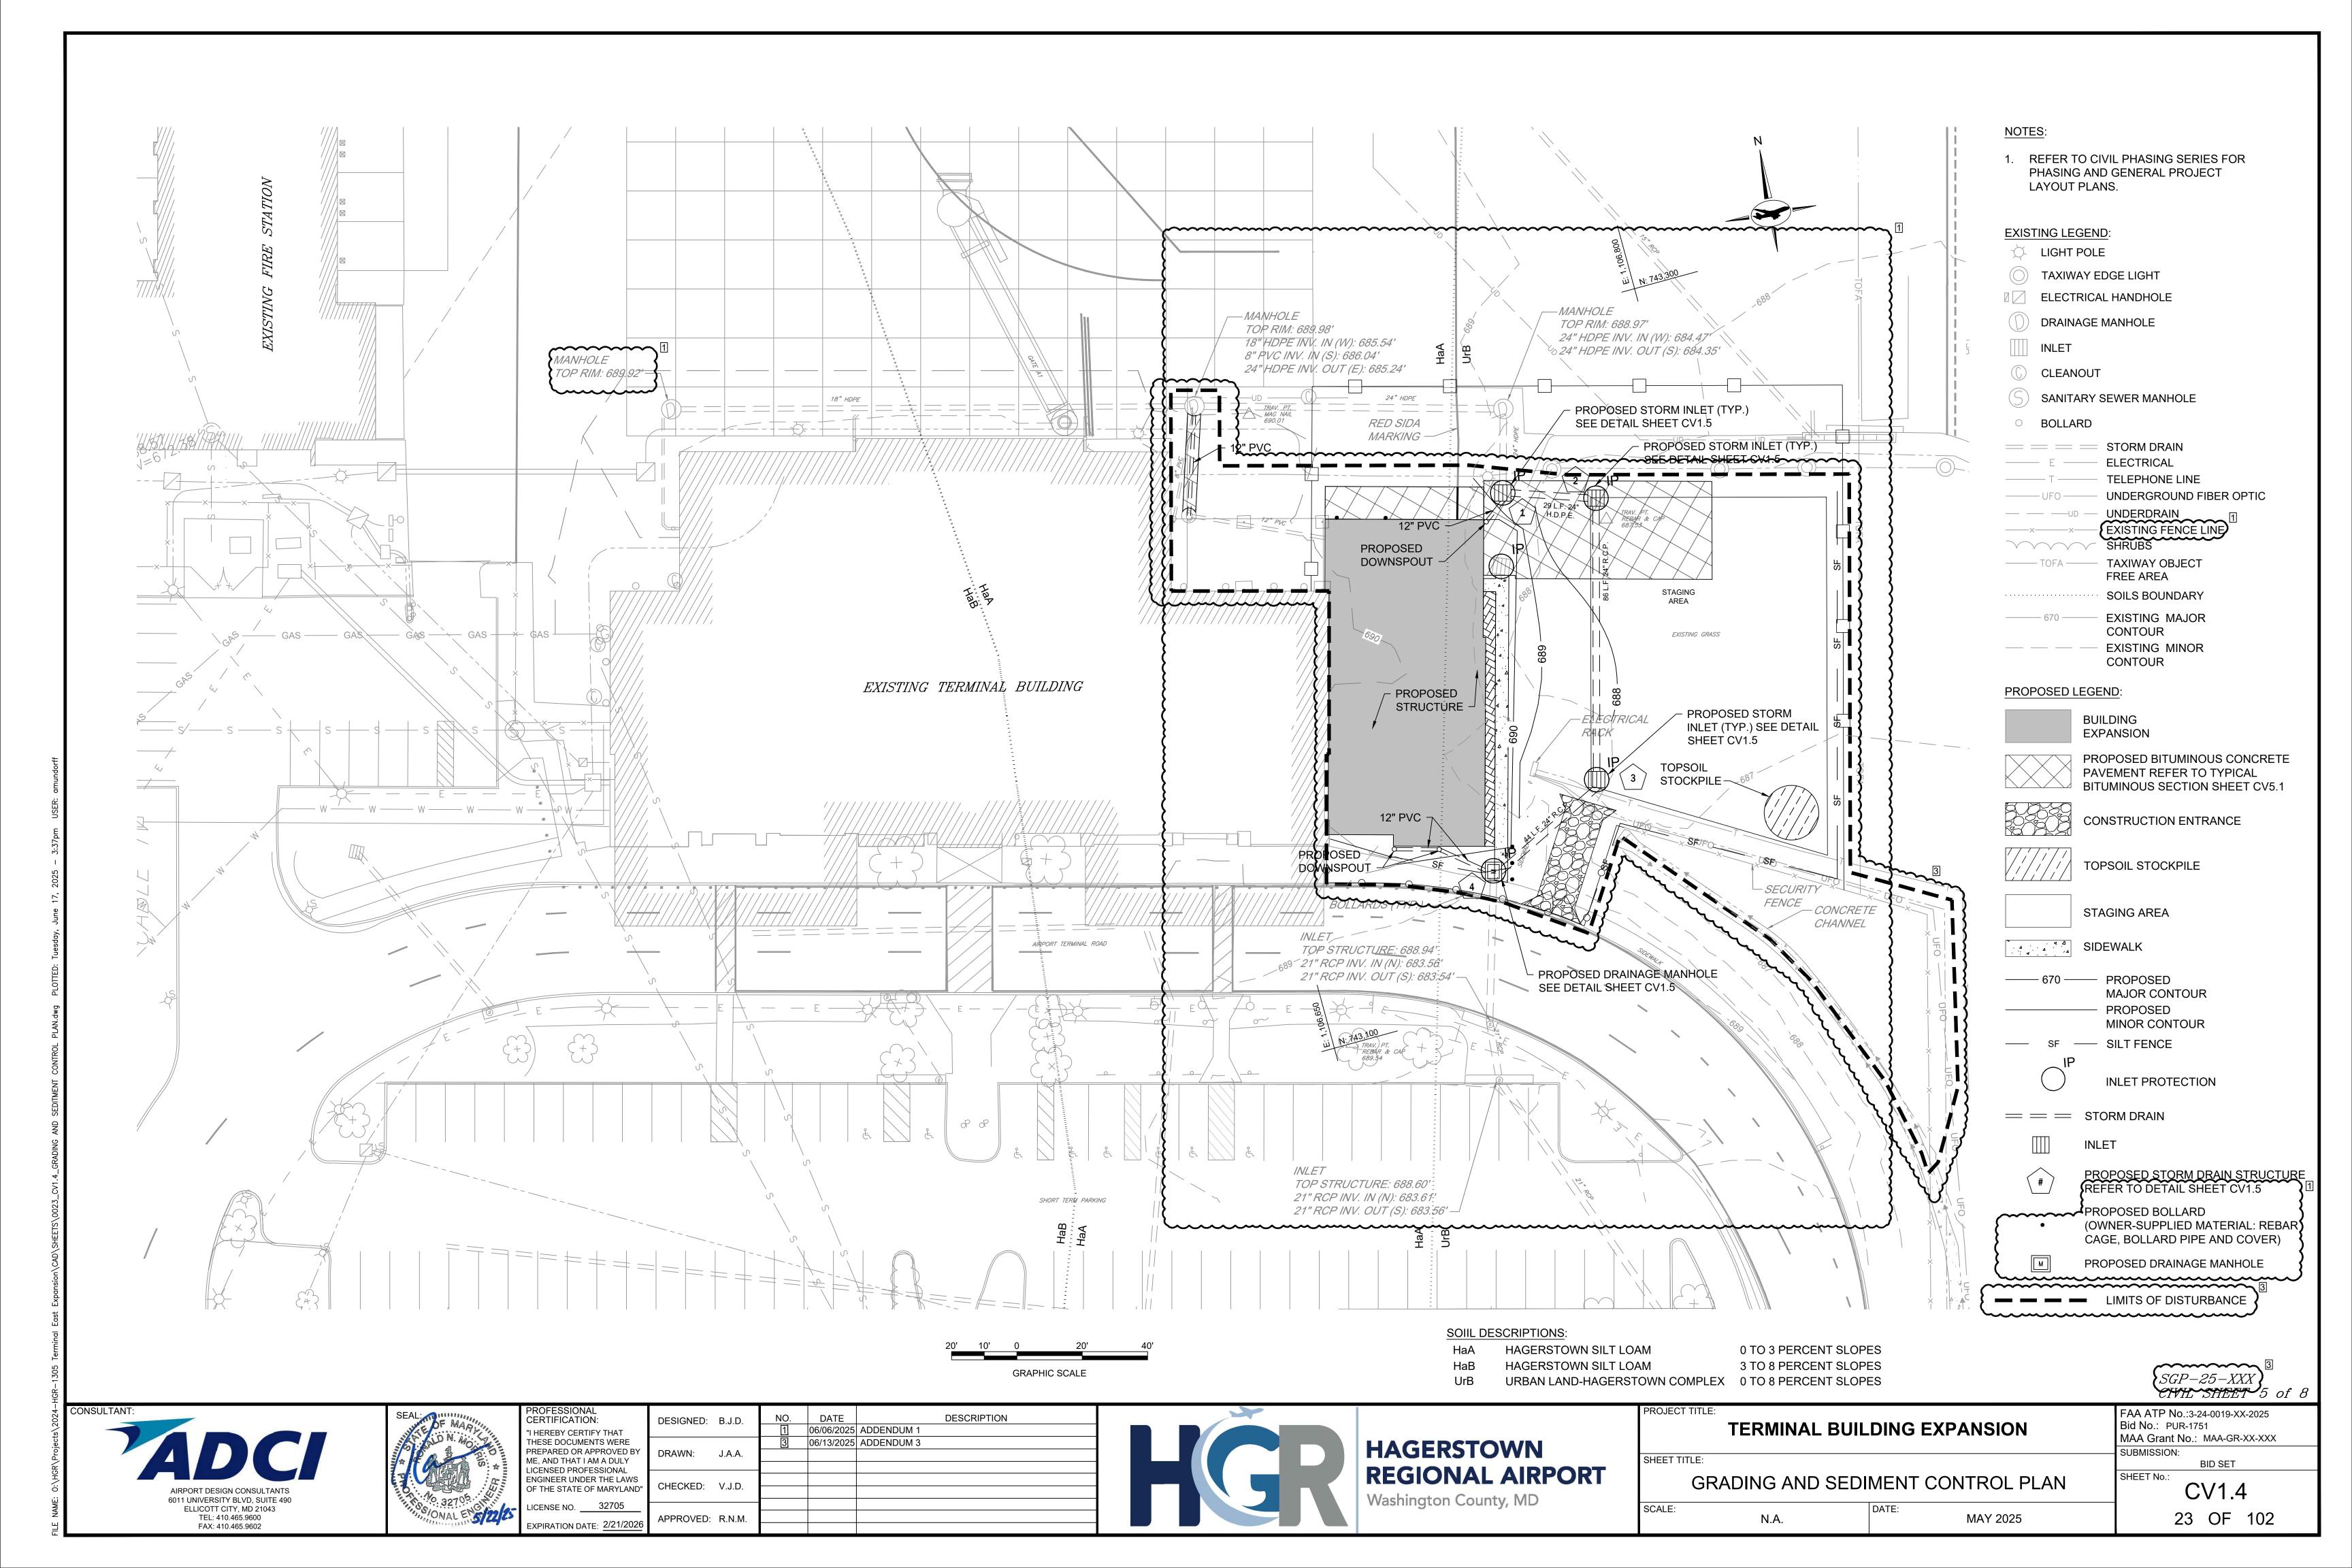

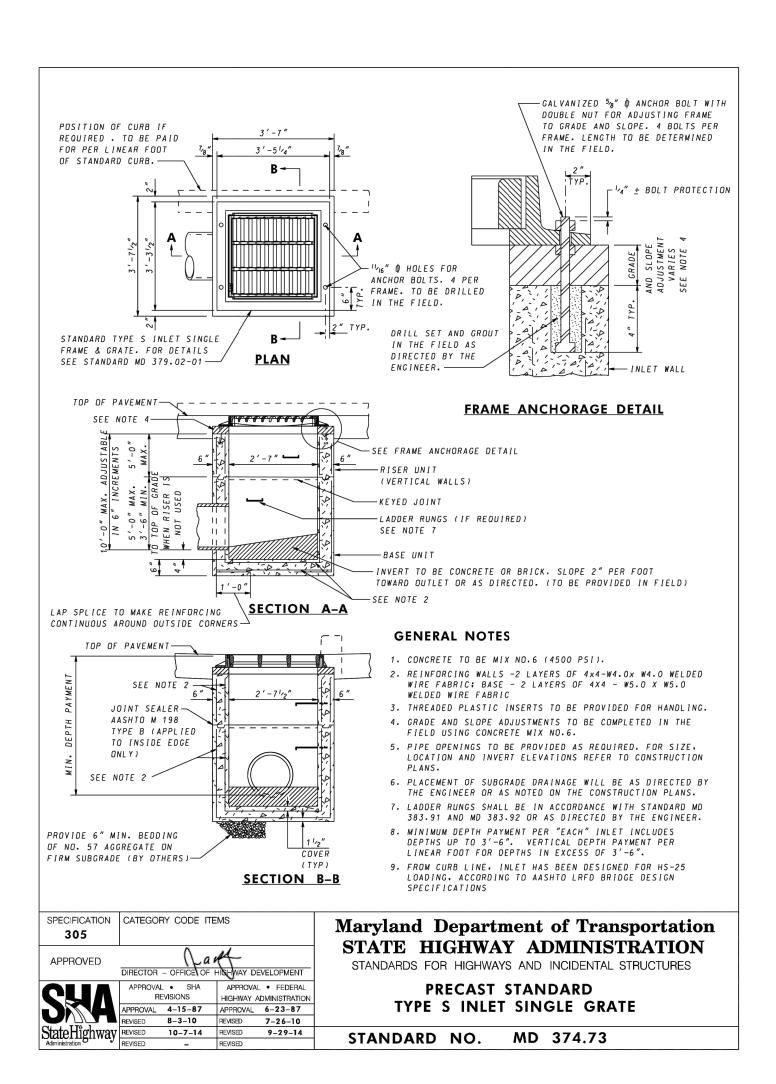

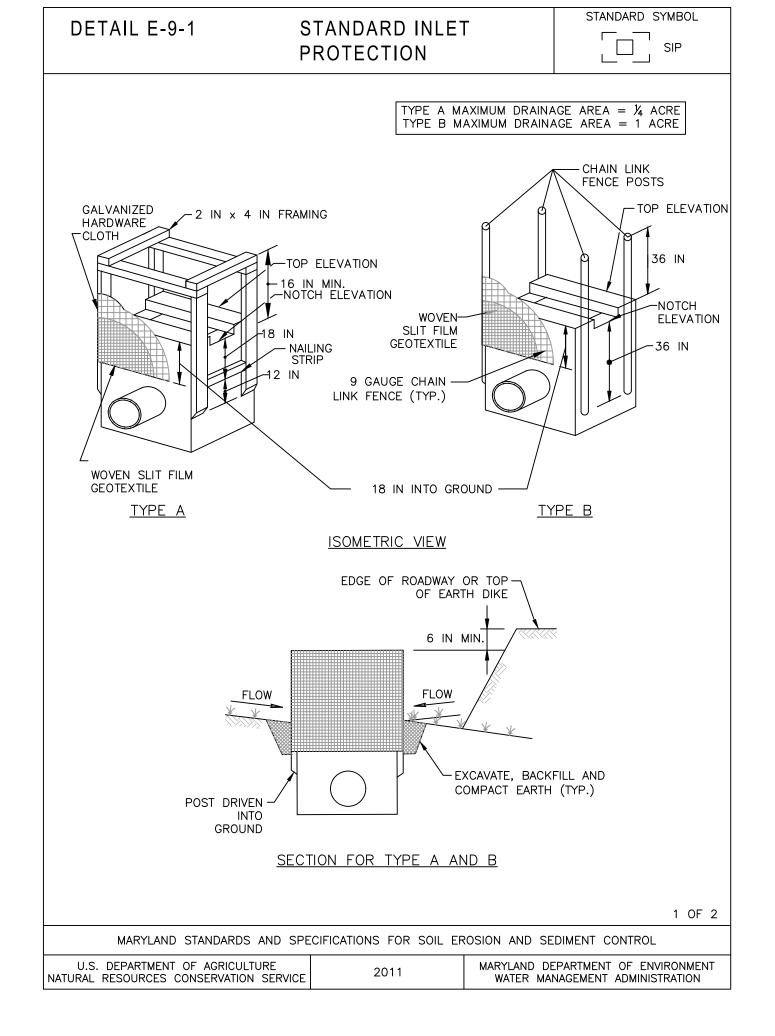

### SEQUENCE OF CONSTRUCTION

### PHASE 1 - INITIAL DISTURBANCE

- 1. CONTACT THE WASHINGTON COUNTY DPW ENGINEERING & CONSTRUCTION AT (240) 313-2400 AND THE WASHINGTON COUNTY SOIL CONSERVATION DISTRICT AT (301) 797-6821 EXT. 3 FIVE (5) DAYS PRIOR TO THE START OF CONSTRUCTION TO SCHEDULE PRE-CONSTRUCTION MEETING.
- CONDUCT PRE-CONSTRUCTION MEETING

### PHASE 2 - SITE WORK CONSTRUCTION

- INSTALL TEMPORARY SECURITY FENCE.
- INSTALL SILT FENCE AND CONSTRUCTION ENTRANCE AS SHOWN ON PLAN.
- INSTALL INLET PROTECTION AND TOPSOIL STOCKPILE AS SHOWN. ANY SPOIL AND/OR BORROW MUST COME FROM OR GO TO A SITE THAT HAS A CURRENT AND APPROVED SOIL EROSION AND SEDIMENT CONTROL PLAN.
- SAWCUT EXISTING CONCRETE AND PAVING AS SHOWN ON PLAN. WORKING DOWNSTREAM AND PROCEEDING UPSTREAM, INSTALL
- PROPOSED STORM DRAIN SYSTEM.
- BEGIN SITE DEMOLITION.
- BEGIN UTILITY CONSTRUCTION. BEGIN FOOTER AND BUILDING ADDITION ERECTION.
- BEGIN INSTALLATION OF ASPHALT PAVING SECTION.
- BEGIN INSTALLATION OF CONCRETE SIDEWALK AND LANDSCAPE STONE.
- BEGIN BOLLARD AND PERMANENT FENCE INSTALLATION 14. STABILIZE ALL GRASS AREAS, SEED AND MULCH.

### PHASE 3 - PROJECT CLOSE-OUT

- 15. OBTAIN PERMISSION FROM SCD TO REMOVE PERIMETER CONTROLS.
- STABILIZE AREAS LEFT DISTURBED BY PERIMETER CONTROL REMOVAL. CONTACT THE WASH. CO. SCD AT 301-797-6821 EXT. 3 AND THE WASHINGTON COUNTY DEPARTMENT OF PUBLIC WORKS-ENGINEERING & CONSTRUCTION AT 240-313-2400 TO SCHEDULE A FINAL SITE CLOSEOUT REVIEW MEETING.

### GENERAL NOTES 1. WALL REINFORCEMENT SHALL BE NO. 4 DEFORMED BARS @ 6" C/C 2 WAYS. AND HAVE 3" COVER BELOW DEPTH OF 12'-0" AND 4 2. BASE REINFORCEMENT SHALL BE NO. 4 DEFORMED BARS @ 6" C/C 2 WAYS, AND HAVE 2" COVER FROM TOP OF BASE. 3. MANHOLE HAS BEEN DESIGNED FOR HS-25 LOADING. ACCORDING AASHTO LRFD BRIDGE DESIGN SPECIFICATIONS 4. BRICK AND MORTAR MAY BE USED IN NON-TRAFFIC AREAS ONLY MANHOLE WALL THICKNESS 8" TO DEPTH OF 12'-0" BELOW DEPTH OF 12'-0" TO DEPTH OF 24'-0" MANHOLE BASE THICKNESS 8" WALL-USE 12" BASE 12" WALL-USE 15" BASE BENCH HEIGHT ABOVE OUTGOING PIPE INVERT STORM WATER 0.5 D <u>PLAN</u> SANITARY 0.9 D - TYPE A FRAME & COVER SEE STANDARD MD 383.91 OR MD 383.92-PLASTER 1/2" THICK (FOR BRICK ONLY) CHANNEL SHALL BE CONCRETE OR BRICK-CONCRETE OR BRICK-ON EDGE 1/4" FALL PER FOOT BASE THICKNESS-— SEE NOTE 2 SECTION A-A SECTION B-B SPECIFICATION | CATEGORY CODE ITEMS **Maryland Department of Transportation** STATE HIGHWAY ADMINISTRATION STANDARDS FOR HIGHWAYS AND INCIDENTAL STRUCTURES DIRECTOR - OFFICE OF HIGHWAY DEVELOPME STANDARD MANHOLE STANDARD NO. MD 383.01

### SOIL EROSION. SEDIMENT CONTROL & SEEDING NOTES

- ALL EROSION/SEDIMENT CONTROL MEASURES SHALL COMPLY WITH THE "2011 MARYLAND STANDARDS AND SPECIFICATIONS FOR SOIL EROSION AND SEDIMENT CONTROL" AND THE PROVISIONS OF THE APPROVED PLAN.
- 2. ALL GRADING AND STABILIZATION SHALL COMPLY WITH THE "2011 MARYLAND" STANDARDS AND SPECIFICATIONS FOR SOIL EROSION AND SEDIMENT CONTROL". "SECTION B - GRADING AND STABILIZATION" AND THE PROVISIONS OF THE APPROVED
- 3. ALL SOIL EROSION AND SEDIMENT CONTROL PRACTICES (BMP'S) ARE TO BE CONSTRUCTED AND/OR INSTALLED PRIOR TO OR AT THE INITIATION OF GRADING IN ACCORDANCE WITH "2011 MARYLAND STANDARDS AND SPECIFICATIONS FOR SOIL EROSION AND SEDIMENT CONTROL", AND THE APPROVED PLAN.
- 4. A GRADING UNIT IS THE MAXIMUM CONTIGUOUS AREA ALLOWED TO BE GRADED AT A GIVEN TIME AND IS LIMITED TO 20 ACRES. WORK MAY PROCEED TO A SUBSEQUENT GRADING UNIT WHEN AT LEAST 50 PERCENT OF THE DISTURBED AREA IN THE PRECEDING GRADING UNIT HAS BEEN STABILIZED AND APPROVED BY THE ENFORCEMENT AUTHORITY AND/OR THE WASHINGTON COUNTY SOIL CONSERVATION DISTRICT (APPROVAL AUTHORITY). UNLESS OTHERWISE SPECIFIED AND APPROVED BY THE APPROVAL AUTHORITY, NO MORE THAN 30 ACRES CUMULATIVELY MAY BE DISTURBED AT A GIVEN TIME.
- FOR INITIAL SOIL DISTURBANCE OR RE-DISTURBANCE, TEMPORARY OR PERMANENT STABILIZATION MUST BE COMPLETED WITHIN:
- a) THREE (3) CALENDAR DAYS AS TO THE SURFACE OF ALL PERIMETER DIKES, SWALES, DITCHES, PERIMETER SLOPES, AND ALL SLOPES STEEPER THAN 3 HORIZONTAL TO 1 VERTICAL (3:1); AND
- b) SEVEN (7) CALENDAR DAYS AS TO ALL OTHER DISTURBED OR GRADED AREAS ON THE PROJECT SITE NOT UNDER ACTIVE GRADING.
- STOCKPILES MUST BE STABILIZED IN ACCORDANCE WITH THE 7 DAY STABILIZATION REQUIREMENT, AS WELL AS, STANDARD B-4-1 INCREMENTAL STABILIZATION AND STANDARD B-4-4 TEMPORARY STABILIZATION. (AS APPLICABLE)
- 7. ALL CONSTRUCTED CHANNELS AND SWALES SHALL HAVE SPECIFIED TREATMENT INSTALLED TO THE DESIGN FLOW DEPTH COMPLETED DOWNSTREAM TO UPSTREAM AS CONSTRUCTION PROGRESSES. AN INSTALLATION DETAIL SHALL BE SHOWN ON
- 8. ALL STORM DRAIN AND SANITARY SEWER LINES NOT IN PAVED AREAS ARE TO BE MULCHED AND SEEDED WITHIN 3 DAYS OF INITIAL BACKFILL UNLESS OTHERWISE SPECIFIED ON PLANS.
- 9. ELECTRIC POWER, TELEPHONE, AND GAS LINES ARE TO BE COMPACTED, SEEDED AND MULCHED WITHIN 3 DAYS AFTER INITIAL BACKFILL UNLESS OTHERWISE SPECIFIED ON PLANS.
- 10. NO SLOPE SHALL BE GREATER THAN 2:1.
- 11. AS REQUIRED BY SECTION B, OF THE MARYLAND STANDARDS AND SPECIFICATIONS FOR SOIL EROSION AND SEDIMENT CONTROL, "ADEQUATE VEGETATIVE STABILIZATION", IS DEFINED AS 95 PERCENT GROUND COVER. THE WASHINGTON COUNTY SOIL CONSERVATION DISTRICT REQUIRES THE PROJECT ADHERE TO THIS FOR SCHEDULING OF THE FINAL SITE CLOSEOUT REVIEW, AND/OR THE RELEASE OF THE SITE FOR SOIL EROSION AND SEDIMENT CONTROL.

### FOR SITES 1.0 ACRE OR MORE, THE FOLLOWING ARE REQUIRED

- A. MARYLAND DEPARTMENT OF THE ENVIRONMENT, GENERAL PERMIT FOR STORMWATER ASSOCIATED WITH A CONSTRUCTION ACTIVITY, N.P.D.E.S. PERMIT NUMBER MDRC, STATE DISCHARGE PERMIT NUMBER 14GP, OR AN INDIVIDUAL PERMIT.
- B. THE MARYLAND DEPARTMENT OF THE ENVIRONMENT (GENERAL/INDIVIDUAL PERMIT-NOTICE OF INTENT - N.O.I.) APPLICATION AND PERMIT SHALL BE POSTED AND/OR AVAILABLE ON-SITE AT ALL TIMES.
- C. DURING CONSTRUCTION, ALL SOIL EROSION AND SEDIMENT CONTROL PRACTICES (B.M.P.'s) SHALL BE INSPECTED AND RECORDED ON THE "STANDARD INSPECTION FORM", "GENERAL PERMIT FOR STORMWATER ASSOCIATED WITH CONSTRUCTION ACTIVITY" PER MARYLAND DEPARTMENT OF THE ENVIRONMENT (GENERAL/INDIVIDUAL PERMIT - NOTICE OF INTENT - N.O.I.).
- D. FOLLOWING CONSTRUCTION AND RELEASE OF THE SIGHT FOR SOIL EROSION AND SEDIMENT CONTROL BY THE WASHINGTON COUNTY SOIL CONSERVATION DISTRICT I.E., ALL PORTIONS OF A SITE HAVE BEEN PERMANENTLY STABILIZED, AND ALL STORMWATER DISCHARGES FROM THE CONSTRUCTION SITES THAT ARE AUTHORIZED BY THE PERMIT AREA ELIMINATED, THE AUTHORIZED PERMITEE SHALL SUBMIT THE MARYLAND DEPARTMENT OF THE ENVIRONMENT, GENERAL/INDIVIDUAL PERMIT - NOTICE OF TERMINATION - N.O.T.

# PERMANENT SEEDING SUMMARY

		RE (HARDINESS 2 ROM TABLE B.3	ZONE 6B)			RTILIZER RA (10–20–20)		LIME
No.	SPECIES	APPLICATION RATE (LB/AC)	SEEDING DATES	SEEDING DEPTHS	N	P205	K20	RATE
6	TALL FESCUE WHITE CLOVER PERENNIAL RYE GRASS	40 8 25	3/15 - 6/1 8/1 - 10/15	14" - 12"	45 LB/AC (1.0 LB/ 1000 S.F.)	90 LB/AC (2 LB/ 1000 S.F.)	90 LB/AC (2 LB/ 1000 S.F.)	2 TONS/A (90 LB/ 1000 S.F.

# TEMPORARY SEEDING SUMMARY

	SEED MIX	KTURE (HARDINES FROM TABLE E	FERTILIZER	UNE DATE				
No.	SPECIES	APPLICATION RATE (LB/AC)	SEEDING DATES	SEEDING DEPTHS	RATE (10–20–20)	LIME RATE		
2	BARLEY (HORDEUM VULGARE)	96	3/1 - 5/15 8/1 - 9/30	1.0"	436 LBS./AC. (10 LBS/1000 S.F.)	2 TONS/AC. (90 LBS/1000 S.F.)		
SE	TEMPORARY SEEDING SHALL COMPLY WITH  SECTION B-4-4 OF THE 2011 MARYLAND STANDARDS FOR SOIL EROSION AND SEDIMENT CONTROL							

SGP-25-XXX CIVIL SHEET 6





**CERTIFICATION:** HEREBY CERTIFY THAT THESE DOCUMENTS WERE PREPARED OR APPROVED BY ME, AND THAT I AM A DULY ICENSED PROFESSIONAL ENGINEER UNDER THE LAWS ICENSE NO. 32705

OF THE STATE OF MARYLAND" EXPIRATION DATE: 2/21/2020

**DESCRIPTION** DESIGNED: B.J.D. 06/06/2025 ADDENDUM 1 06/13/2025 ADDENDUM 3 DRAWN: J.A.A. CHECKED: V.J.D. APPROVED: R.N.M.



**HAGERSTOWN REGIONAL AIRPORT** 

SCALE:

Washington County, MD

# TERMINAL BUILDING EXPANSION

MAA Grant No.: MAA-GR-XX-XXX DRAINAGE AND EROSION AND SEDIMENT SHEET No.: CONTROL NOTES AND DETAILS


MAY 2025

**BID SET** CV1.5

FAA ATP No.:3-24-0019-XX-2025

Bid No.: PUR-1751

24 OF 102

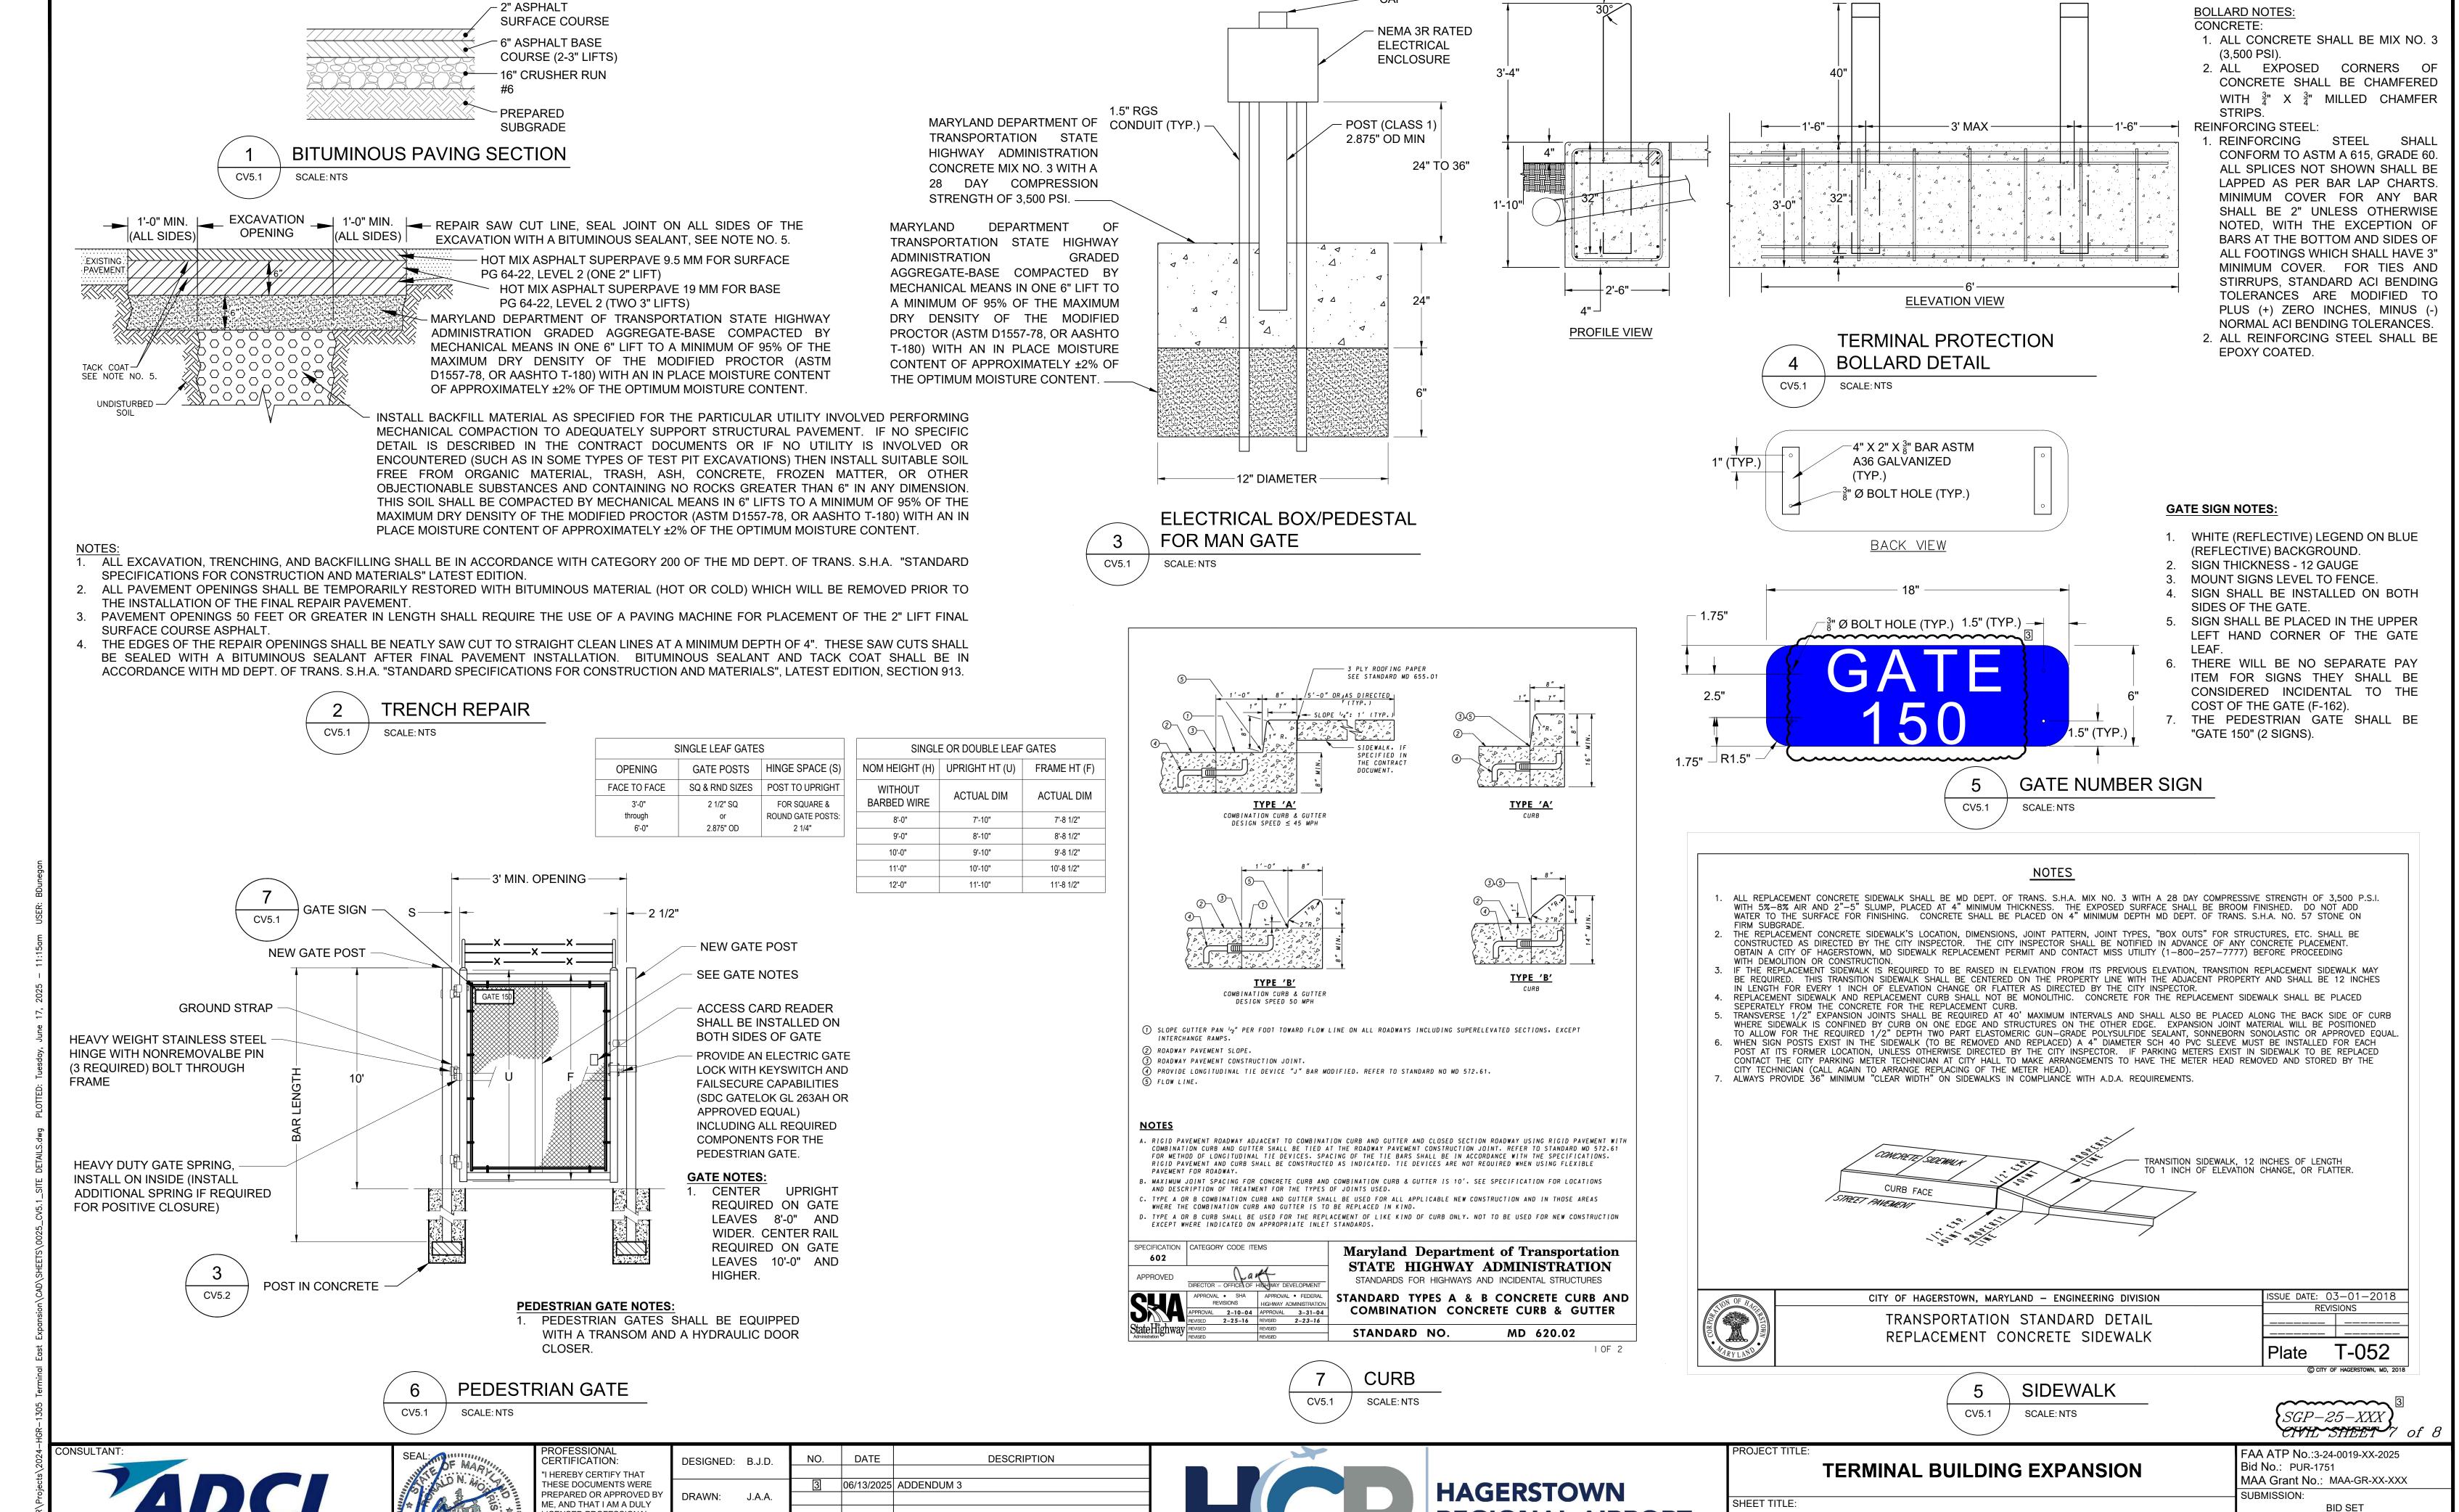

**REGIONAL AIRPORT** 

SCALE:

N.A.

Washington County, MD

SHEET No.:

CV5.1

25 OF 102

SITE DETAILS 1

MAY 2025

6011 UNIVERSITY BLVD. SUITE 490

ELLICOTT CITY, MD 21043

TEL: 410.465.9600

FAX: 410.465.9602

ICENSED PROFESSIONAL

JICENSE NO. \_ 32705

**ENGINEER UNDER THE LAWS** 

OF THE STATE OF MARYLAND"

EXPIRATION DATE: 2/21/2026

CHECKED: V.J.D.

APPROVED: R.N.M.

ALL DIMENSIONS, SIZES, GAUGES, WEIGHTS, THICKNESS SHOWN ARE THE MINIMUM ACCEPTABLE, UNLESS OTHERWISE INDICATED.

3. THE FEDERAL SPECIFICATIONS SHOWN SHALL BE INTERPRETED TO MEAN THE LATEST ISSUE OR

AMENDMENT OF SUCH SPECIFICATIONS, IN EFFECT OF THE DATE OF BIDDING. 4. FAA SPECIFICATIONS SHOWN ARE FROM THE FEDERAL AVIATION ADMINISTRATION(FAA) STANDARD

SPECIFICATIONS FOR CONSTRUCTION OF AIRPORTS MATERIALS AND CONSTRUCTION METHODS NOT DETAILED HEREIN, SHALL BE IN ACCORDANCE WITH THE FAA SPECIFICATION LISTED, UNLESS OTHERWISE NOTED ON CONTRACT PLANS.

6. FENCE ARE MEASURED IN PLACE, FROM OUTSIDE TO OUTSIDE OF END CORNER OR GATE POSTS MEASUREMENT DOES NOT INCLUDE GATE OPENINGS.

7. FABRIC ON BOUNDARY AND SECURITY FENCE SHALL BE ON THE SIDE OF POSTS AWAY FROM AIRPORT PROPERTY. CHAIN LINK FABRIC SHALL BE 9 GAUGE WIRE WITH A 2" MESH AND SHALL MEET THE REQUIREMENTS OF ASTM A392, CLASS 2. SELVEGE SHALL BE TWISTED AND BARBED. BOTTOM SELVAGE SHALL BE TWISTED AND KNUCKLED.

BARB WIRE SHALL BE ZINC COATED, MEETING ASTM A121, CLASS 3, OR ALUMINUM COATED MEETING ASTM A585, CLASS 2, AS APPROPRIATE. WIRE SHALL BE TWO STRANDED TWISTED NO. 12-1/2 ASW GAUGE STEEL WITH FOUR POINT BARBS, NO 14 ASW GAUGE MINIMUM, ½ MINIMUM LENGTH, SPACED ON APPROXIMATELY 5' CENTERS. 3 STRANDS OF BARB WIRE SHALL BE STRUNG ALONG THE TOP OF FENCE ON AN INCLINED BARB WIRE ARM. THE BARBED WIRE ARM SHALL HAVE A 45 INCLINATION AWAY FROM THE SECURE SIDE.

END POSTS SHALL INCLUDE STRETCHER BARS, CLAMPS, BRACES AND TRUSS RODS.

10. ALL DEPRESSIONS GREATER THAN 3" AND LESS THAN 1' SHALL BE FILLED WITH ROCKS OR COMPACTED EARTH TO PREVENT ANIMALS FROM GOING UNDER THE FENCE. FENCE TREATMENT AT GROUND DEPRESSIONS GREATER THAN OR EQUAL TO 1 FOOT SHALL BE CLOSED WITH ONE OR MORE ADDITIONAL LINE POST NEAR THE OPENING CENTER WITH ADDITIONAL FENCE FABRIC STRECHED BETWEEN POST. SEE DETAIL ON SHEET CF502. THIS WORK SHALL BE INCIDENTAL TO THE FENCE INSTALLATION COST.

11. THE FENCE SHALL BE CONSTRUCTED VERTICAL, STRAIGHT, AND TRUE OF LINE, THE LONGITUDINAL GRADIENT SHALL PARALLEL THE GENERAL SLOPE OF THE GROUND.

12. CONCRETE FOOTINGS SHALL MEET STRENGTH REQUIREMENTS OUTLINED IN SPECIFICATION F-162. FOOTING TOPS SHALL BE 1" MINIMUM ABOVE GROUND AT POST. AND TROWEL FINISHED TO SLOPE AWAY FROM POST ALL END POSTS, CORNER POSTS, PULL POSTS, AND GATE POSTS SHALL HAVE A 18" X 5'-6" DEEP(MIN.) FOUNDATION. LINE POSTS SHALL HAVE A 12" X 3'6" DEEP (MIN.) FOUNDATION.

13. PLACE PULL POSTS AT ANGLE POINTS IN A VERTICAL ALIGNMENT, AT A MAX OF 500 FOOT INTERVALS BETWEEN END AND/OR CORNER POST IN LEVEL TERRAIN, OR AS DIRECTED BY THE RPR.

14. THE MATERIALS SHALL MEET THE REQUIREMENTS, AND THE FENCE SHALL BE INSTALLED IN ACCORDANCE WITH F-162 OF THE DETAILED SPECIFICATIONS.

15. THE CONTRACTOR SHALL VERIFY THE AMOUNT OF POST, FENCE, ETC. BEFORE ANY MATERIAL IS ORDERED OR CONSTRUCTION WORK CAN BEGIN.

16. PUT FASTENERS AT 12" CENTER TO CENTER STAGGERED ON EACH EDGE OF FABRIC ALONG THE JOINT

17. CONTRACTOR SHALL PROVIDE A PADLOCK TO TEMPORARILY LOCK VEHICLE OR MAN GATES UNTIL THE ACCESS CONTROLS CAN BE INSTALLED. IT IS THE CONTRACTOR'S RESPONSIBILITY TO LOCK THE GATE AT THE END OF EACH SHIFT.

18. PLACE TOP CAPS ON ALL NEW FENCE POSTS.

SECURE SIDE

19. MODIFICATIONS TO THESE PLANS MAY BE MADE AT THE TIME OF INSTALLATION. MINOR MODIFICATIONS MAY INCLUDE DEVIATIONS IN THE FENCE AND GATE LOCATIONS.

20. THE CONTRACTOR SHALL PEEN ALL BOLTS TO ELIMINATE THE REMOVAL OF THE BOLT NUT.

NON-SECURE SIDE

1'-0"

3/8" PLAIN PIN

FENCE TOP DETAIL

SCALE: NTS

RIVETED FLUSH (TYP.)


21. THE CONTRACTOR SHALL SEAL THE CONCRETE/ASPHALT JOINT FOR ALL NEW POST FOUNDATIONS LOCATED

IN EXISTING PAVEMENT. THIS IS INCIDENTAL TO THE FENCE INSTALLATION COST. 22. ALL PROPOSED FENCE AND GATES SHALL BE CHAIN LINK FENCE WITH BLACK VINYL COATING. ALL MATERIALS TO COMPLY WITH ASTM F668, CLASS B (VINYL COATING OVER GALVANIZED STEEL).


**BARBED WIRE** 


**12 GAUGE 3** 

STRANDS

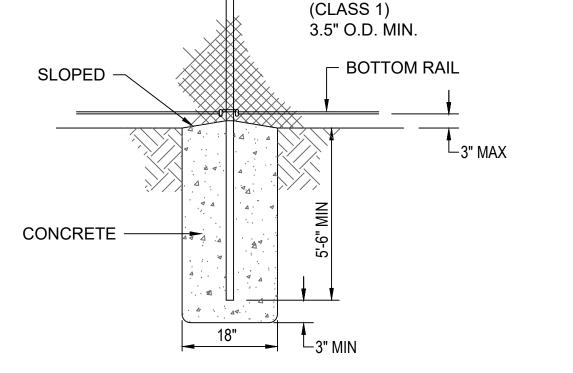

CORNER/END/TERMINAL POST

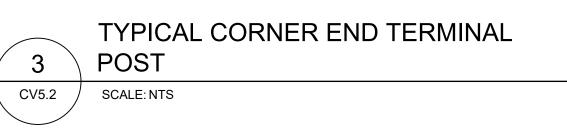

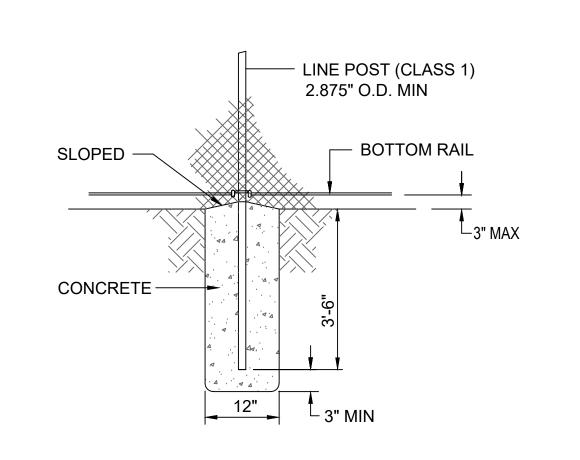




**END OR CORNER BAY** #7 GAUGE **TENSION** CV5.2 3 STRANDS OF BARBED WIRE WIRE -**BARBED** CORNER, END OR TERMINAL POST — WIRE CHAINLINK FABRIC INSIDE OUTSIDE HOG RING 18" O.C. - LINE POST TIE 12" O.C. 9 GAUGE, 2" MESH **AIRPORT AIRPORT BRACE RAIL** STRETCHER BAR -WOVEN - RAIL TIE 18" O.C. WIRE OR **CHAIN LINK ADJUSTABLE** BOTTOM RAIL (TYP. TRUSS ROD 3/8" -BOTTOM CONCRETE DIAMETER RAIL (TYP. FOOTING -3 -INSTALL FENCE FABRIC TO GROUND CV5.2 LEVEL CV5.2 6 STRANDS OF BARBED WIRE AT GROUND DEPRESSIONS CV5.2 MULTIPLIES OF 10'-0" O.C. 10'-0" MAX. O.C. ALONG THE FENCE LINE, AS SLATS (NOT SHOWN FOR **END OR CORNER BAY** DIRECTED BY THE ENGINEER CLARITY) SHALL BE INSTALLED TO OBSCURE VISION BEYOND THE FENCE

MULTIPLIES OF 10'-0" O.C.

10'-0" MAX. O.C.



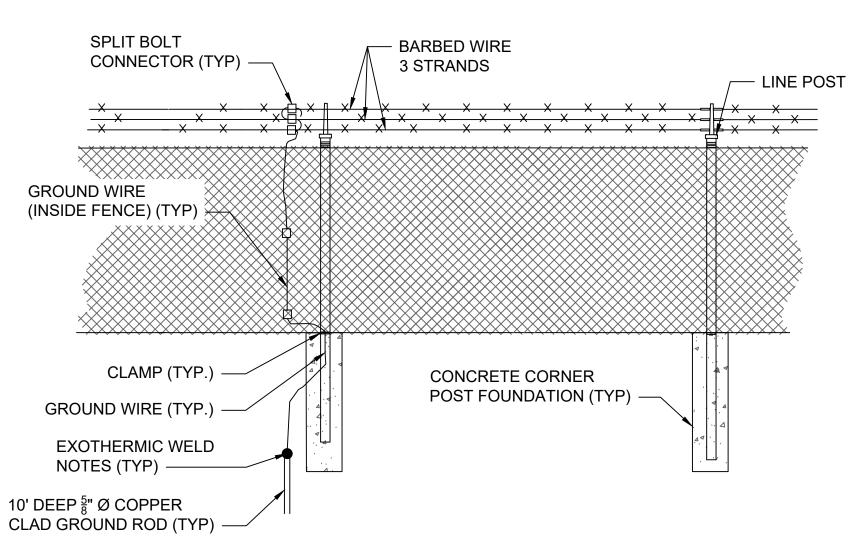

# **GROUNDING NOTES:**

GROUND ALL END POSTS, CORNER POSTS, PULL POSTS, AND GATE POSTS AS SHOWN IN THE GROUNDING ROD DETAIL. PLACE GROUND RODS AT LEAST EVERY 500 FEET ALONG THE FENCE LINE.

2. IMPEDANCE TO GROUND OF EACH GROUND ROD SHALL NOT EXCEED 25 OHMS PRIOR TO ESTABLISHING CONNECTION TO OTHER GROUND ROD ELECTRODES. THE FALL-OF-POTENTIAL GROUND IMPEDANCE TEST SHALL BE USED, S DESCRIBED IN THE ANSI/IEEE STANDARD 81 TO VERIFY THIS REQUIREMENT


3. ALL UNDERGROUND FENCE GROUNDING CONNECTIONS SHALL BE EXOTHERMIC. ALL ABOVE GROUND CONNECTIONS SHALL BE MECHANICAL

4. A GROUND ROD SHALL BE INSTALLED AT SPACING'S NO GREATER THAN 500 FEET, AND BONDED (MECHANICAL CLAMP) TO A FENCE POST WITH A #6 AWG SOLID COPPER CONDUCTOR.

5. INSTALL A BONDING STRAP FROM ANY GATE TO THE ADJACENT POST USING MECHANICAL CONNECTIONS. THE BONDING STRAP SHALL BE A 1 INCH BY 1/8 INCH FLEXIBLE TINNED COPPER BOND STRAP AND SHALL NOT RESTRICT THE FULL MOTION OF THE GATE.

CLAMP #6 AWG SOLID BARE COPPER CONDUCTOR FROM THE POSTS AT EACH SIDE OF THE GATE TO GROUND RODS INSTALLED AT EACH SIDE OF THE GATE. CONNECT THE CONDUCTOR TO THE GATEPOSTS AT A HEIGHT NO GREATER THAN ONE FOOT ABOVE GRADE.




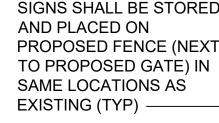

**TERMINAL BUILDING EXPANSION** 

SITE DETAILS 2

MAY 2025

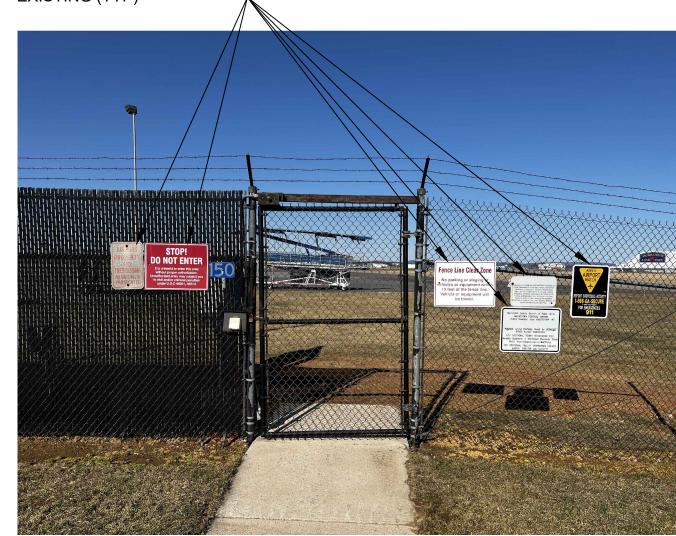

**FENCE SIGNS** CV5.2 SCALE: NTS

> CIVIL SHEET FAA ATP No.:3-24-0019-XX-2025

Bid No.: PUR-1751 MAA Grant No.: MAA-GR-XX-XXX SUBMISSION: **BID SET** SHEET No.: CV5.2

SGP-25-XXX

26 OF 102

6011 UNIVERSITY BLVD, SUITE 490 ELLICOTT CITY, MD 21043 TEL: 410.465.9600 FAX: 410.465.9602

CV5.2



**CERTIFICATION:** HEREBY CERTIFY THAT THESE DOCUMENTS WERE ME, AND THAT I AM A DULY ICENSED PROFESSIONAL JICENSE NO. 32705

PREPARED OR APPROVED BY ENGINEER UNDER THE LAWS OF THE STATE OF MARYLAND"

DESIGNED: B.J.D. DRAWN: J.A.A. CHECKED: V.J.D. EXPIRATION DATE: <u>2/21</u>/2026

DATE DESCRIPTION NO. 06/13/2025 ADDENDUM 3 APPROVED: R.N.M.




**HAGERSTOWN REGIONAL AIRPORT** 

SHEET TITLE:

N.A.

SCALE:

Washington County, MD

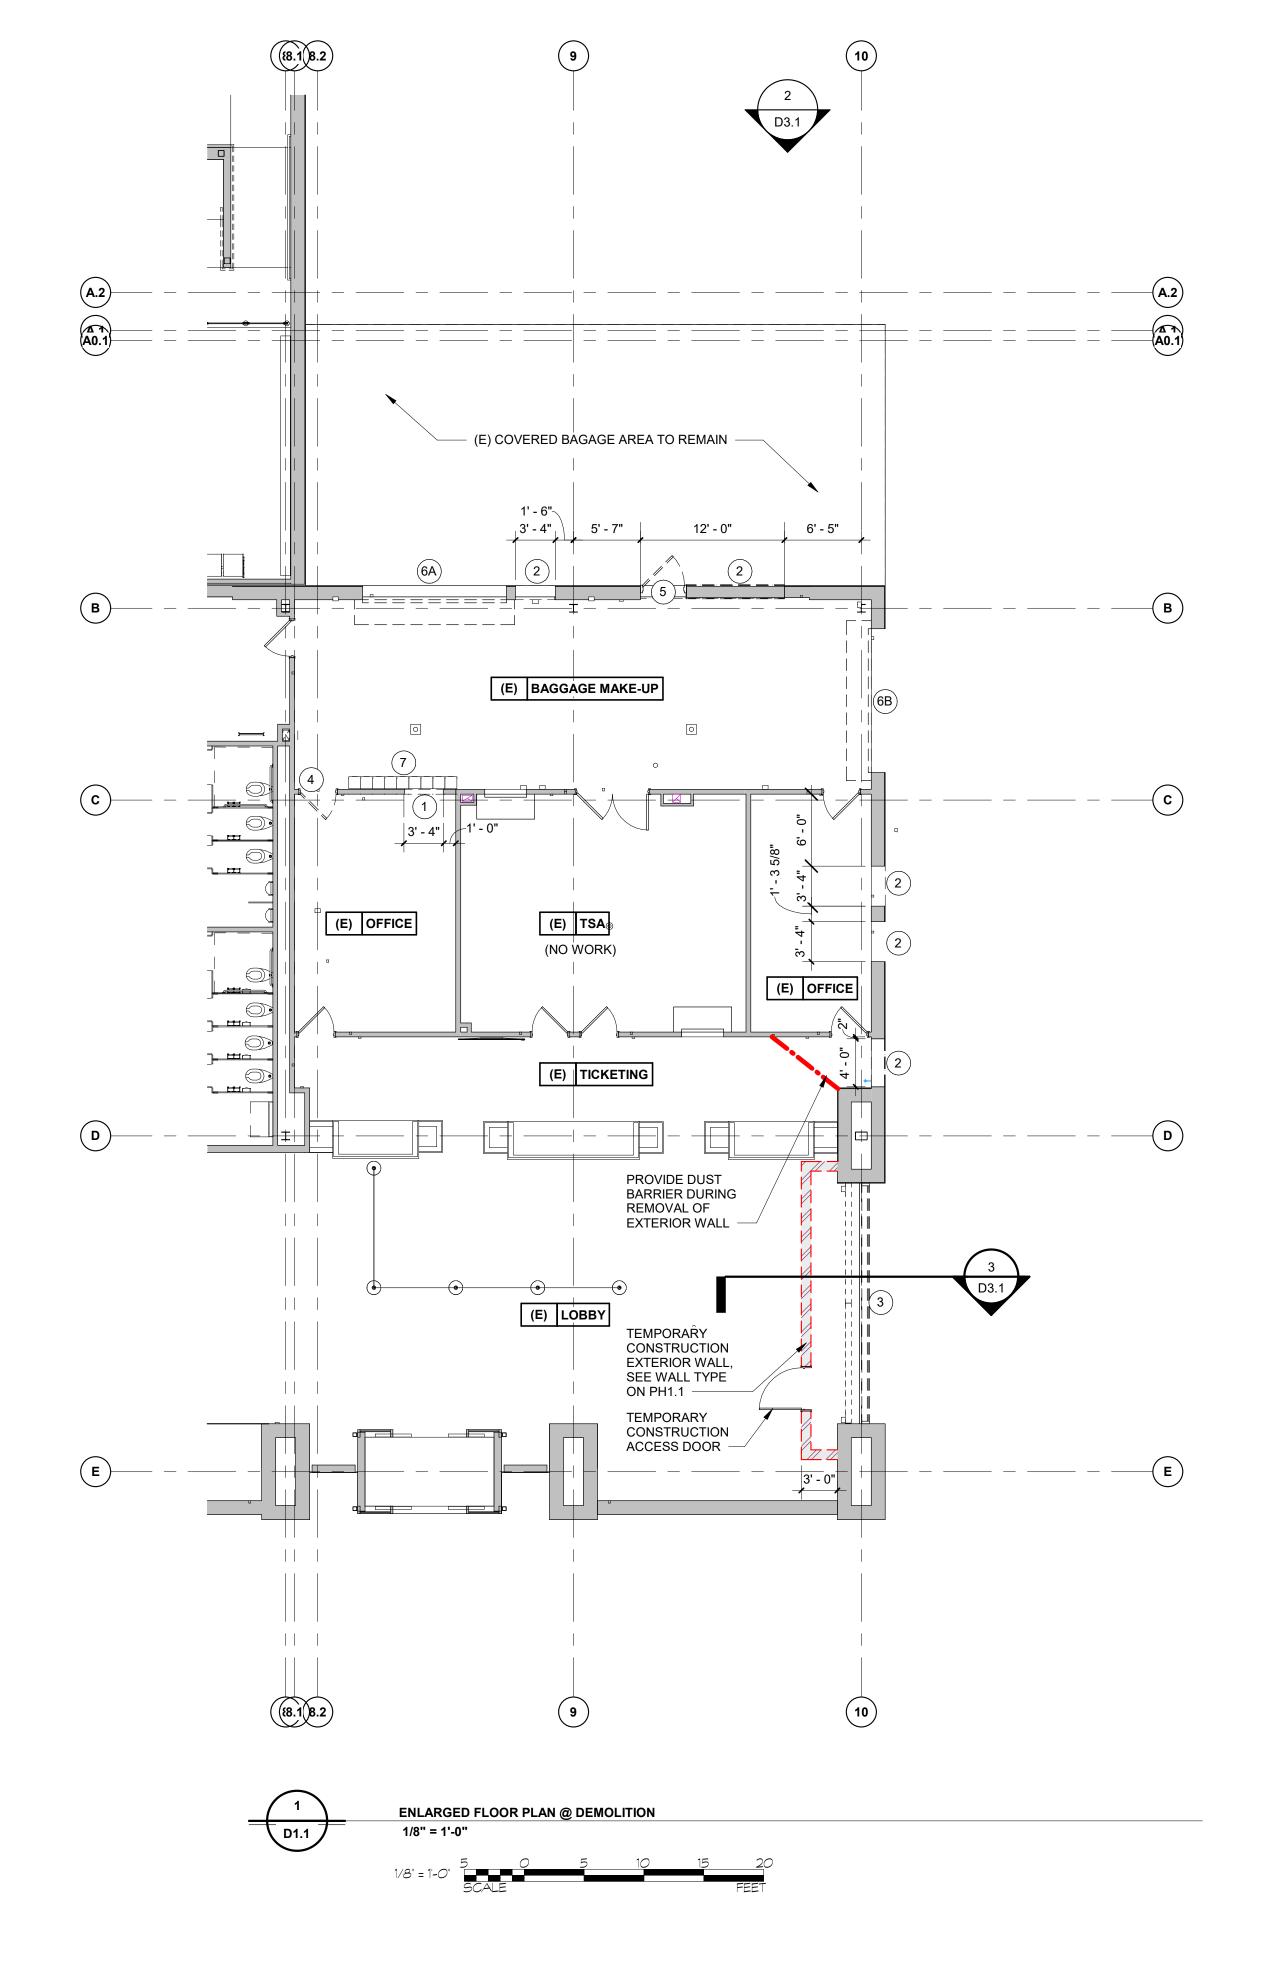

## **DEMOLITION LEGEND**

- METAL STUD AND GYPSUM BOARD WALLS TO BE REMOVED. (ADD ALTERNATE No. 1)
- PORTION OF EXISTING MASONRY TO BE REMOVED FOR NEW OPENING. PATCH & REPAIR ADJACENT FINISHES AS REQ'D. (BASE BID)
- 3 EXISTING ALUMINUM STOREFRONT TO BE REMOVED. (BASE BID)
- FLUSH WOOD DOORS AND HOLLOW METAL FRAMES TO BE REMOVED. (ADD ALTERNATE No. 1)
- 5 EXISTING HOLLOW METAL DOOR & FRAME TO BE REMOVED. (BASE BID)
- EXISTING OVERHEAD DOOR & ASSOCIATED HARDWARE & TRIM TO BE REMOVED & SAVED FOR REUSE. PATCH & REPAIR ADJACENT MATERIALS AS REQUIRED. (BASE BID)
- EXISTING OVERHEAD DOOR & ASSOCIATED HARDWARE & TRIM TO BE REMOVED. PATCH & REPAIR ADJACENT MATERIALS AS REQUIRED. (BASE BID)
- 7 REMOVE AND RELOCATE EXISTING LOCKERS. SEE 1/A1.3. (ADD ALTERNATE No. 1)





Expiration Date: 09/07/2026

rofessional Certification: nereby certify that these documents ere prepared or approved by me, and that I am a duly licensed professional engineer under the laws of the State of Maryland. License No. 6157

DESCRIPTION No. DATE DESIGNED: RAK Rev 1 06.17.2025 Revised (Addendum No. 3) DRAWN: RAK CHECKED: NEM APPROVED: NEM




PROJECT TITLE:	
	TERMINAL BUILDING EXPANSION
HEET TITLE:	
<b></b> \	II ADOED ELOOD DI ANI AT DEMOLITION

FAA AIP No.: 3-24-0019-XX-2025 Bid No.: PUR-1751 MAA Grant No.: MAA-GR-XX-XXX SUBMISSION: **BID SET** SHEET No.:

ENLARGED FLOOR PLAN AT DEMOLITION MAY 2025 As indicated

D1.1 **31** OF **102** 

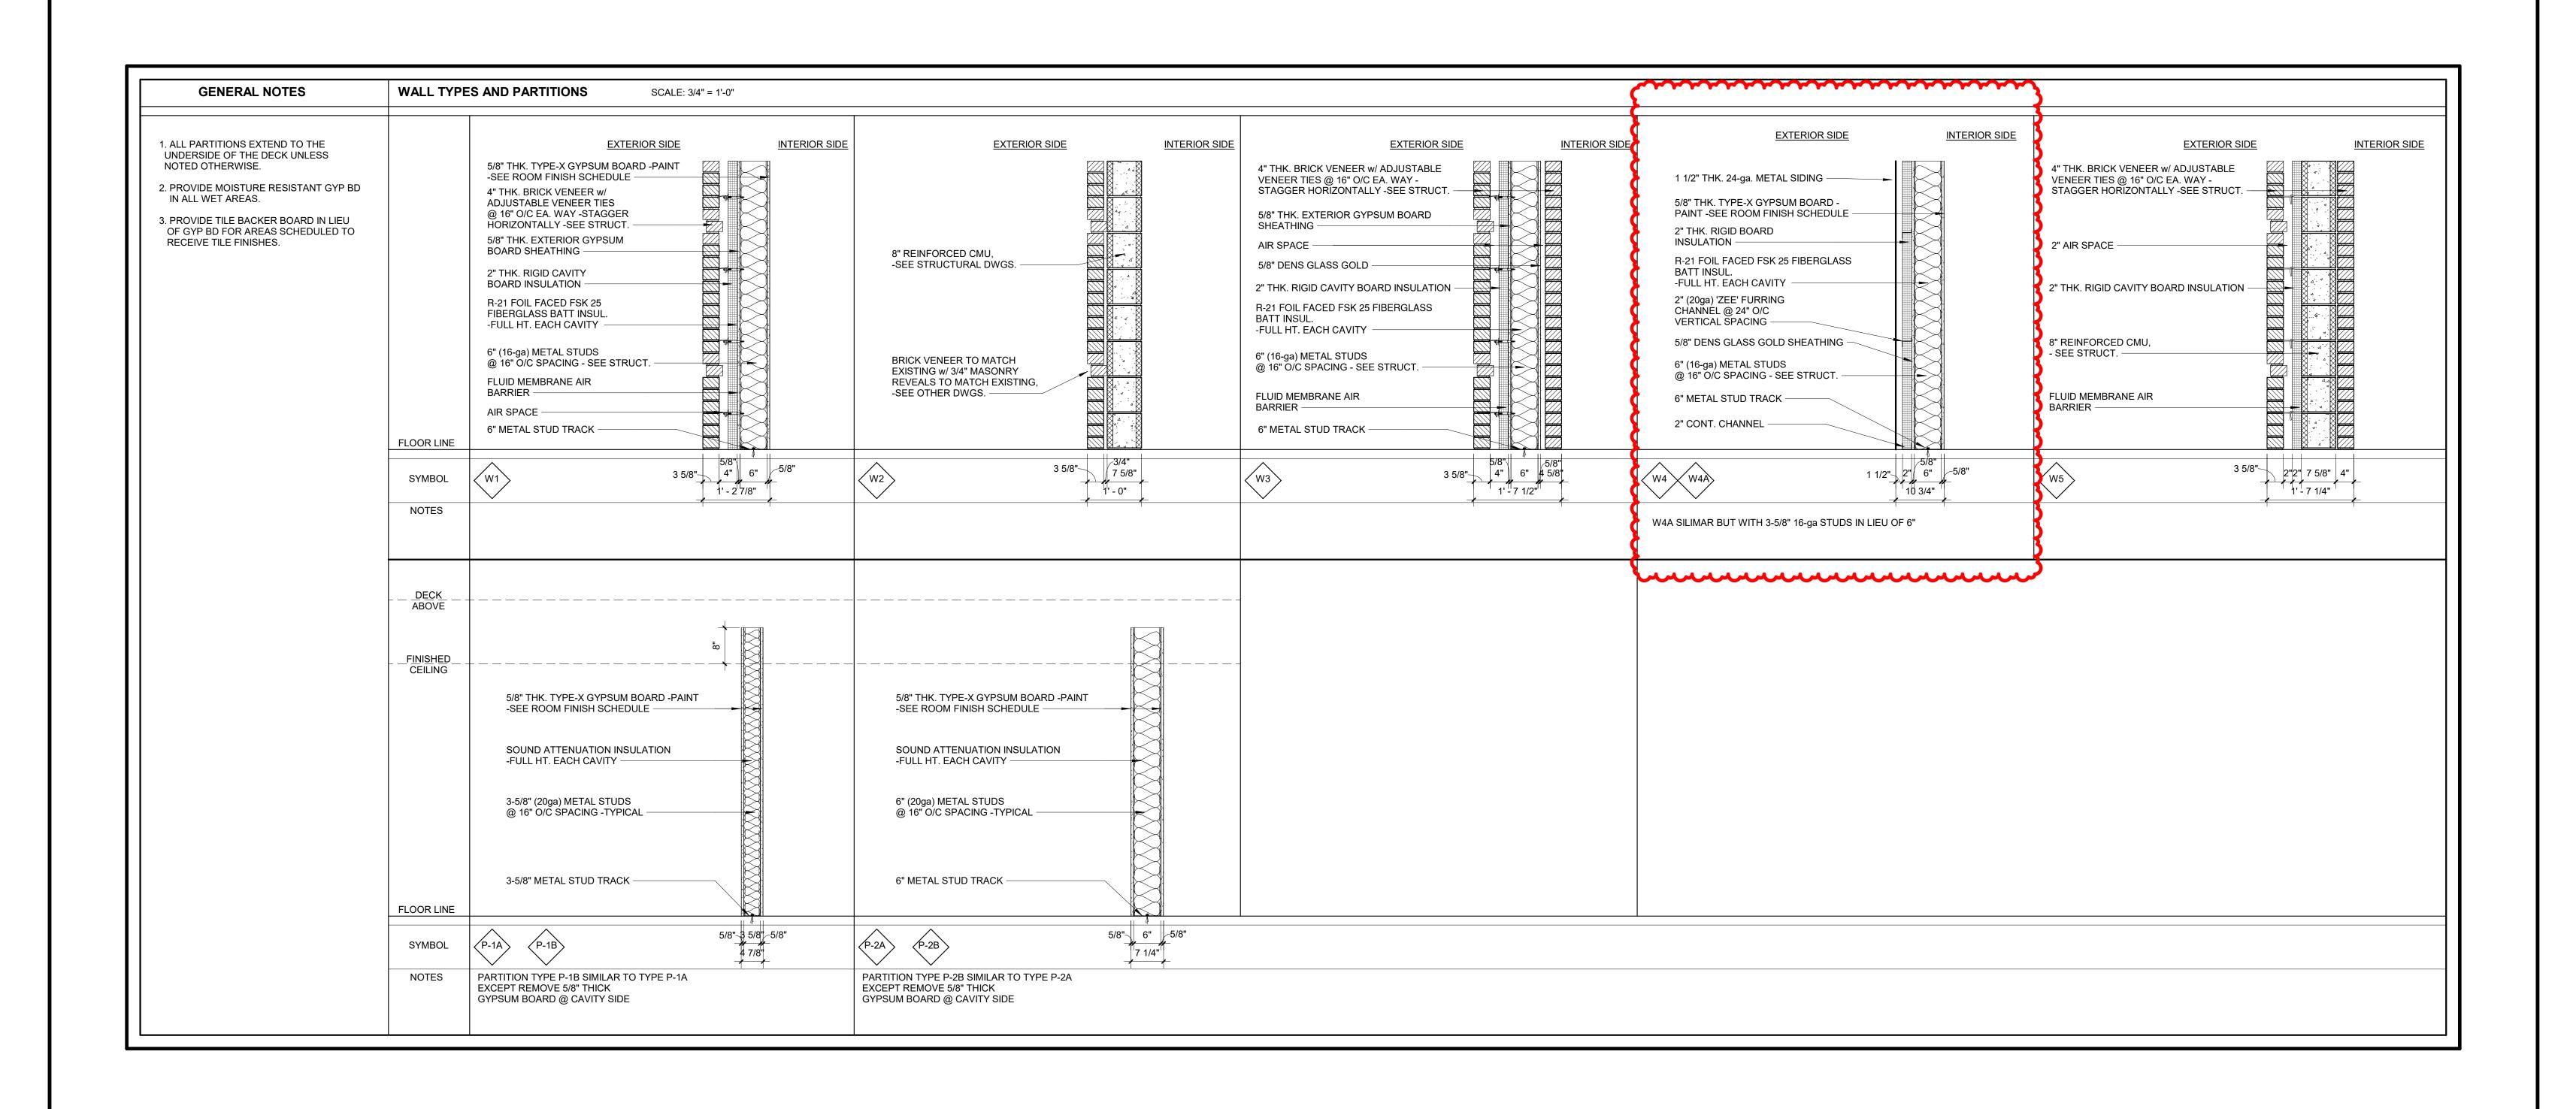





Professional Certification:

I hereby certify that these documents were prepared or approved by me, and that I am a duly licensed professional engineer under the laws of the State of Maryland.

License No. 6157

Expiration Date: 09/07/2026

DESIGNED: RAK

No. DATE
Rev 1 06.17.2025 Revised (Addendum No. 3)


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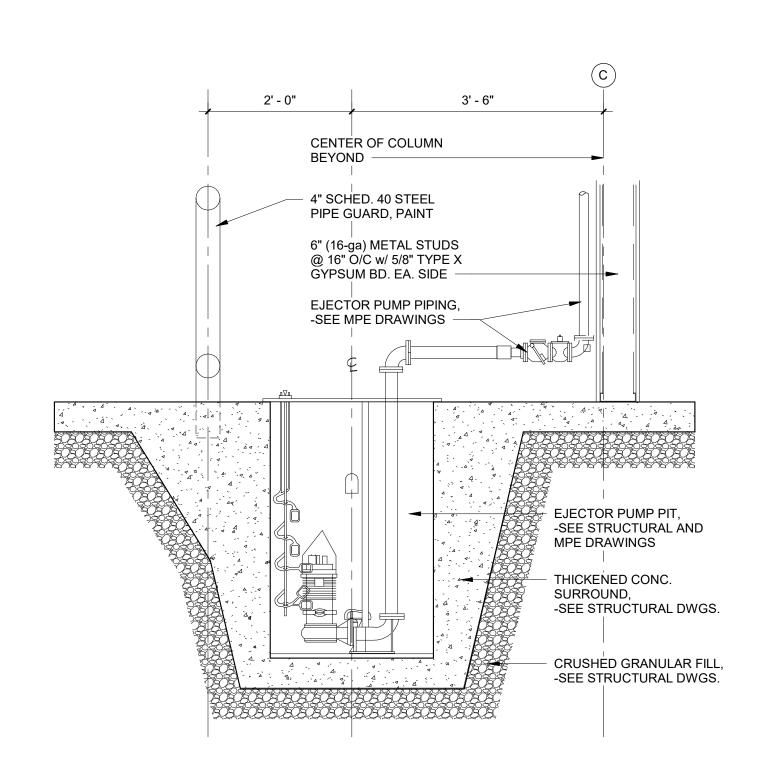
CHECKED: NEM

APPROVED: NEM





DJECT TITLE:	TERMINAL BUIL	DING EXPA	NSION	FAA AIP No.: 3-24-0019-XX-2025 Bid No.: PUR-1751 MAA Grant No.: MAA-GR-XX-XXX
ET TITLE:				SUBMISSION: BID SET
	PARTITI	ON TYPES		SHEET No.: A1.0
LE:	3/4" = 1'-0"	DATE:	MAY 2025	35 of 102




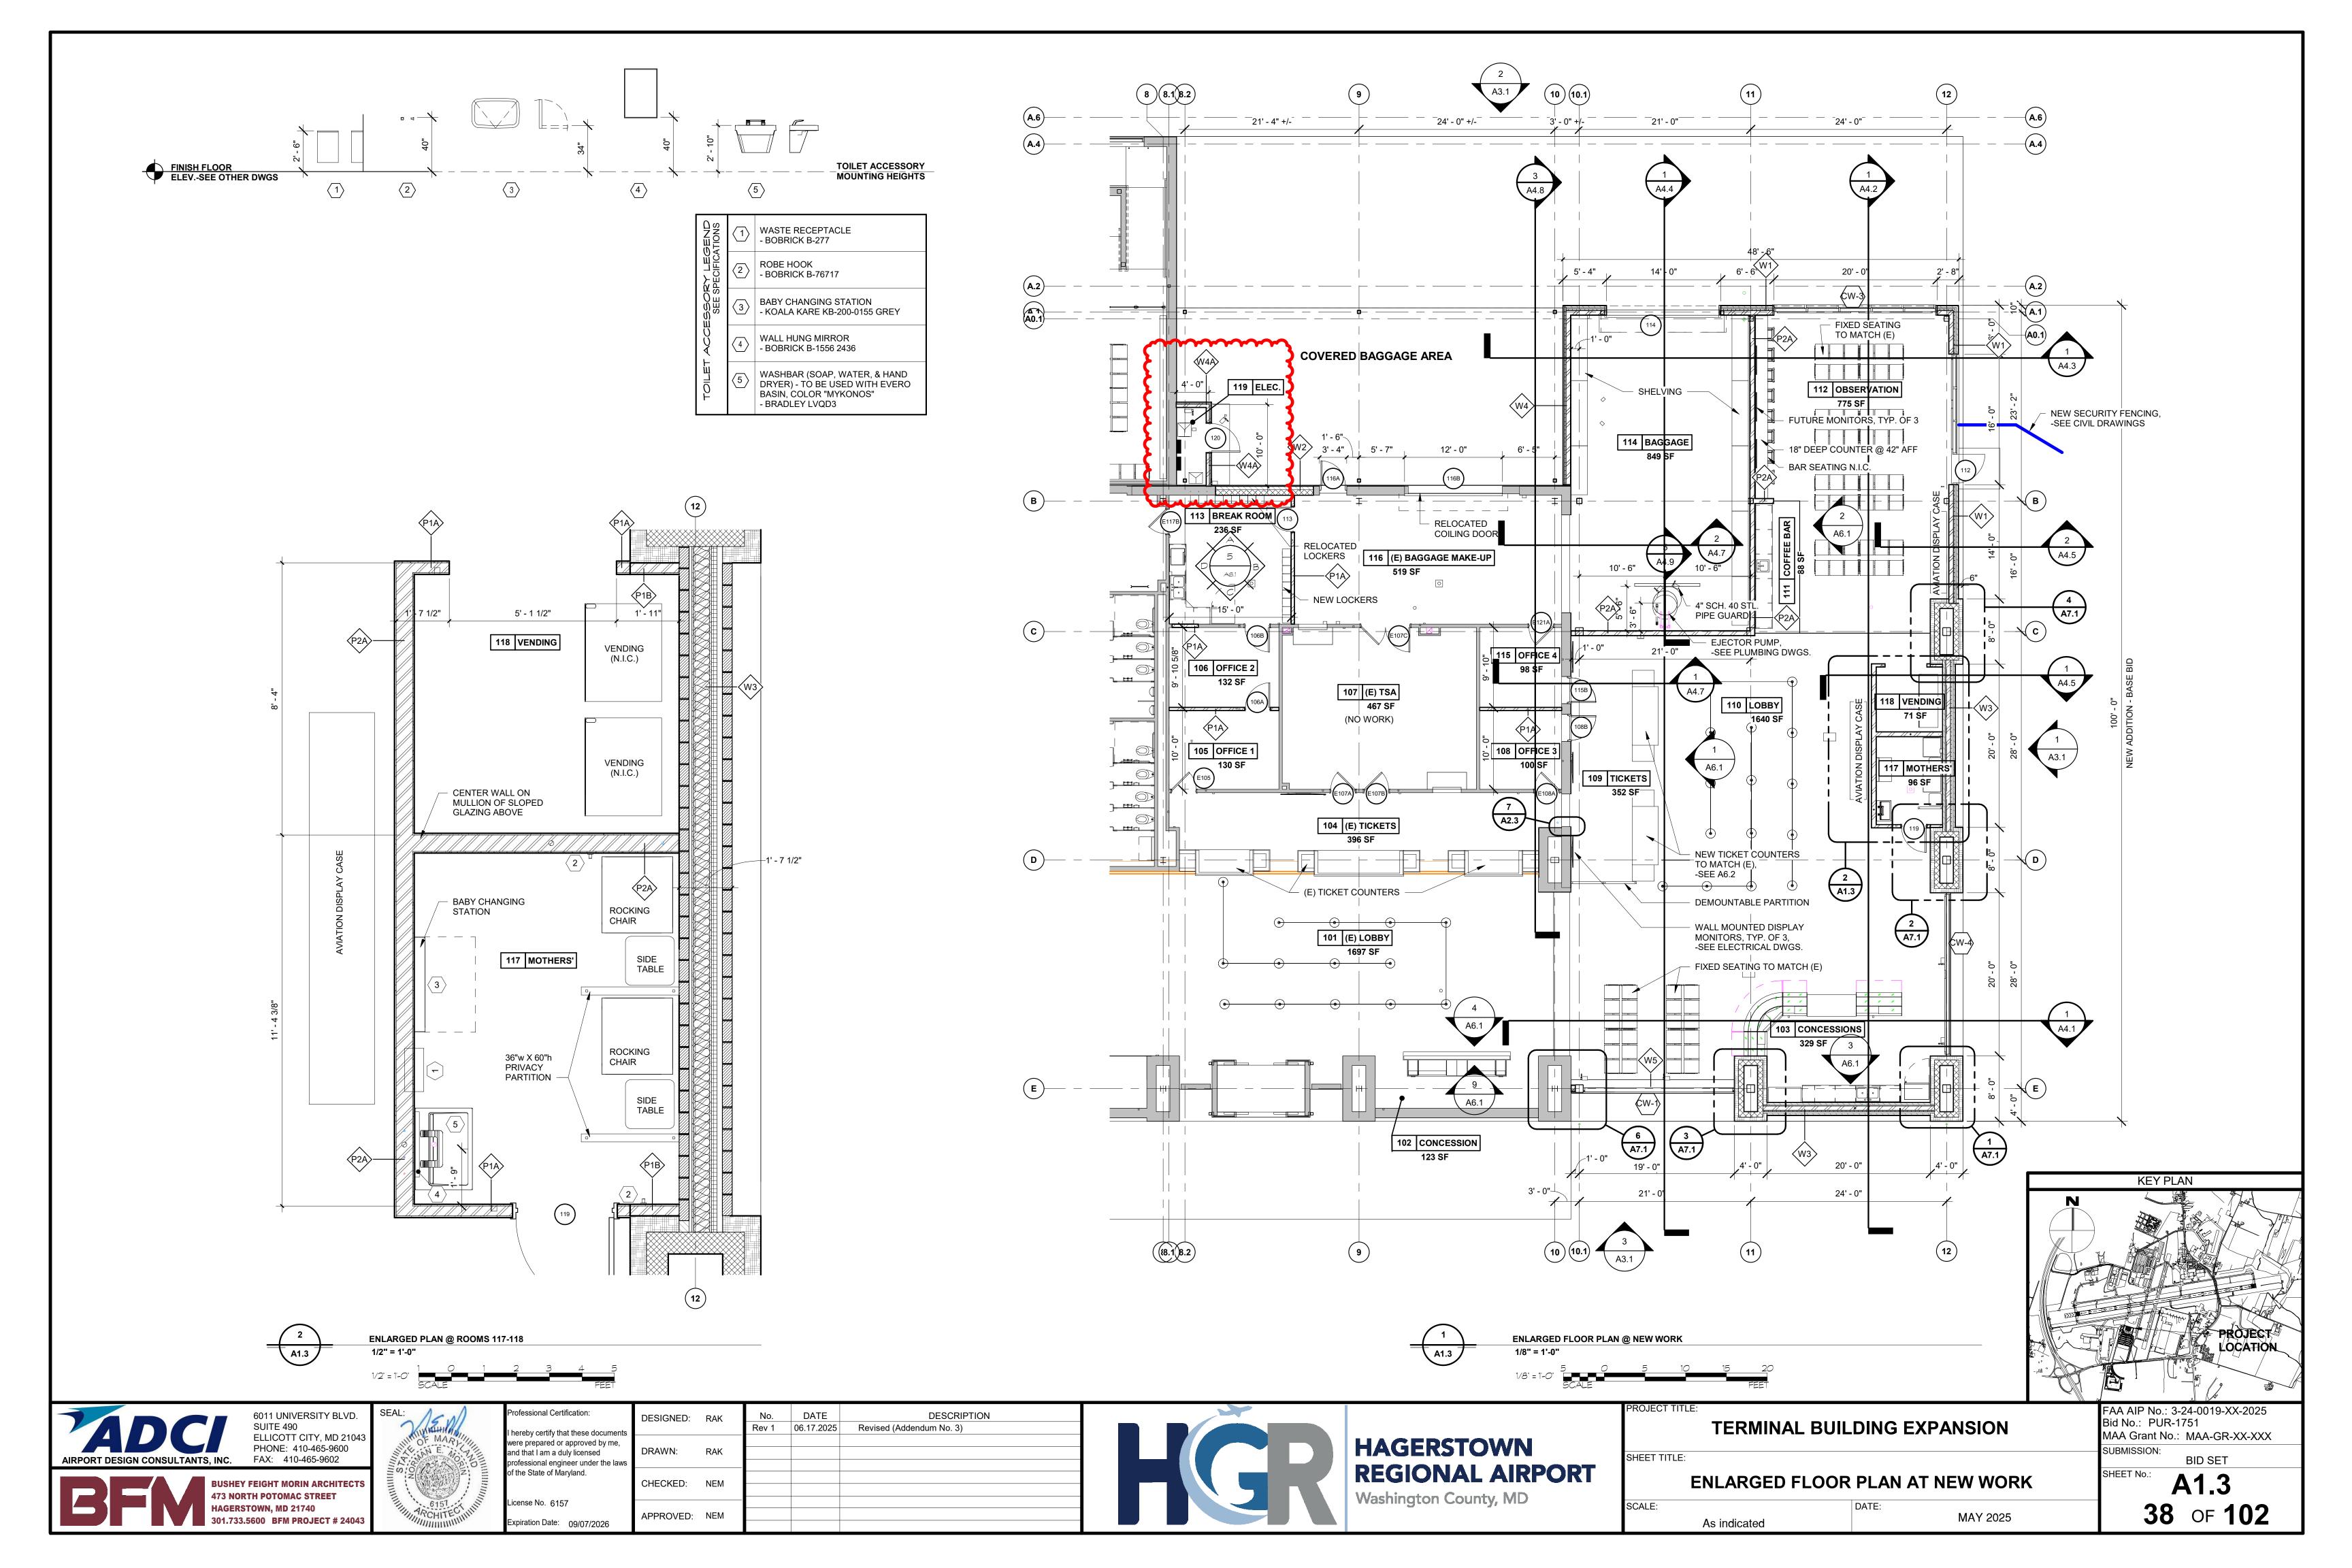





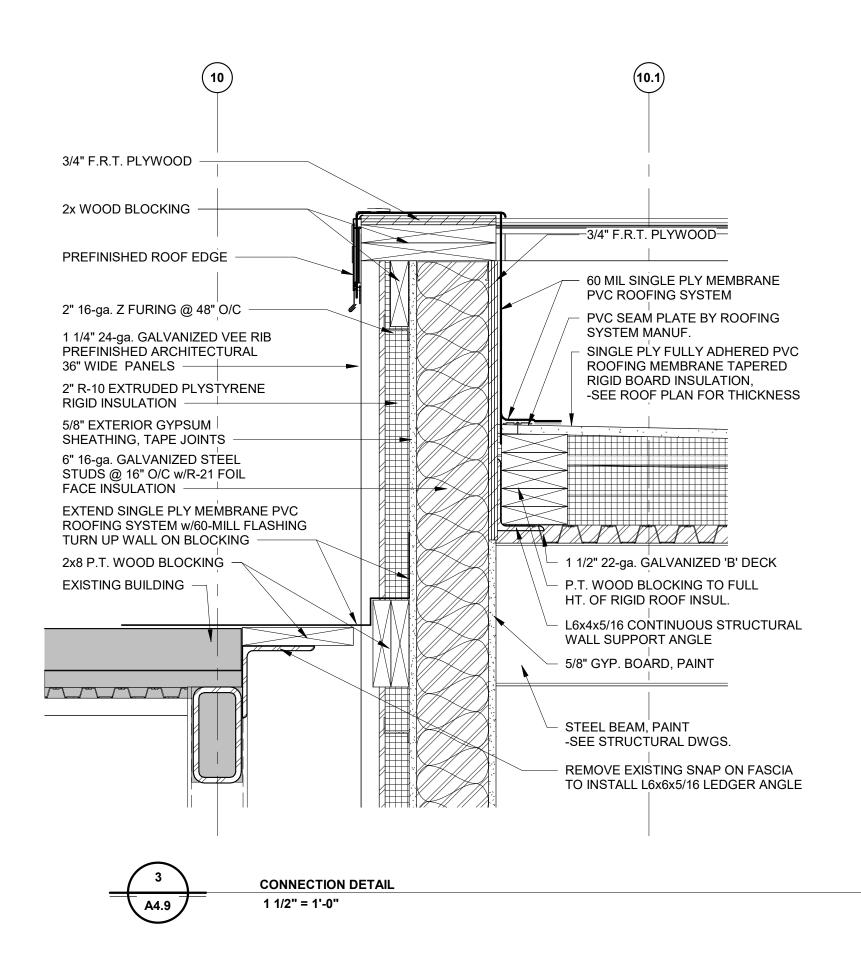

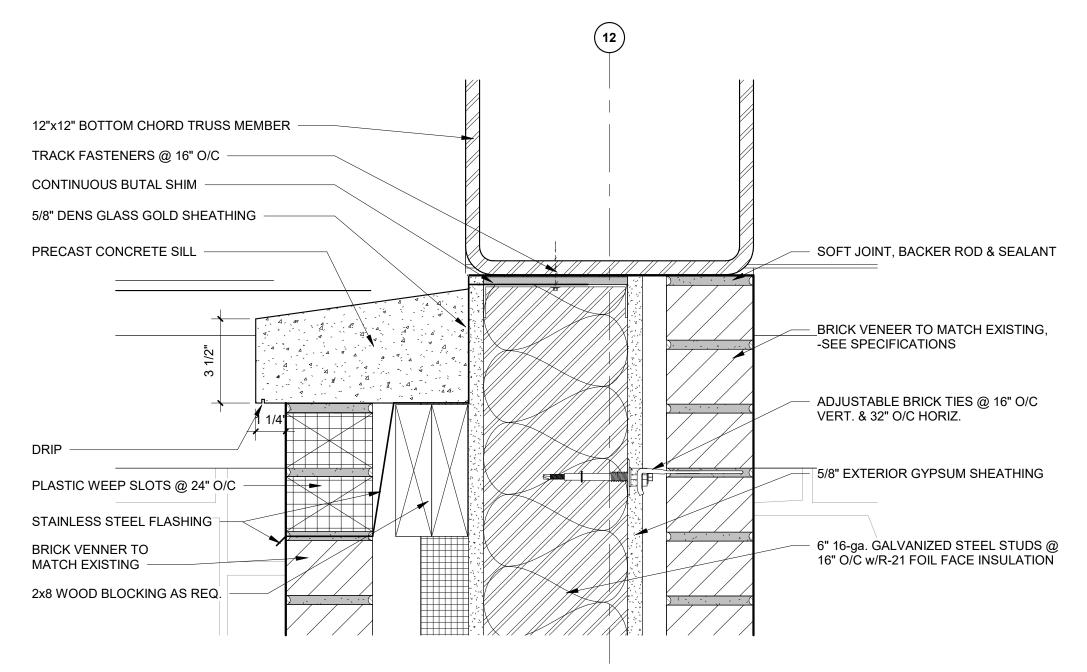

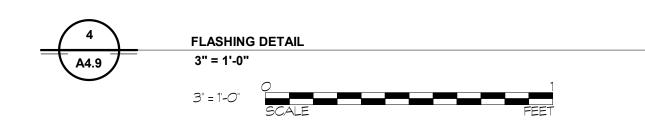

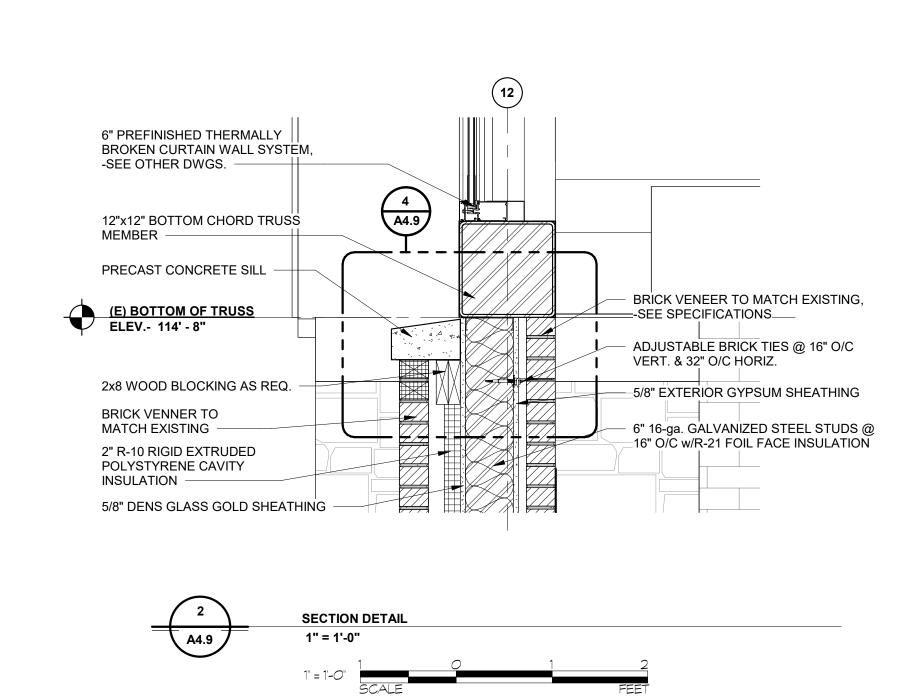

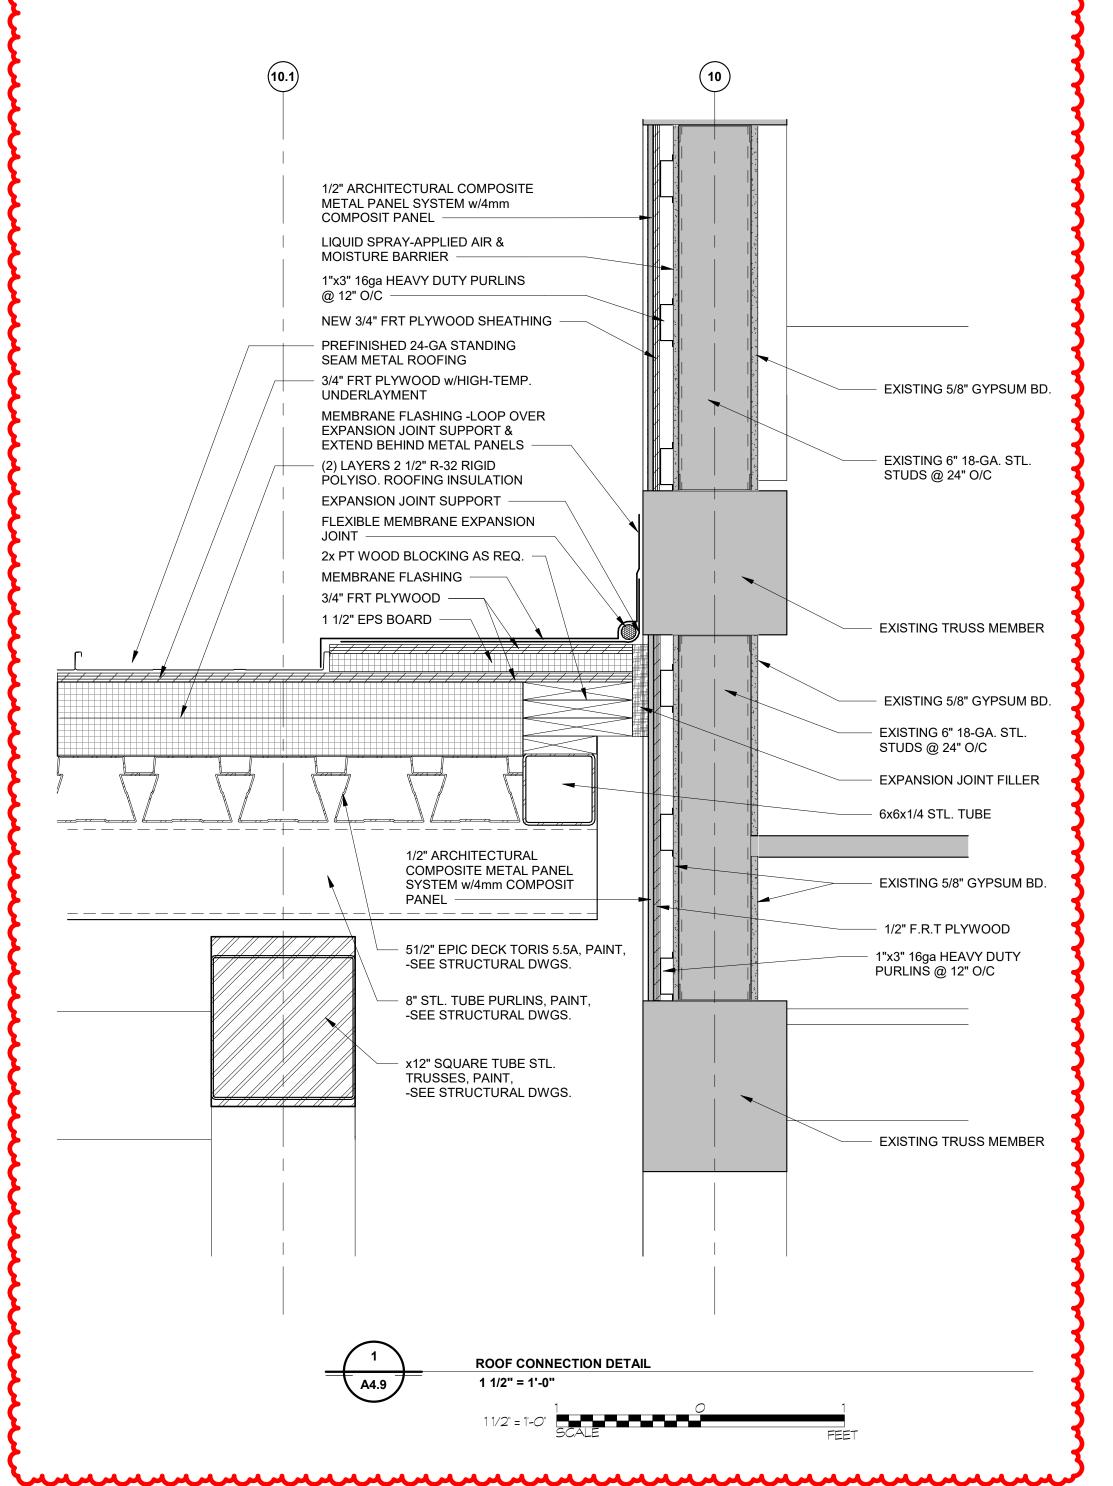



**473 NORTH POTOMAC STREET** 

301.733.5600 BFM PROJECT # 24043


License No. 6157

ofessional Certification: hereby certify that these documents were prepared or approved by me, and that I am a duly licensed professional engineer under the laws of the State of Maryland. Expiration Date: 09/07/2026

DATE DESCRIPTION DESIGNED: RAK Rev 1 06.17.2025 Revised (Addendum No. 3) DRAWN: RAK CHECKED: NEM APPROVED: NEM



PROJECT TITLE:	TERMINAL BUIL	DING EXPA	NSION	FAA AIP No.: 3-24-0019-XX-2025 Bid No.: PUR-1751 MAA Grant No.: MAA-GR-XX-XXX
SHEET TITLE:				SUBMISSION: BID SET
	SECTIO	N DETAILS		SHEET No.: <b>A4.9</b>
SCALE:	s indicated	DATE:	MAY 2025	<b>59</b> OF <b>102</b>
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# FOUNDATION PLAN

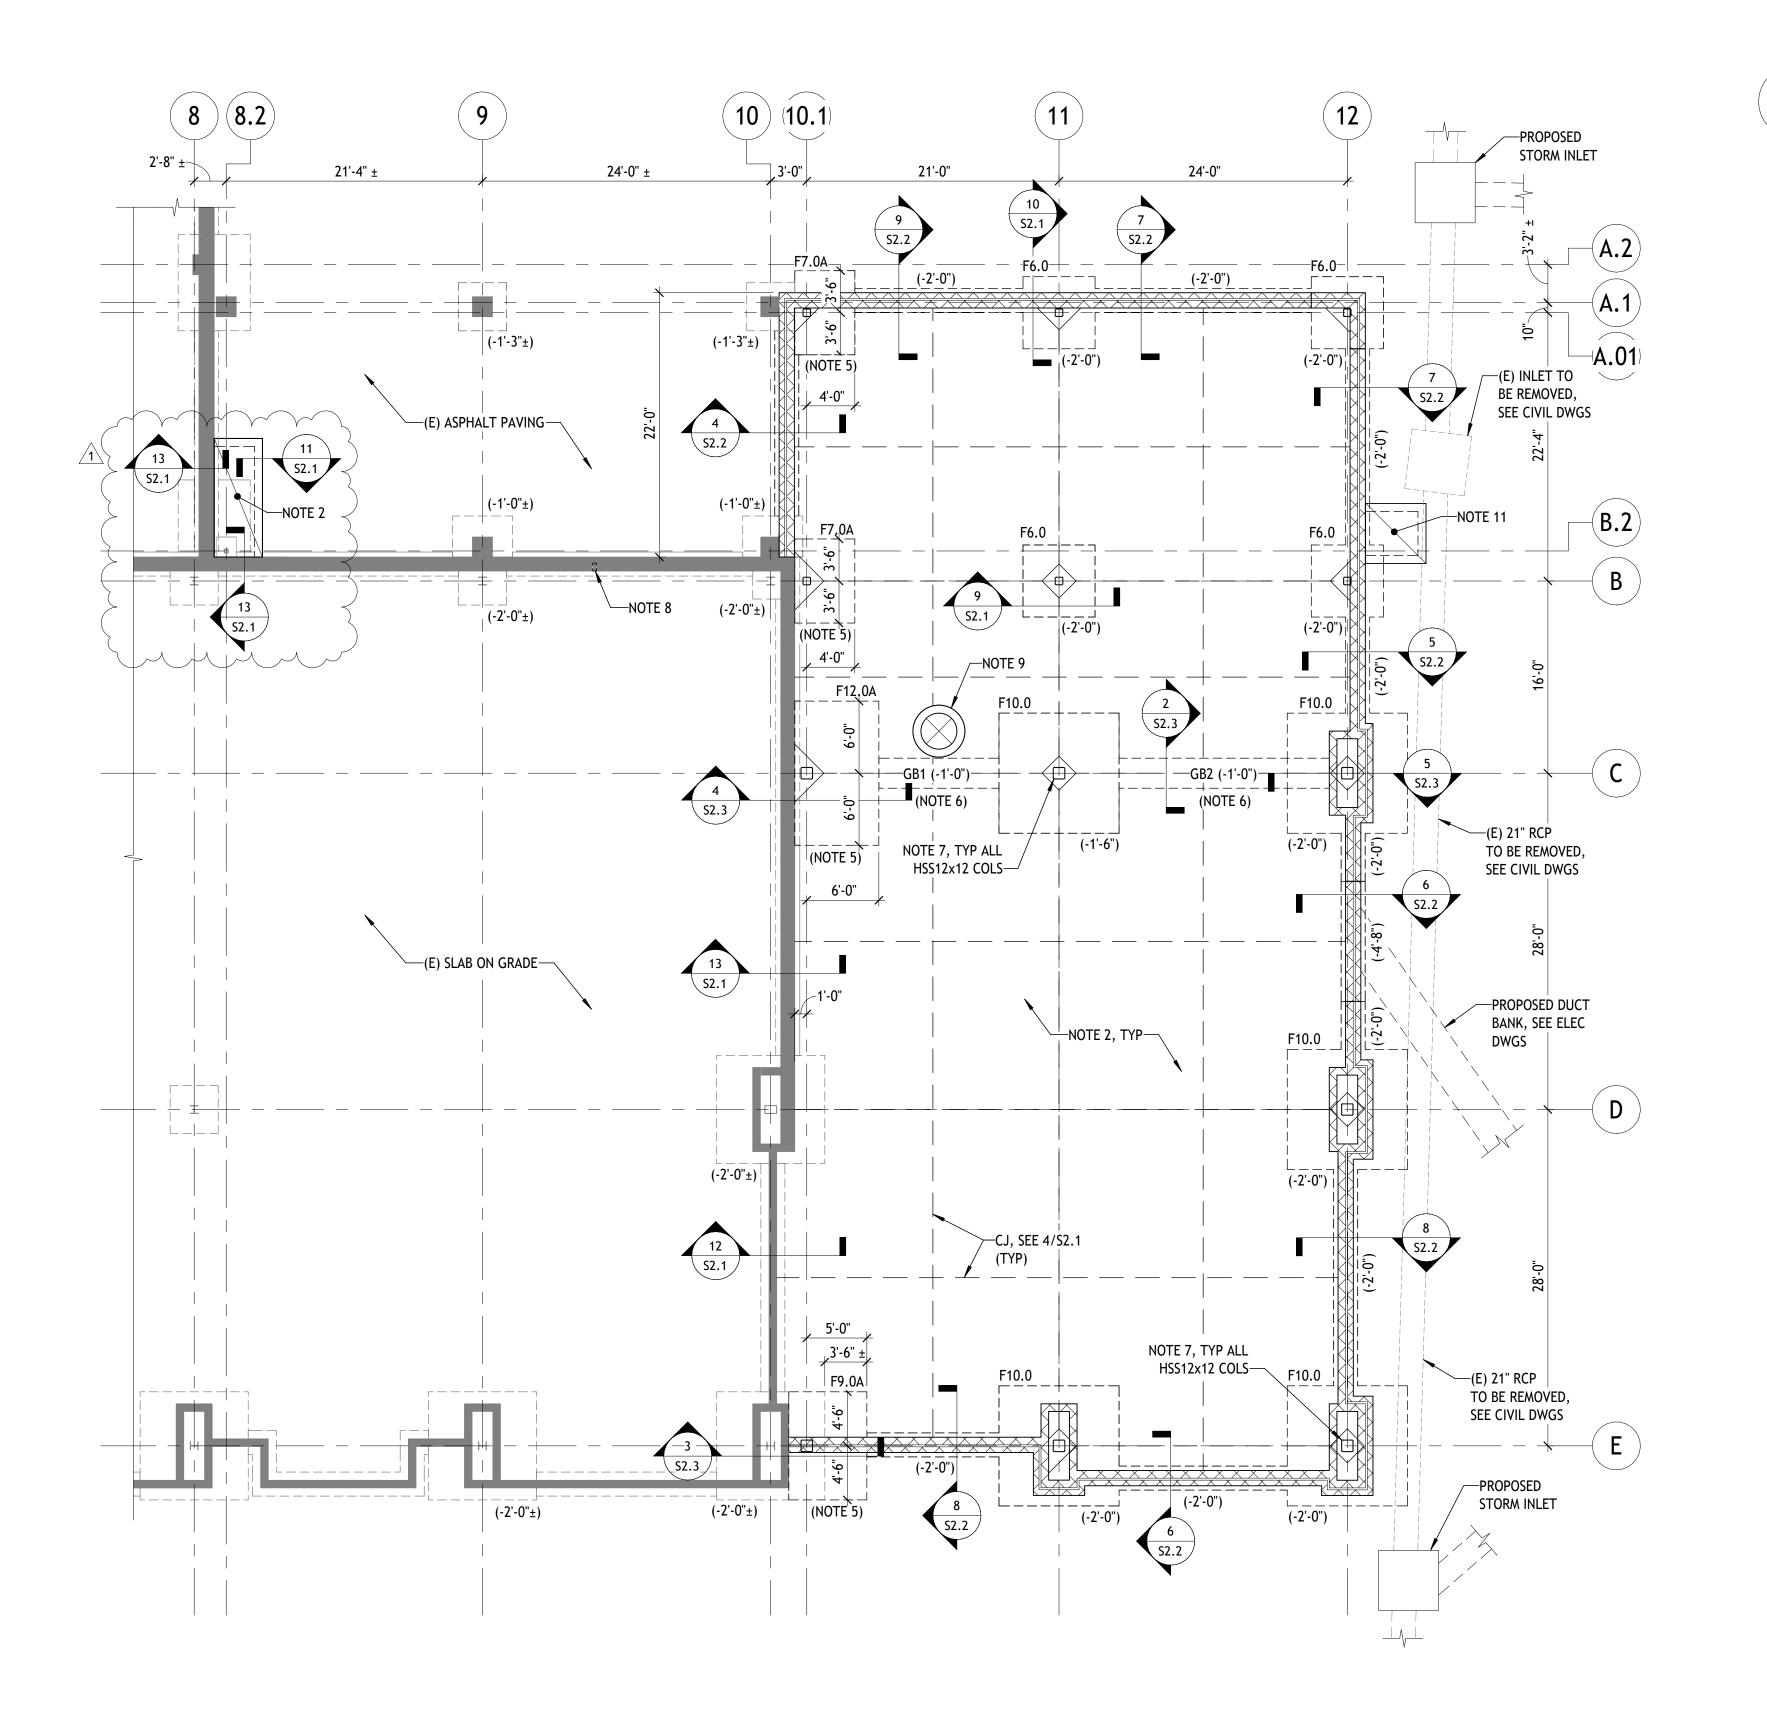1/8" = 1'-0"


PLAN NOTE

- SEE TYPICAL DETAILS FOR ADDITIONAL INFORMATION NOT SHOWN.
- 2. SLAB ON GRADE SHALL BE 5" THICK REINFORCED WITH 6"x6" W2.9/W2.9 WELDED WIRE REINFORCEMENT POURED OVER 10 MIL VAPOR BARRIER OVER 6" WASHED STONE AND COMPACTED SOIL IN ACCORDANCE WITH THE GEOTECHNICAL REPORT.
- 3. TYPICAL ELEVATIONS:
- REFERENCE ELEVATION MEASURED FROM GROUND FLOOR DATUM = (0'-0"), ACTUAL ELEVATION = 690.25'.
   TOP OF SLAB ELEVATION = (0'-0"), REFERENCED FROM DATUM
- TOP OF FOOTING ELEVATION = (-2'-0"), TYP UNO. TOP OF FOOTING ELEVATIONS THAT DIFFER FROM TYPICAL NOTED THUS:
- (XX'-XX"), REFERENCED FROM TOP OF SLAB ELEVATION
- 4. TYPICAL WALL FOOTING SHALL BE 2'-0" WIDE x 1'-0" THICK REINFORCED WITH (3) #5 CONTINUOUS BOTTOM BARS AND #4 BARS AT 24"OC IN THE TRANSVERSE DIRECTION (WF2.0), UNLESS NOTED OTHERWISE.
  5. BOTTOM OF NEW FOOTING ELEVATION TO MATCH EXISTING BOTTOM OF FOOTING ELEVATION. DO NOT
- UNDERMINE EXISTING FOOTING.

  6. REINFORCED CONCRETE GRADE BEAM WITH REBAR LAPPED WITH COLUMN FOOTING REINFORCING AT EACH
- END PER SCHEDULE ON 3/S2.2. GRADE BEAM SIZES ARE AS FOLLOWS:

  A. GB1 = 2'-6" WIDE x 2'-0" DEEP REINFORCED WITH (4) #6 CONT TOP AND BOTTOM AND (2) #5 AT MID DEPTH.
- PROVIDE #4 STIRRUPS AT 12" OC.
- B. GB2 = 2'-6" WIDE x 2'-6" DEEP REINFORCED WITH (4) #6 CONT TOP AND BOTTOM AND (2) #5 AT MID DEPTH. PROVIDE #4 STIRRUPS AT 12" OC.
- 7. ANCHOR REINFORCEMENT REQUIRED AT ALL HSS12x12 COLUMN FOOTINGS AND PIERS PER 1/S2.3.
- 8. COLUMN TO BE REMOVED. CUT COLUMN 4" BELOW FINISH FLOOR REMOVING ADJACENT CONCRETE SLAB ON GRADE AS REQUIRED. PATCH SLAB ON GRADE AND INFILL COLUMN WITH CONCRETE. SEE \$1.2 FOR ADDITIONAL COLUMN REMOVAL INSTRUCTIONS.
- 9. PIT FOR SEWAGE PUMP, SEE ARCHITECTURAL DRAWINGS FOR EXACT SIZE AND LOCATION. PROVIDE 8" CONCRETE PIT WALLS AND BASE REINFORCED WITH #4 AT 12" OC. PROVIDE (4) #5 x 4'-0" LONG RE-ENTRANT BARS IN SLAB ON GRADE AT PIT PERIMETER.
- 10. FOR COLUMN SCHEDULE, SEE S4.1.
- 11. PROVIDE 5'-0" x 5'-0" CONCRETE STOOP AT EXTERIOR DOOR. PROVIDE SLAB TURNDOWN PER DETAIL 11/S2.1. SEE NOTE 2 FOR SLAB THICKNESS AND REINFORCING.

FOUNDATION SCHEDULE									
AL	ALLOWABLE BEARING PRESSURE = 2,500 PSF								
MARK	SIZE	THICKNESS	REINFORCING						
F6.0	6'-0" x 6'-0"	1'-2"	(7) #5 EW T&B						
F7.0A	SEE PLAN	2'-0"	#6 AT 8" OC EW T&B						
F9.0A	SEE PLAN	2'-0"	#6 AT 8" OC EW T&B						
F10.0	10'-0" x 10'-0"	1'-6"	(9) #6 EW T&B						
F12.0A	SEE PLAN	2'-0"	#6 AT 8" OC EW T&B						

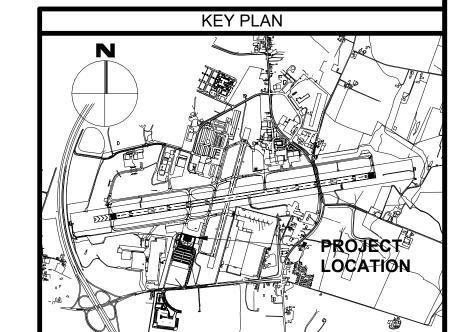





ENGINEERING CONSULTANTS, PC 410-921-7678 www.tarantinoec.com

Professional Certification:
I hereby certify that these documents were prepared or approved by me, and that I am a duly licensed professional engineer under the laws of the State of Maryland.

DESIGNED: MJM	No. DATE	DESCRIPTION
Rev 1	06.17.2025	Revised (Addendum No. 3)
DRAWN: MJM	DRAWN: MJM	
CHECKED: CRF	CHECKED: CRF	
License No. 57724		
Expiration Date: 06/06/2027		
APPROVED: BTS	DESCRIPTION	
Rev 1	06.17.2025	Revised (Addendum No. 3)
APPROVED: BTS	DESCRIPTION	
Rev 1	06.17.2025	Revised (Addendum No. 3)
APPROVED: BTS	DESCRIPTION	
Rev 1	06.17.2025	Revised (Addendum No. 3)
APPROVED: BTS	DESCRIPTION	
Rev 1	06.17.2025	Revised (Addendum No. 3)
APPROVED: BTS	DESCRIPTION	
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TERMINAL BUILDING EXPANSION

SHEET TITLE:

SCALE:

1/8" = 1'-0"


FOUNDATION PLAN

DATE:

MAY 2025

FAA AIP No.: 3-24-0019-XX-2025
Bid No.: PUR-1751
MAA Grant No.: MAA-GR-XX-XXX
SUBMISSION:
BID SET

\$1.1 70 of 102

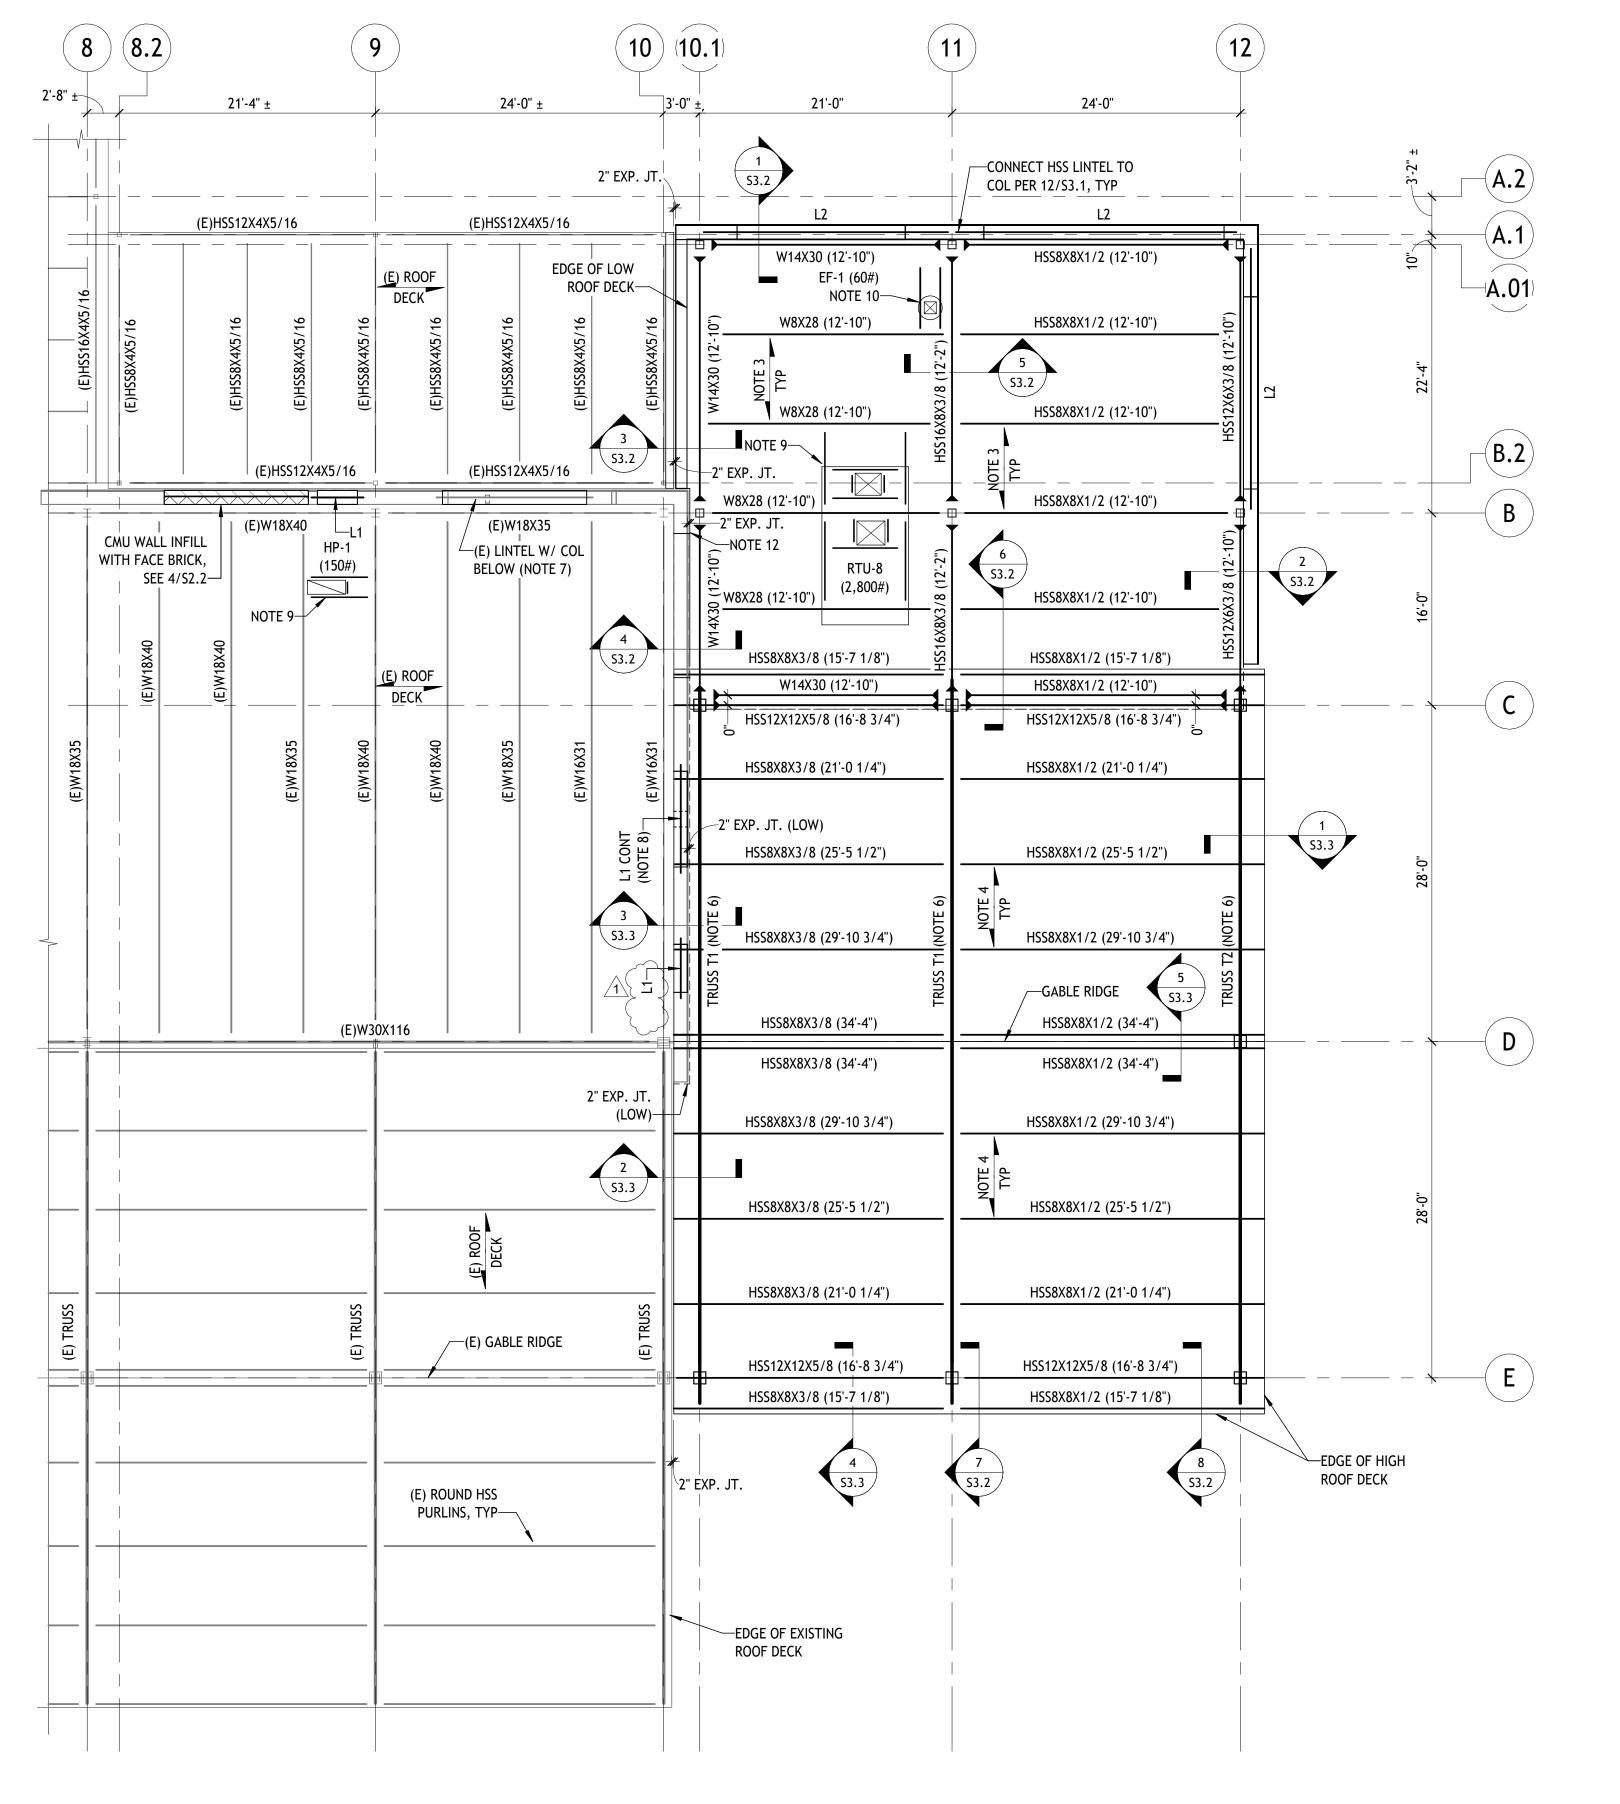



# ROOF FRAMING PLAN

DI AN NO

PLAN NOT


- 1. REFERENCE ELEVATION MEASURED FROM TOP OF SLAB ON GRADE DATUM = (0'-0"). SEE S1.1 FOR ACTUAL TOP OF SLAB ON GRADE ELEVATION.
- ELEVATIONS ARE NOTED AS FOLLOWS, MEASURED FROM THE REFERENCE ELEVATION (X'-X") INDICATES TOP OF STEEL/BOTTOM OF DECK.
- 3. TOP OF LOW ROOF DECK = (+13'-7 1/2"). STRUCTURAL ROOF SHALL CONSIST OF TORIS 5.5A x 20 GA ACOUSTIC
- ROOF DECK, BY EPIC METALS. SEE DETAIL 5/S3.1 FOR DECK ATTACHMENT.

  4. TOP OF GABLE ROOF DECK VARIES. STRUCTURAL ROOF SHALL CONSIST OF TORIS 5.5A x 20 GA ACOUSTIC ROOF
- DECK, BY EPIC METALS. SEE DETAIL 5/S3.1 FOR DECK ATTACHMENT.
- 5. NOTATIONS ON THE PLANS DESIGNATE THE FOLLOWING:
- BEAM TO COLUMN OR GIRDER FULLY DEVELOPED MOMENT CONNECTION.

  LINTEL MARK, SEE SCHEDULE ON 13/S3.1.
- 6. TRUSSES T1 & T2 CONSISTS OF HSS12X12 CHORD AND WEB MEMBERS. SEE SHEET S3.4 FOR TRUSS PROFILES, DIMENSIONS, AND WORKING POINTS. TRUSSES ARE CLASSIFIED AS ARCHITECTURALLY EXPOSED STRUCTURAL
- STEEL (AESS), SEE GENERAL NOTES AND PROJECT SPECIFICATIONS FOR ADDITIONAL INFORMATION.

  7. FIELD VERIFY (E) LINTEL W8x15 INTACT WITH 8" MIN BEARING AT EACH END PRIOR TO COLUMN REMOVAL. GRIND SMOOTH UNDERSIDE OF LINTEL AT COLUMN CONNECTION. SEE S1.1 FOR ADDITIONAL COLUMN REMOVAL
- 8. REMOVE EXISTING WALL AND REBUILD PIER BETWEEN ADJACENT OPENINGS. PROVIDE L1 LINTEL CONTINOUS
- OVER PIER PER NOTE 7.

  9. PROVIDE ANGLE FRAME BELOW MECHANICAL EQUIPMENT PER 8/S3.1. SEE NOTE 11.
- 10. REINFORCE DECK AT FAN OPENING PER 10/3.1. SEE NOTE 11.
- 11. MAXIMUM ROOFTOP EQUIPMENT WEIGHTS SHOWN ON PLAN. IF ACTUAL WEIGHT EXCEEDS THAT SHOWN, CONTACT ENGINEER OF RECORD FOR FURTHER REVIEW PRIOR TO PURCHASE AND INSTALLATION.
- 12. CRACKING IN EXISTING BRICK VENEER. REMOVE AND REPLACE CRACKED BRICK UNITS AND POINT MORTAR JOINTS AS REQUIRED.

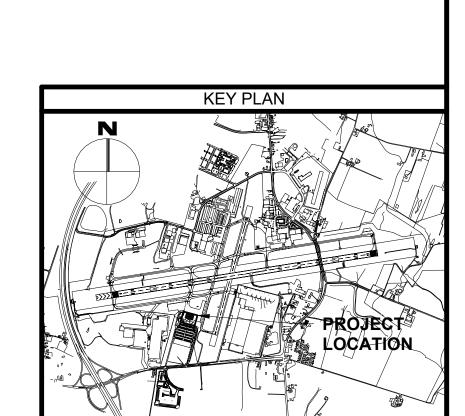





Professional Certification:	DESIGNED:	MJM	No.	DATE	DESCRIPTION
I hereby certify that these documents	3 2 3 1 3 1 1 2 1		Rev 1	06.17.2025	Revised (Addendum No. 3)
were prepared or approved by me, and that I am a duly licensed professional engineer under the laws	DRAWN:	MJM			
of the State of Maryland.	CHECKED:	CRF			
License No. 57724  Expiration Date: 06/06/2027	APPROVED:	BTS			



	TERMINAL BUILDING EXPANSION	
T TITLE:		


ROOF FRAMING PLAN

DATE:


MAY 2025


FAA AIP No.: 3-24-0019-XX-2025
Bid No.: PUR-1751
MAA Grant No.: MAA-GR-XX-XXX
SUBMISSION:
BID SET
SHEET No.:
SHEET No.:
S1.2


**71** OF **102** 

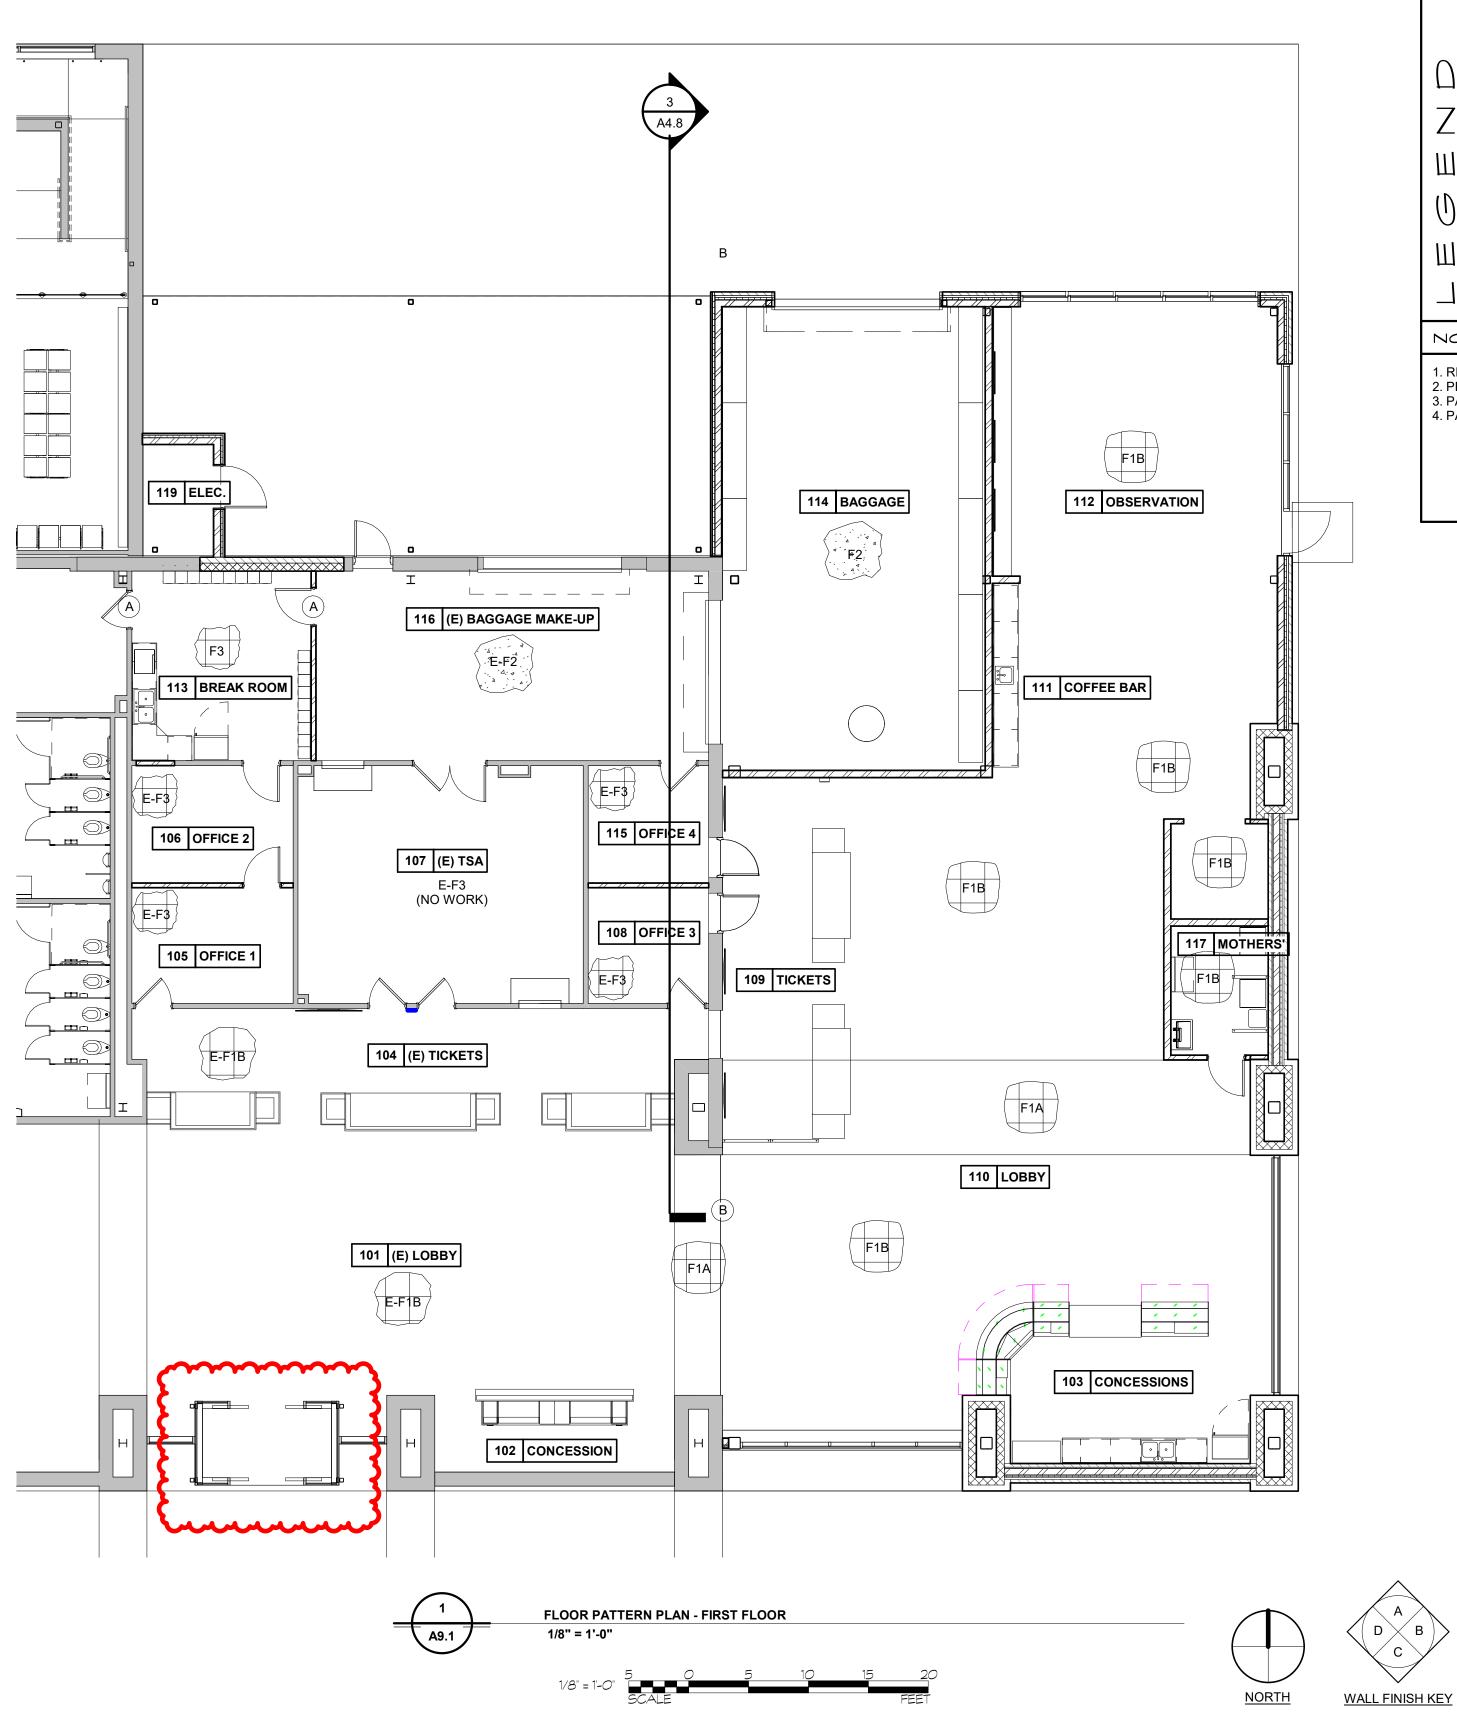





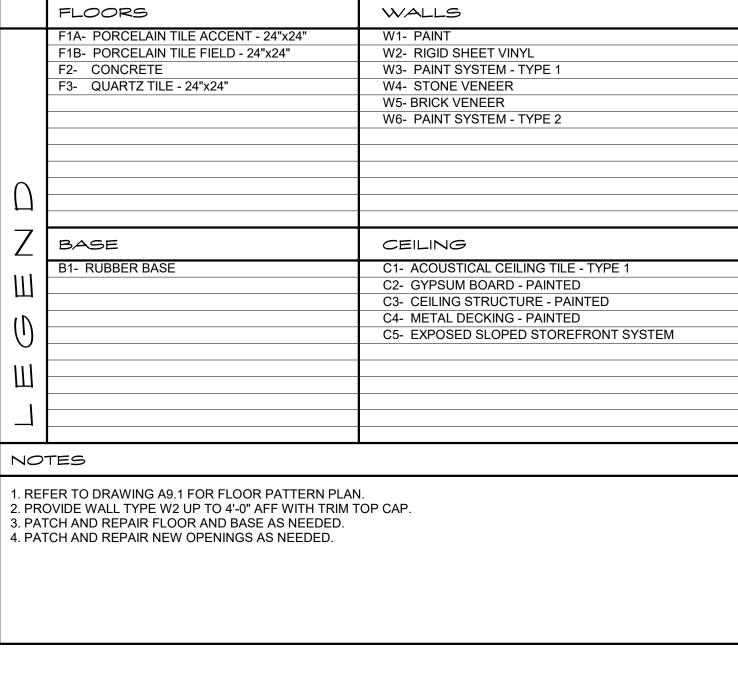

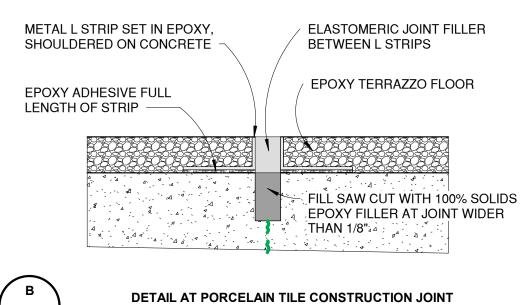

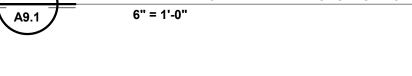

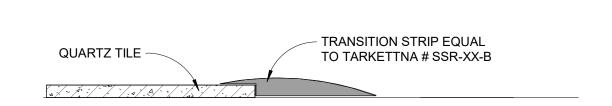

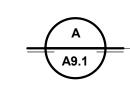

TRANSITION DETAIL QUARTZ TO CONCRETE 12" = 1'-0"



6011 UNIVERSITY BLVD.

301.733.5600 BFM PROJECT # 24043




rofessional Certification: hereby certify that these documer ere prepared or approved by me, and that I am a duly licensed professional engineer under the law of the State of Maryland. License No. 6157


Professional Certification:	DESIGNED:	RAK	No.	DATE	DESCRIPTION
I hereby certify that these documents			Rev 1	06.12.2025	Revised (Addendum No. 2)
were prepared or approved by me,					
and that I am a duly licensed	DRAWN:	RAK			
professional engineer under the laws					
of the State of Maryland.	CHECKED: NEM	NEM			
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License No. 6157					
	APPROVED:	NEM			
Expiration Date: 09/07/2026					
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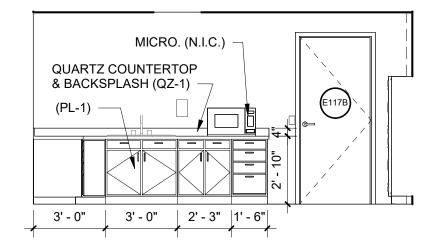
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HEET TITLE:			SUBMISSION: BID SET
	FLOOR PATT	ERN PLAN -FIRST FLOOR	SHEET No.: A9.1
CALE:	As indicated	DATE: MAY 2025	66 OF 102


# Attachment E






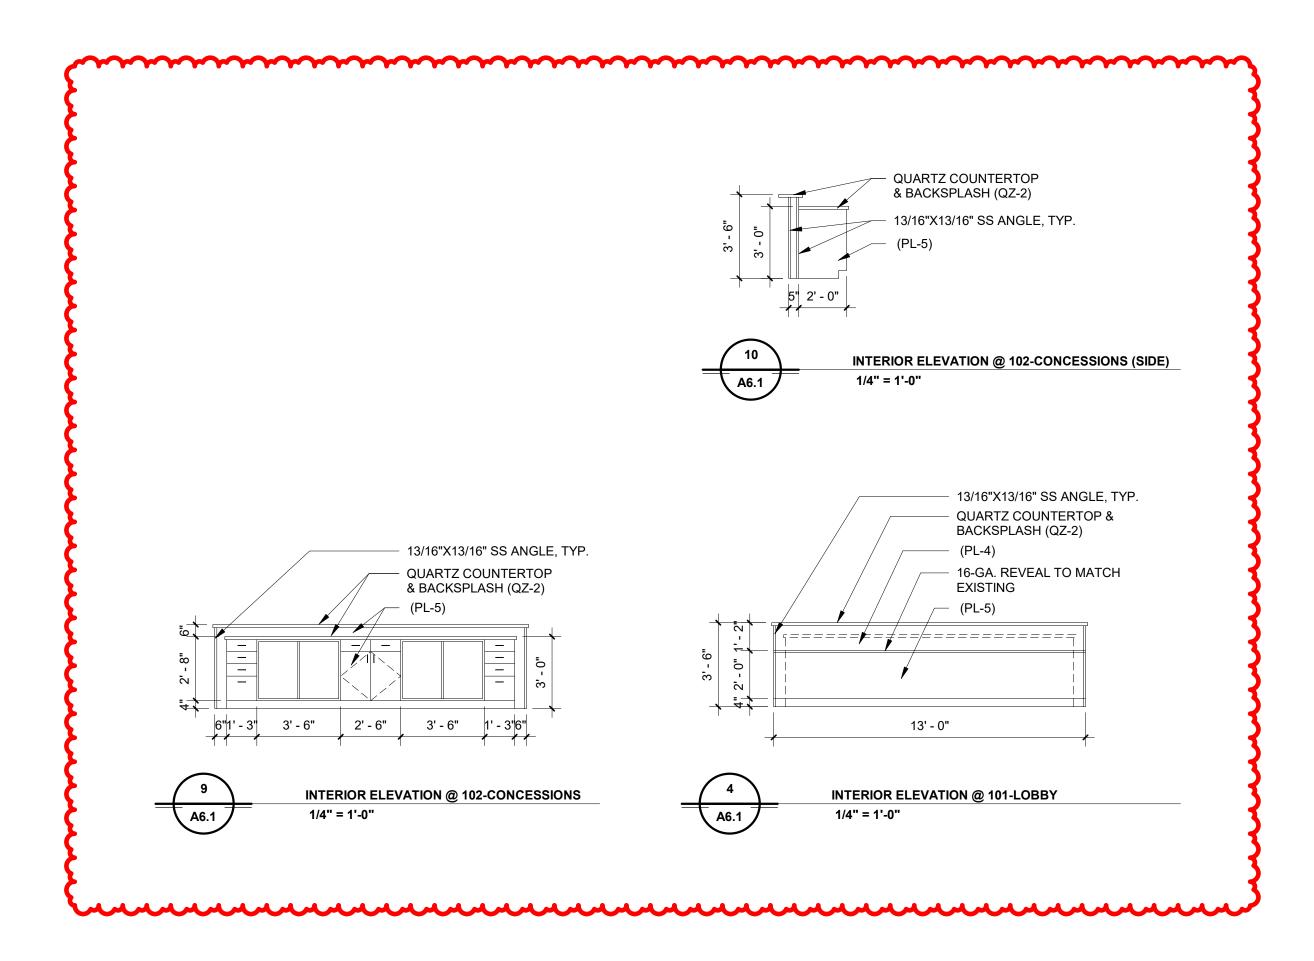

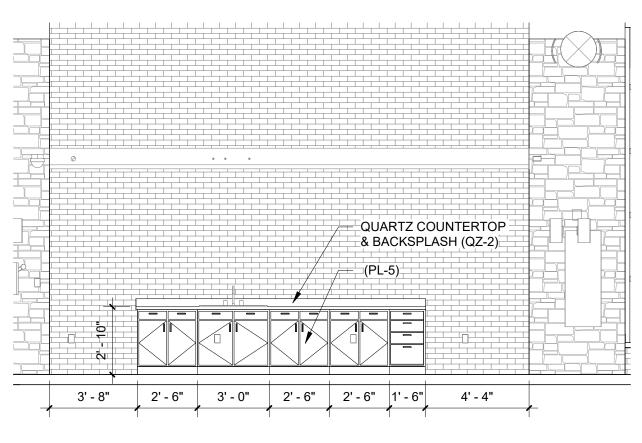

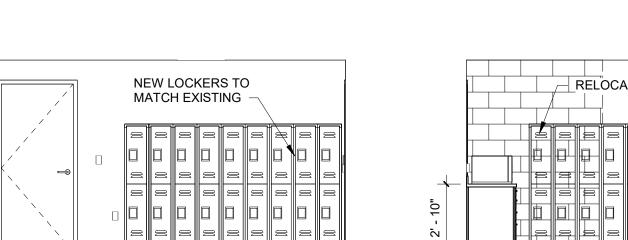


INTERIOR ELEVATION @ 113-BREAK ROOM

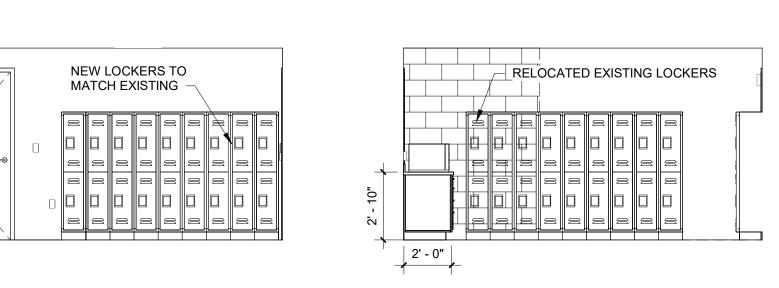


(106B)

(N.I.C.)

2' - 0" 3' - 0"

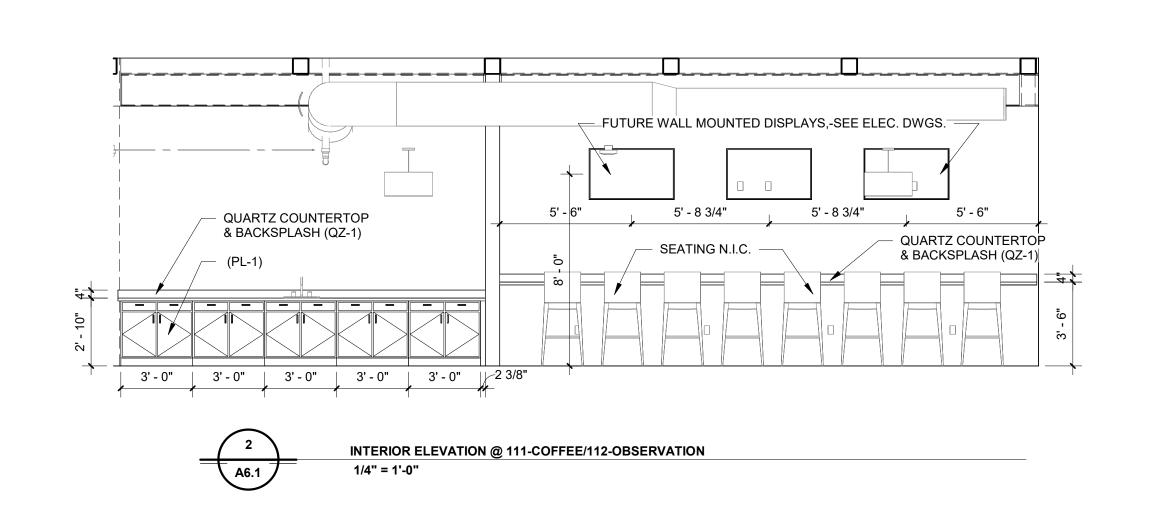

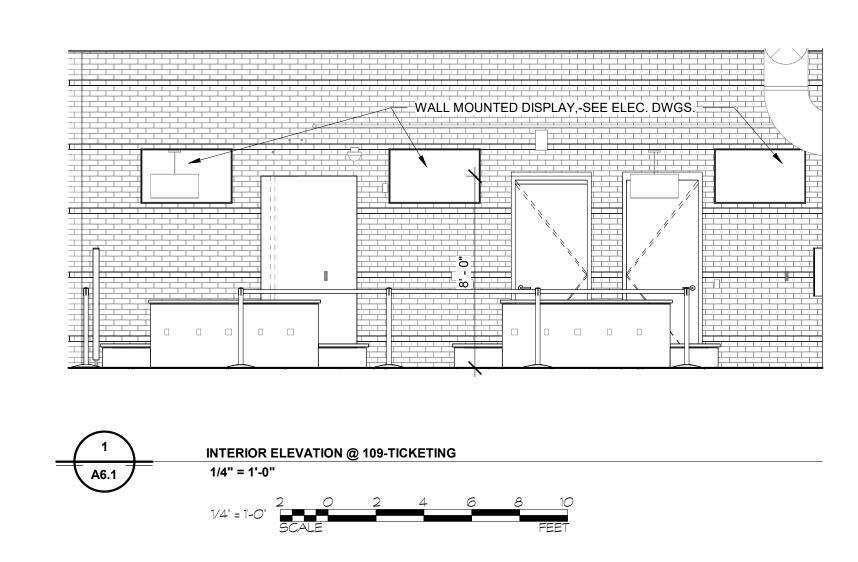







16.00	Professional Certification:
OF MARY DAIN	I hereby certify that these docume were prepared or approved by me and that I am a duly licensed professional engineer under the la of the State of Maryland.
6157 PRCHITECTIVIII	License No. 6157
WOHITE	Expiration Date: 09/07/2026


ents	DESIGNED:	RAK	No. Rev 1	DATE 06.12.2025	DESCRIPTION Revised (Addendum No. 2)
le,	DRAWN:	RAK			
	CHECKED:	NEM			
	APPROVED:	NEM			





TERMINAL BUIL	DING EXPANSION	FAA AIP No.: 3-24-0019-XX-2025 Bid No.: PUR-1751 MAA Grant No.: MAA-GR-XX-XXX
TITLE:		SUBMISSION: BID SET
INTERIOR	ELEVATIONS	SHEET No.: <b>A6.1</b>
1/4" = 1'-0"	DATE: MAY 2025	60 of 102

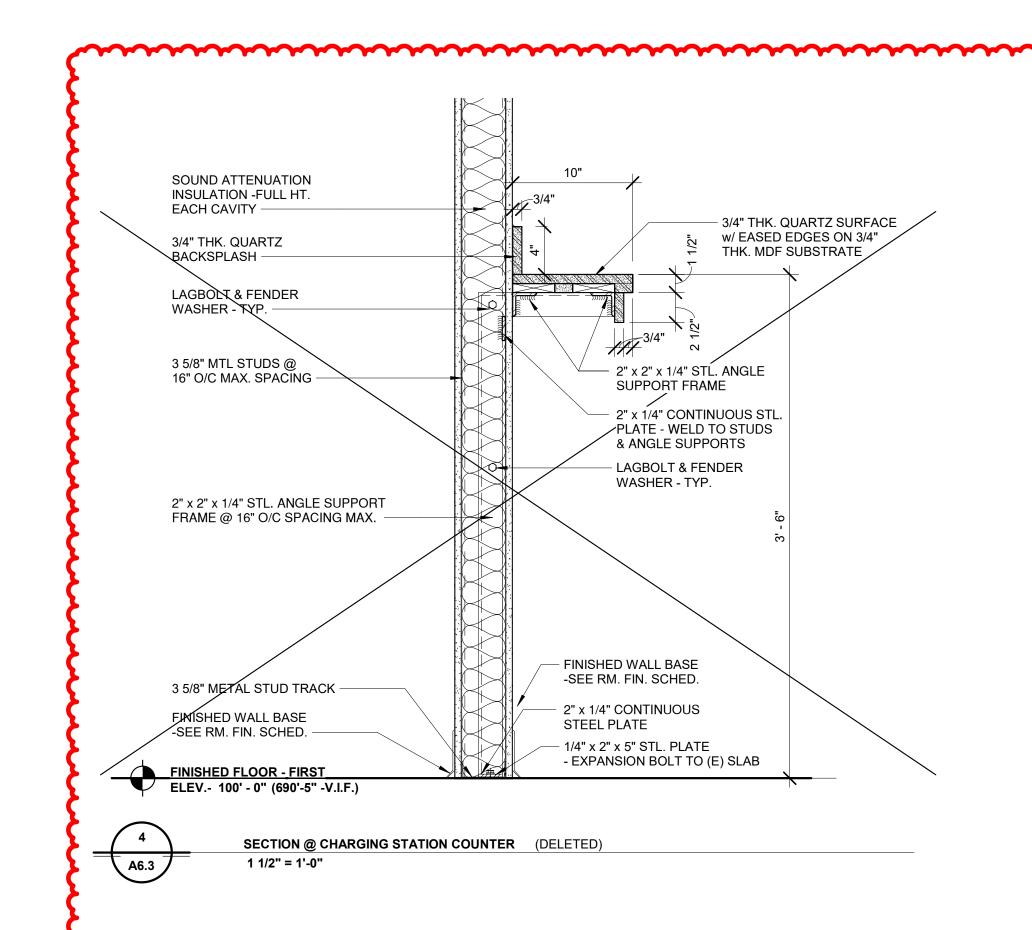


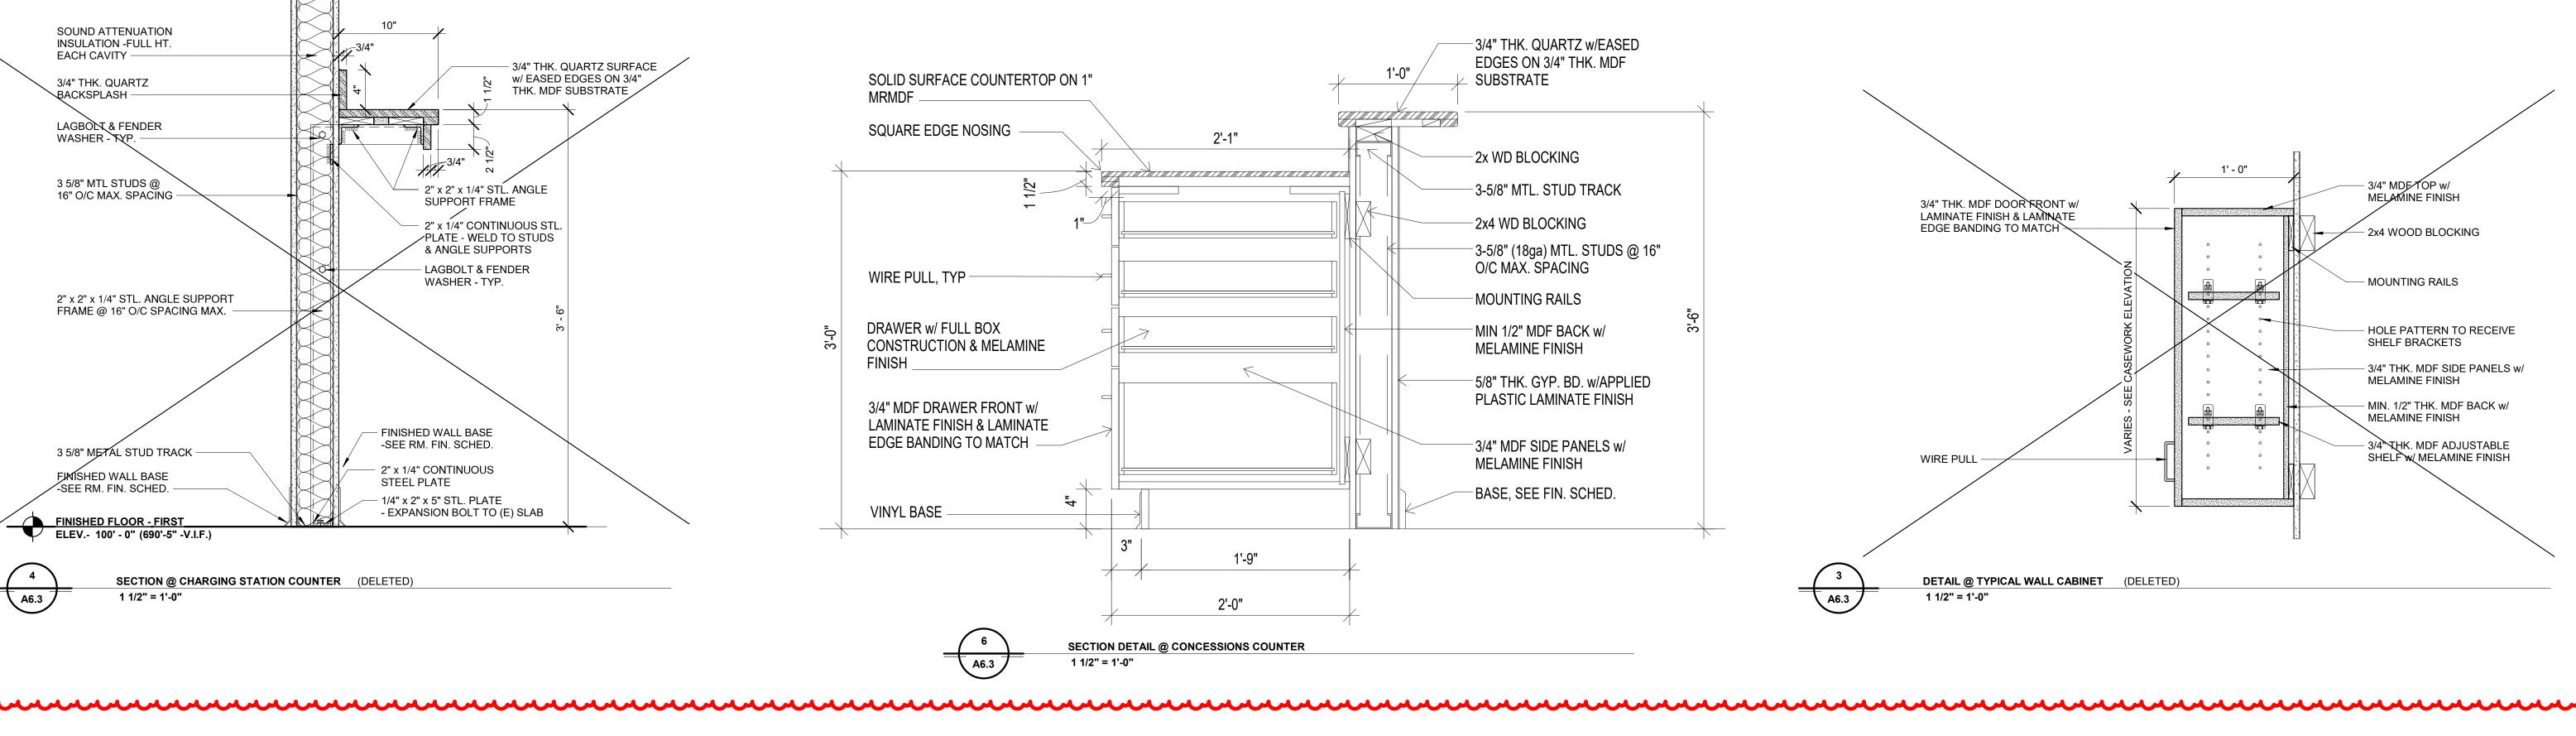


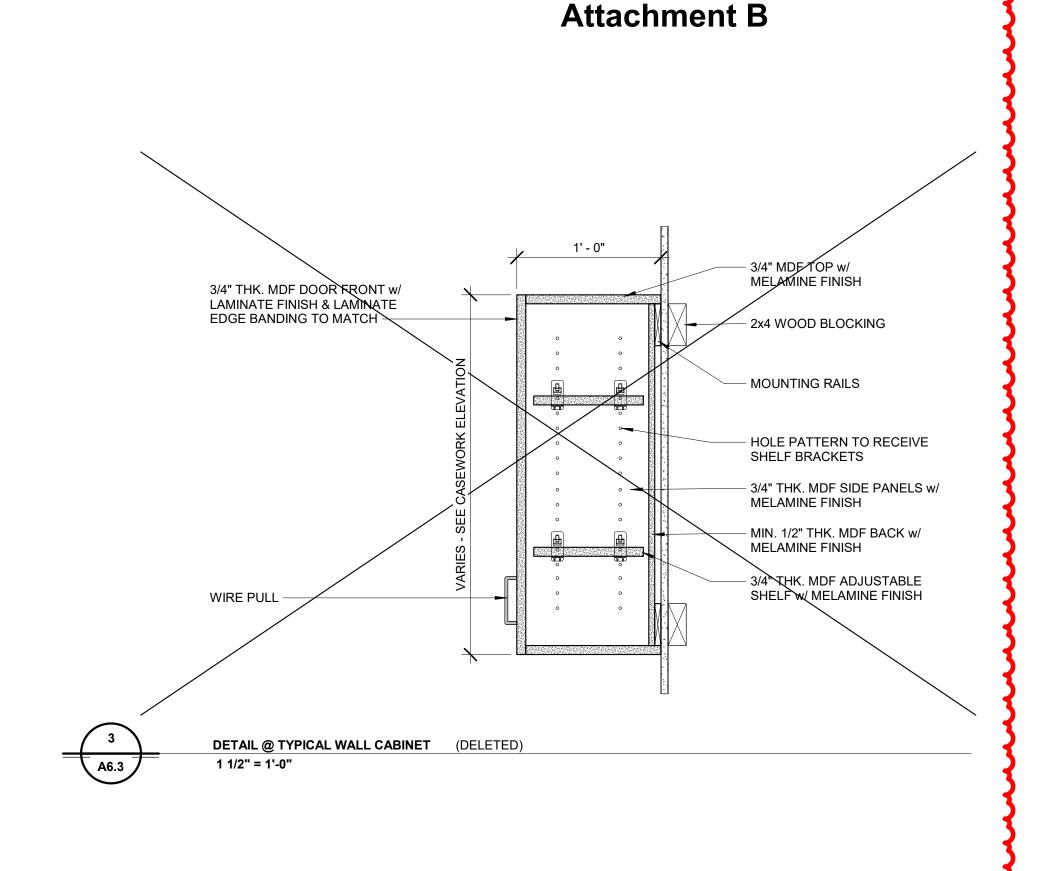

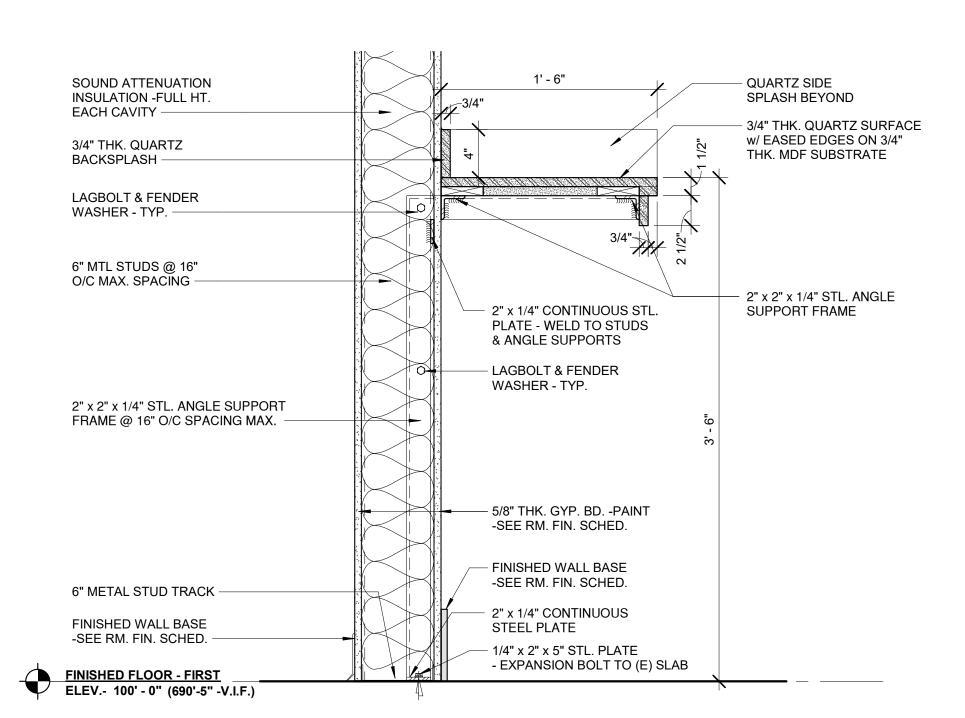

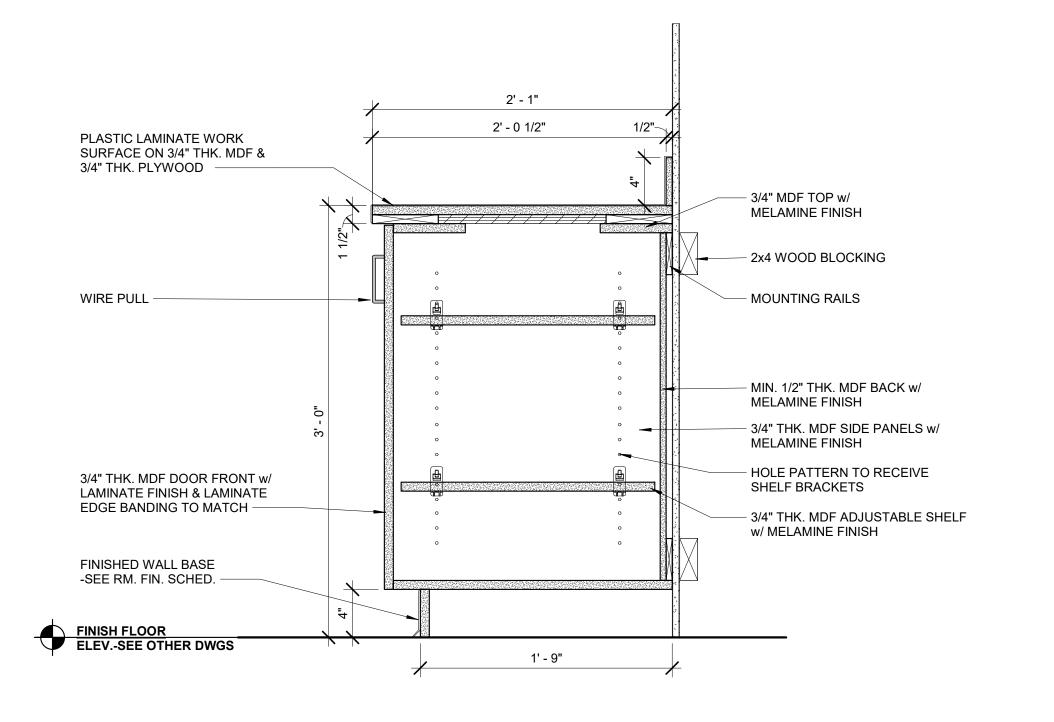


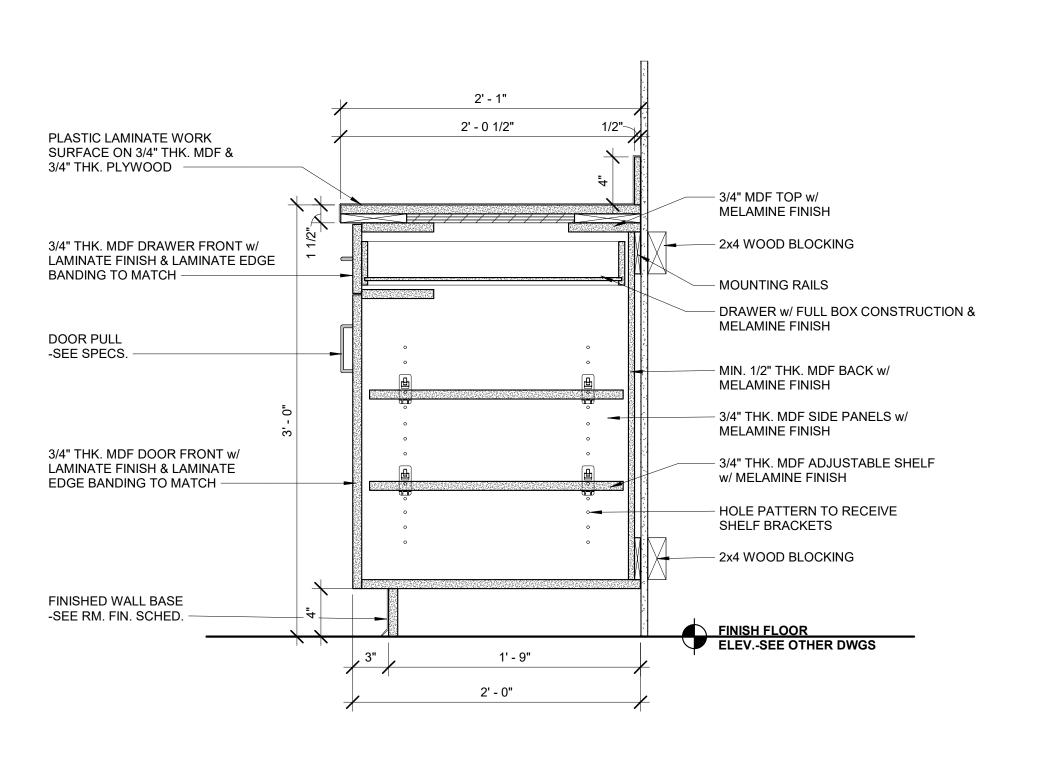

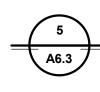

SECTION @ CHARGING STATION COUNTER

1 1/2" = 1'-0"

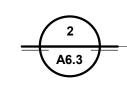

**DETAIL @ TYPICAL BASE CABINET** 1 1/2" = 1'-0"

**DETAIL @ TYPICAL BASE CABINET** 



6011 UNIVERSITY BLVD. SUITE 490 ELLICOTT CITY, MD 21043 PHONE: 410-465-9600



SEAL:	1-11	
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William.	OF MARININAN E. NO. V.	
ZZ	9:3	
S N		1
Juni	RCHITECHINI	
STATISTICAL STATIS	OF MARIAN AN E. O. A. D. S.	

Professional Certification:	DESIGNED:	RAK	No.	DATE	DESCRIPTION
I hereby certify that these documents			Rev 1	06.12.2025	Revised (Addendum No. 2)
were prepared or approved by me,					
and that I am a duly licensed	DRAWN:	RAK			
professional engineer under the laws					
of the State of Maryland.	CHECKED: N	NEM			
	CHECKED.	INEIVI			
License No. 6157					
	APPROVED:	NEM			
Expiration Date: 09/07/2026					



PROJECT TITLE:  TERMINAL BUIL	DING EXPANSION	FAA AIP No.: 3-24-0019-XX-2025 Bid No.: PUR-1751 MAA Grant No.: MAA-GR-XX-XXX
SHEET TITLE:		SUBMISSION: BID SET
CASEWO	RK DETAILS	SHEET No.: <b>A6.3</b>
SCALE: 1 1/2" = 1'-0"	DATE: MAY 2025	62 of 102