

PURCHASING DEPARTMENT DIVISION OF BUDGET & FINANCE

PUR-1751 ADDENDUM NO. 4 INVITATION TO BID

HAGERSTOWN REGIONAL AIRPORT EXPAND/REHABILITATE TERMINAL BUILDING EAST

DATE: Friday, June 20, 2025

BIDS DUE: Friday, June 27, 2025

2:00 P.M.(EDT/EST)

To Bidders:

This Addendum is hereby made a part of the Contract Documents on which all bids will be based and is issued to correct and clarify the original documents.

Please acknowledge receipt of this Addendum at the appropriate space on the Proposal Form. This Addendum consists of seven (7) pages and one (1) attachment.

NOTE: All Bidders must enter the Washington County Administration Complex through either the front door at the 100 West Washington Street entrance or through the rear entrance (w/blue canopy roof) which is handicap accessible and must use the elevator to access the Purchasing Department to submit their bid and/or to attend the Pre-Bid Conference. Alternate routes are controlled by a door access system. The general public will be subject to wand search and will be required to remove any unauthorized items from the building prior to entry. Prohibited items include but are not limited to: Weapons of any type; Firearms, ammunition, and explosive devices; Cutting instruments of any type - including knives, scissors, box cutters, work tools, knitting needles, or anything with a cutting edge, etc.; Pepper spray, mace, or any other chemical defense sprays; and Illegal substances.

ITEM NO. 1: <u>Inquiry</u>: Specification section 01 20 00 - Price and Payment Procedures, paragraph 1.3 reads like this is a unit price contract yet that contradicts other information contained in the bid docs. Please confirm this paragraph is NOT APPLICABLE to this contract, this is a fixed sum contract.

<u>Response</u>: DELETE Article 1.3.A in its entirety and REVISE to read as follows: "A. Unit Prices shall be used for "Extra Work" and "Credit". The Bid Price is a fixed sum contract amount."

ITEM NO. 2: *Inquiry:* Please clarify item 12 Installation of the Supplemental Terms and Conditions.

100 West Washington Street, Room 3200 | Hagerstown, MD 21740-4748 | P: 240.313.2330 | F: 240.313.2331 | Hearing Impaired: 7-1-1

<u>Response</u>: This item has been revised to read: Erosion and sediment control, foundation & building expansion, addition areas and finishes: (new public seating areas, ticketing functions, concessions, baggage space, a lactation room, staff breakroom, and support offices), concrete slab and sidewalk, roofing, HVAC, plumbing, electrical and data, interior renovations, new seating in existing hold rooms, asphalt and concrete pavement demolition, utility installation, fencing, drainage removal and installation, new asphalt paving, pavement marking, backfill, top soiling, seeding, mulching.

ITEM NO. 3: <u>Inquiry</u>: Will the audience seating supplier information be provided

<u>Response</u>: Supplier: MOI. Contact Person: Candice Davis 240.864.0302, Email: cdavis@moii.com.

ITEM NO. 4: *Inquiry:* Will the brick veneer supplier information be provided

<u>Response</u>: Refer to Spec Section 04 20 00, Article 2.5.B.9.d. Local Supplier: Furnished by Steffey & Findlay, Inc., 177 Burhans Blvd., Hagerstown, MD 21740; Contact: Walt Gossard; Phone: 301-733-1600; Email: walt@steffeyfindlay.com

ITEM NO. 5: <u>Inquiry</u>: The temporary security fencing to be installed, is that what is detailed on G2.2 or CV5.2? Drawings are unclear on what is to be provided, it only notes to be approved by airport operations

<u>Response</u>: The fence detailed on G2.2 is the temporary security fence. The fence on CV5.2 is the permanent AOA fence. (Attachment A)

ITEM NO. 6: <u>Inquiry</u>: Sloped glazing assemblies above rooms 117 and 118 are not shown on the window types drawing A2.2. Please provide.

<u>Response</u>: DELETE Drawing A2.4 in its entirety and REPLACE with Revised Drawing A2.4, dated 06.18.25. Sloped glazing system is shown on Drawing A4.5 with details on Drawing A2.4. Provide 3/8" polycarbonate glazing. (Attachment A)

ITEM NO. 7: <u>Inquiry</u>: Glazing legend on A2.2 shows G-3 Spandrel glazing, but it is not shown on the window types. Please clarify if spandrel glazing is required.

<u>Response</u>: DELETE G-3 spandrel glazing on Drawing A2.2. Spandrel glazing is not required.

ITEM NO. 8: Inquiry: The basis of design for the aluminum exterior doors (Megatherm 50XT) is a YKK product, but YKK doesn't appear on the acceptable manufacturers listed in the specifications. Also, according to the YKK product manual, the Megatherm XT product was discontinued on 04/30/2024. Please clarify. https://www.ykkap.com/commercial/productguide/entrances/35xt/

Response: Provide Kawneer 500T wide stile storefront doors. Finish: Clear Anodized.

(NOTE: The wording of all "Inquiries" submitted are displayed exactly as received.)

ITEM NO. 9: <u>Inquiry</u>: Please verify the fixed seating in rooms 110 Lobby and 112 Observation on A1.3 are new and are not existing. The seating is marked with and (E) on the plan

<u>Response</u>: The seating in 110-Lobby and 112-Observation is new seating to match existing Herman Miller Eames Tandem Sling Seating in Black Heavy Vinyl Padded.

ITEM NO. 10: <u>Inquiry</u>: Specification section 083336 3.7C states to refer to section 083100 for the steel mesh grille. 083100 is for access panels and makes no mention of grilles.

Response: Spec Section 083336; DELETE Article 3.7.C in its entirety.

ITEM NO. 11: <u>Inquiry</u>: Overhead door specification section 083336 2.2A10c2 calls for card reader control. Will the card reader be furnished and installed by the owner's security contractor?

Response: A Card Reader is not required for the Overhead rollup doors.

ITEM NO. 12: <u>Inquiry</u>: Overhead door specification section 083336 3.7A,B & C, contains a schedule for overhead doors. These door numbers do not show on the door schedule and are not shown on floor plans or the demo plans. Are these openings required for this project? Please clarify.

Response: Spec Section 083336; DELETE Articles 3.7.A, B, and C in their entirety. REPLACE Articles 3.7.A & B as follows:

A. Door 114 is a new 14'-0" x 10'-0" high door and frame.

B. Door 116 is an existing 12'-0" wide x 9'-0" high relocated to new opening."

ITEM NO. 13: <u>Inquiry</u>: Supplemental Terms and Conditions, Item 20 - Please confirm this project is a Stipulated Sum not Unit Price Contract

<u>Response</u>: Supplemental Terms and Conditions, Item 20 should be listed as a Stipulated Sum, not a Unit Price Contract.

ITEM NO. 14: <u>Inquiry</u>: Are there any specific FAA requirements for the temporary construction fence?

<u>Response</u>: The FAA does not provide any specific requirements for the temporary construction fence. However, per TSA Security requirements, all fences need to be secured to prevent unauthorized entry to the airport.

ITEM NO. 15: <u>Inquiry</u>: Please provide the name of the roofing contractor with whom the existing roof system is currently under warranty.

<u>Response</u>: Kline Associated Roofing Contractors Inc., 350 East First Street, Hagerstown, MD. Sarnafil Sika Corporation Roofing Warranty.

Inquiry: Table of Contents list a document that cannot be located: Form of Proposal, **ITEM NO. 16:** FP-1 - FP-4. Please provide.

> Response: "HARDCOPY" - The form of proposal pages FP-1 to FP-4 is included with the solicitation provided on the Washington County website.

> "ELECTRONIC" - The proposal form is located in the "Line Items" tab on the county's online bidding site, Ionwave.

ITEM NO. 17: *Inquiry*: Please confirm this project is tax exempt

Response: No, this project is not tax exempt.

Inquiry: Will fire protection be included in this project or will that be separate contract? **ITEM NO. 18:**

> Response: The building addition will require a supervised automatic sprinkler system and an addressable fire alarm system.

ITEM NO. 19: *Inquiry:* Is there an expected/rough start date/NTP?

> Response: The expected start date/NTP is dependent on the receipt of FAA and MAA funding for the project, which may delay the start of construction. It is anticipated that the FAA/MAA funding offers will be received in August/September of 2025. An administrative NTP is anticipated for the Fall of 2025 for submittals and procurement and a construction NTP is anticipated in the Spring of 2026.

ITEM NO. 20: *Inquiry*: Please confirm who is responsible for the installation of the Owner furnished bollards

> Response: The General Contractor will be responsible to install the owner supplied bollards. The owner will supply the rebar cage, bollard pipe and cover. The Contractor will be responsible for excavation, placement, concrete, and backfill.

ITEM NO. 21: Inquiry: Ref.: Electrical drawing and ADD Alt 1: The drawings depict power and lighting circuits that come from the Add alt 1 section to the Base bid section. Please provide details on how to handle this if the ADD Alt 1 is not completed.

> Response: Under Base Bid, all new panels and electrical room are to be installed. If renovations under ADD Alt 1 are chosen, all new circuits under this renovation to be connected to panels installed under Base Bid.

ITEM NO. 22: *Inquiry:* Ref.: Electrical room orientation: During site visit the Designer mentioned that the 2 new transformers will be stacked rather than floor mounted. Please confirm and provide an updated drawing.

Response: Refer to Addendum 4 Drawing Revisions for updated transformer layout.

(NOTE: The wording of all "Inquiries" submitted are displayed exactly as received.)

Page 5

(Attachment A)

ITEM NO. 23: <u>Inquiry</u>: Ref.: New Electrical Panel tie into existing service: Will the outage need to be during off hours? If so, will escorts be required for off hours work

<u>Response</u>: This outage will need to be on a day when there are no scheduled service flights and/or during off work hours. Escorts will be provided by the Airport.

ITEM NO. 24: <u>Inquiry</u>: Ref.: New Electrical room construction Phasing: Will the existing roll up door be moved and the new electrical room be constructed before the new electrical panels need to be installed? If not, the panels will be exposed to the elements and need to be protected.

<u>Response</u>: Refer to Revised Drawing A1.3 per Addendum No. 3. Drawing was revised to provide adequate clearance within the Electric Room without removing the roll-up door. The room will be constructed under Base Bid.

ITEM NO. 25: <u>Inquiry</u>: Ref.: Security Rough in: Where is the location where the security closets, where security the conduit should be routed?

<u>Response</u>: The security panels are located in the L shape room on frame line 7 next to the hold room entrance and men's public toilet room.

ITEM NO. 26: <u>Inquiry</u>: Ref.: Telecom Rough in: Where is the telecom room where telecom conduit should be routed?

<u>Response</u>: Refer to Addendum 4 Drawing Revisions for clarification on telecom room locations. (Attachment A)

ITEM NO. 27: <u>Inquiry</u>: Ref.: Airport Security: Will escorts be needed for any part of the work in the airport? If so, will the customer be providing them, or will the GC be required to provide them?

Response: The airport staff shall provide airport security and escorting.

ITEM NO. 28: <u>Inquiry</u>: Ref.: security system scope: Is the security cabling, devices, and head end equipment scope part of a separate contract. The specifications only refer to rough in.

Response: Yes, this scope is for system rough in only.

ITEM NO. 29: <u>Inquiry</u>: Table of Contents list a document that cannot be located: Form of Proposal, FP-1 - FP-4. Please provide.

<u>Response</u>: "HARDCOPY" - The form of proposal pages FP-1 to FP-4 is included with the solicitation provided on the Washington County website.

"ELECTRONIC" – The proposal form is located in the "Line Items" tab on the county's online bidding site, Ionwave.

ITEM NO. 30: <u>Inquiry</u>: Supplemental Terms and Conditions, Item 20 - Please confirm this project is a Stipulated Sum not Unit Price Contract

Response: Refer to response to ITEM NO. 13 in this Addendum

ITEM NO. 31: <u>Inquiry</u>: Roller shade schedule in the specifications 122000 3.6 states that rooms 128 and 129 are to receive roller shades. These rooms are not identified on the floor plan A1.1 or shown on the enlarged plan A1.3? Please clarify and supply a mounting detail if they are required.

<u>Response</u>: DELETE Section 122000 in its entirety. Roller shades have been deleted from the project.

ITEM NO. 32: *Inquiry*: Will a drawing detail be provided on the duct bank?

<u>Response</u>: An underground conduit trench detail has been added to Sheet No. CV5.2 Site Details 2. REPLACE Sheet No. CV5.2 Site Details 2 with one attached to this Addendum. (Attachment A)

REVISIONS TO PLANS (see corresponding reissued sheets in Attachment A):

ITEM NO. 33: <u>Inquiry</u>: Sheet No. D1.1 ENLARGED FLOOR PLAN AT DEMOLITION: **REVISE** Replace sheet in entirety with attached revised sheet.

ITEM NO. 34: <u>Inquiry</u>: Sheet No. D3.1 DEMOLITION BUILDING ELEVATION & SECTION: **REVISE** Replace sheet in entirety with attached revised sheet.

ITEM NO. 35: <u>Inquiry</u>: Sheet No. A2.4 CURTAIN WALL DETAILS: **REVISE** Replace sheet in entirety with attached revised sheet.

ITEM NO. 36: <u>Inquiry</u>: Sheet No. E1-1 DEMOLITION FIRST FLOOR PLAN: **REVISE** Replace sheet in entirety with attached revised sheet.

ITEM NO. 37: <u>Inquiry</u>: Sheet No. E2-1 FIRST FLOOR PLAN - LIGHTING: **REVISE** Replace sheet in entirety with attached revised sheet.

ITEM NO. 38: <u>Inquiry</u>: Sheet No. E3-1 FIRST FLOOR PLAN - POWER & DATA: **REVISE** Replace sheet in entirety with attached revised sheet.

ITEM NO. 39: <u>Inquiry</u>: Sheet No. E6-1 RISER DIAGRAMS: **REVISE** Replace sheet in entirety with attached revised sheet.

ITEM NO. 40: *Inquiry:* Sheet No. CV5.2 SITE DETAILS 2.

(NOTE: The wording of all "Inquiries" submitted are displayed exactly as received.)


Addendum No. 4 HGR Expand/Rehabilitate Terminal Building East Page 7

REVISE Replace sheet in entirety with attached revised sheet.

By Authority of:

Brand of Kentheer

Brandi J. Kentner, CPPO Director of Purchasing

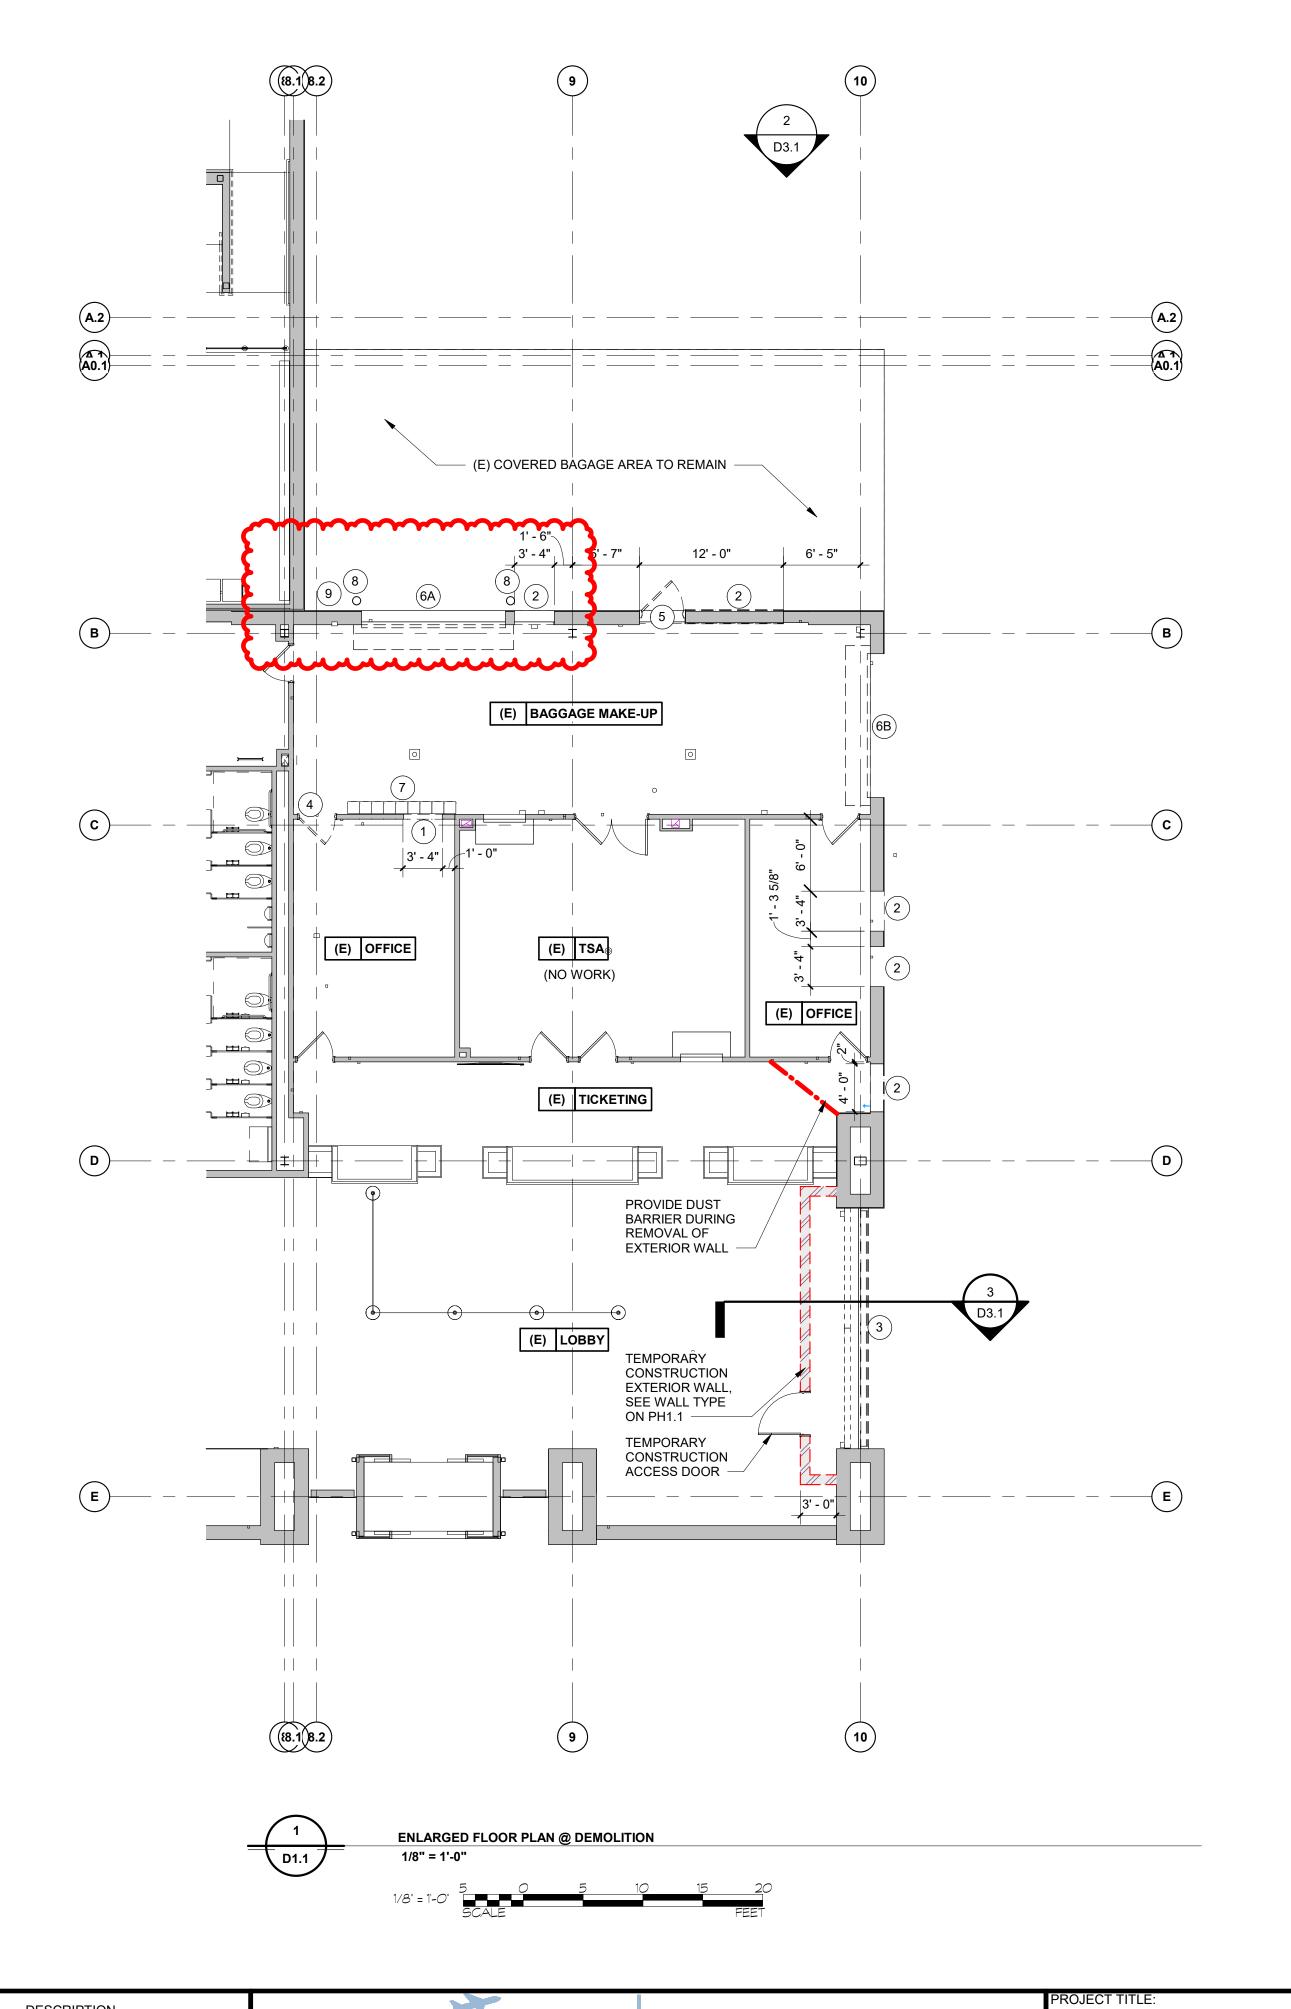

ATTACHMENT A

DEMOLITION LEGEND

- METAL STUD AND GYPSUM BOARD WALLS TO BE REMOVED. (ADD ALTERNATE No. 1)
- PORTION OF EXISTING MASONRY TO BE REMOVED FOR NEW OPENING. PATCH & REPAIR ADJACENT FINISHES AS REQ'D. (BASE BID)
- 3 EXISTING ALUMINUM STOREFRONT TO BE REMOVED. (BASE BID)
- FLUSH WOOD DOORS AND HOLLOW METAL FRAMES TO BE REMOVED. (ADD ALTERNATE No. 1)
- 5 EXISTING HOLLOW METAL DOOR & FRAME TO BE REMOVED. (BASE BID)
- EXISTING OVERHEAD DOOR & ASSOCIATED HARDWARE & TRIM TO BE REMOVED & SAVED FOR REUSE. PATCH & REPAIR ADJACENT MATERIALS AS REQUIRED. (BASE BID)
- EXISTING OVERHEAD DOOR & ASSOCIATED HARDWARE & TRIM TO BE REMOVED. PATCH & REPAIR ADJACENT MATERIALS AS REQUIRED. (BASE BID)
- 7 REMOVE AND RELOCATE EXISTING LOCKERS. SEE 1/A1.3. (ADD ALTERNATE No. 1)
- REMOVE EXISTING BOLLARD FOR CONSTRUCTION OF NEW ELECTRIC ROOM WALL.
- REMOVE EXISTING OVERHEAD DOOR CONTROLS FOR CONSTRUCTION OF NEW ELECTRIC ROOM WALL.





ofessional Certification: nereby certify that these documents ere prepared or approved by me, and that I am a duly licensed professional engineer under the laws of the State of Maryland. License No. 6157

DESCRIPTION DESIGNED: RAK 06.17.2025 Revised (Addendum No. 3) Rev 2 06.18.2025 Revised (Addendum No. 4) DRAWN: RAK CHECKED: NEM APPROVED: NEM Expiration Date: 09/07/2026




	TERMINAL BUILDING EXPANSION
GERSTOWN	SHEET TITLE:
GIONAL AIRPORT	


As indicated


SHEET No.: **ENLARGED FLOOR PLAN AT DEMOLITION** MAY 2025


FAA AIP No.: 3-24-0019-XX-2025 Bid No.: PUR-1751 MAA Grant No.: MAA-GR-XX-XXX SUBMISSION: **BID SET** D1.1

31 OF 102

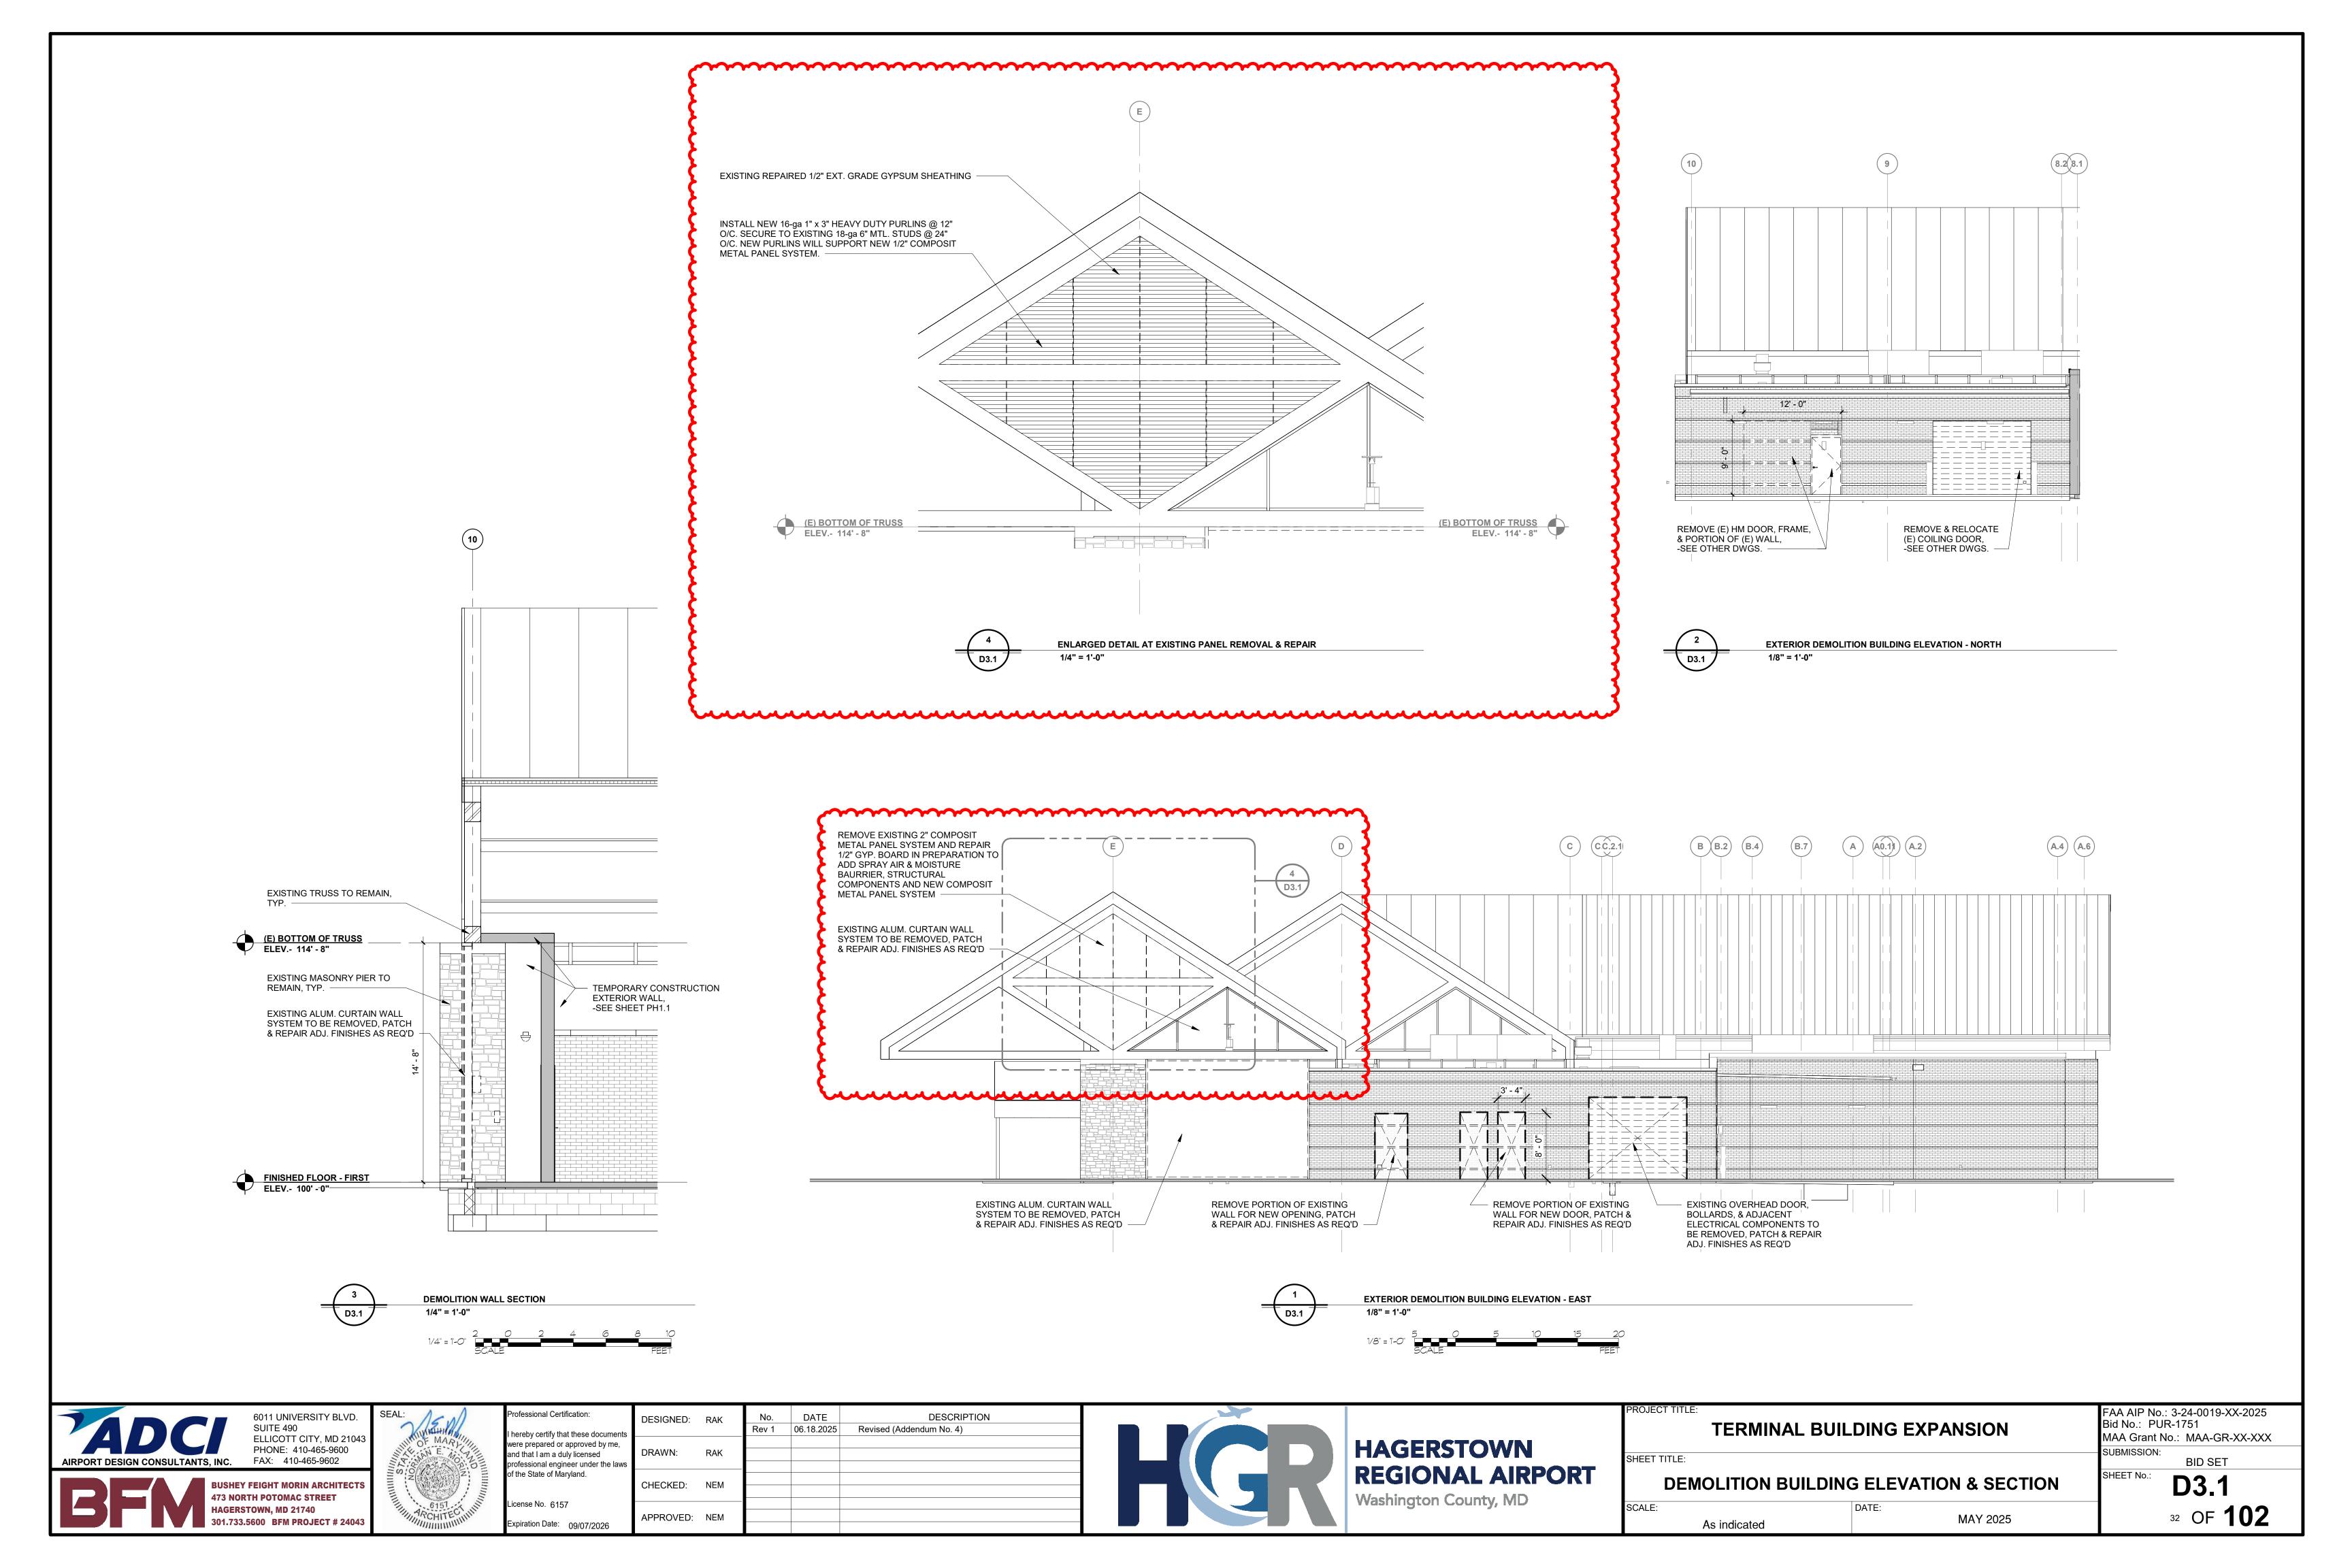

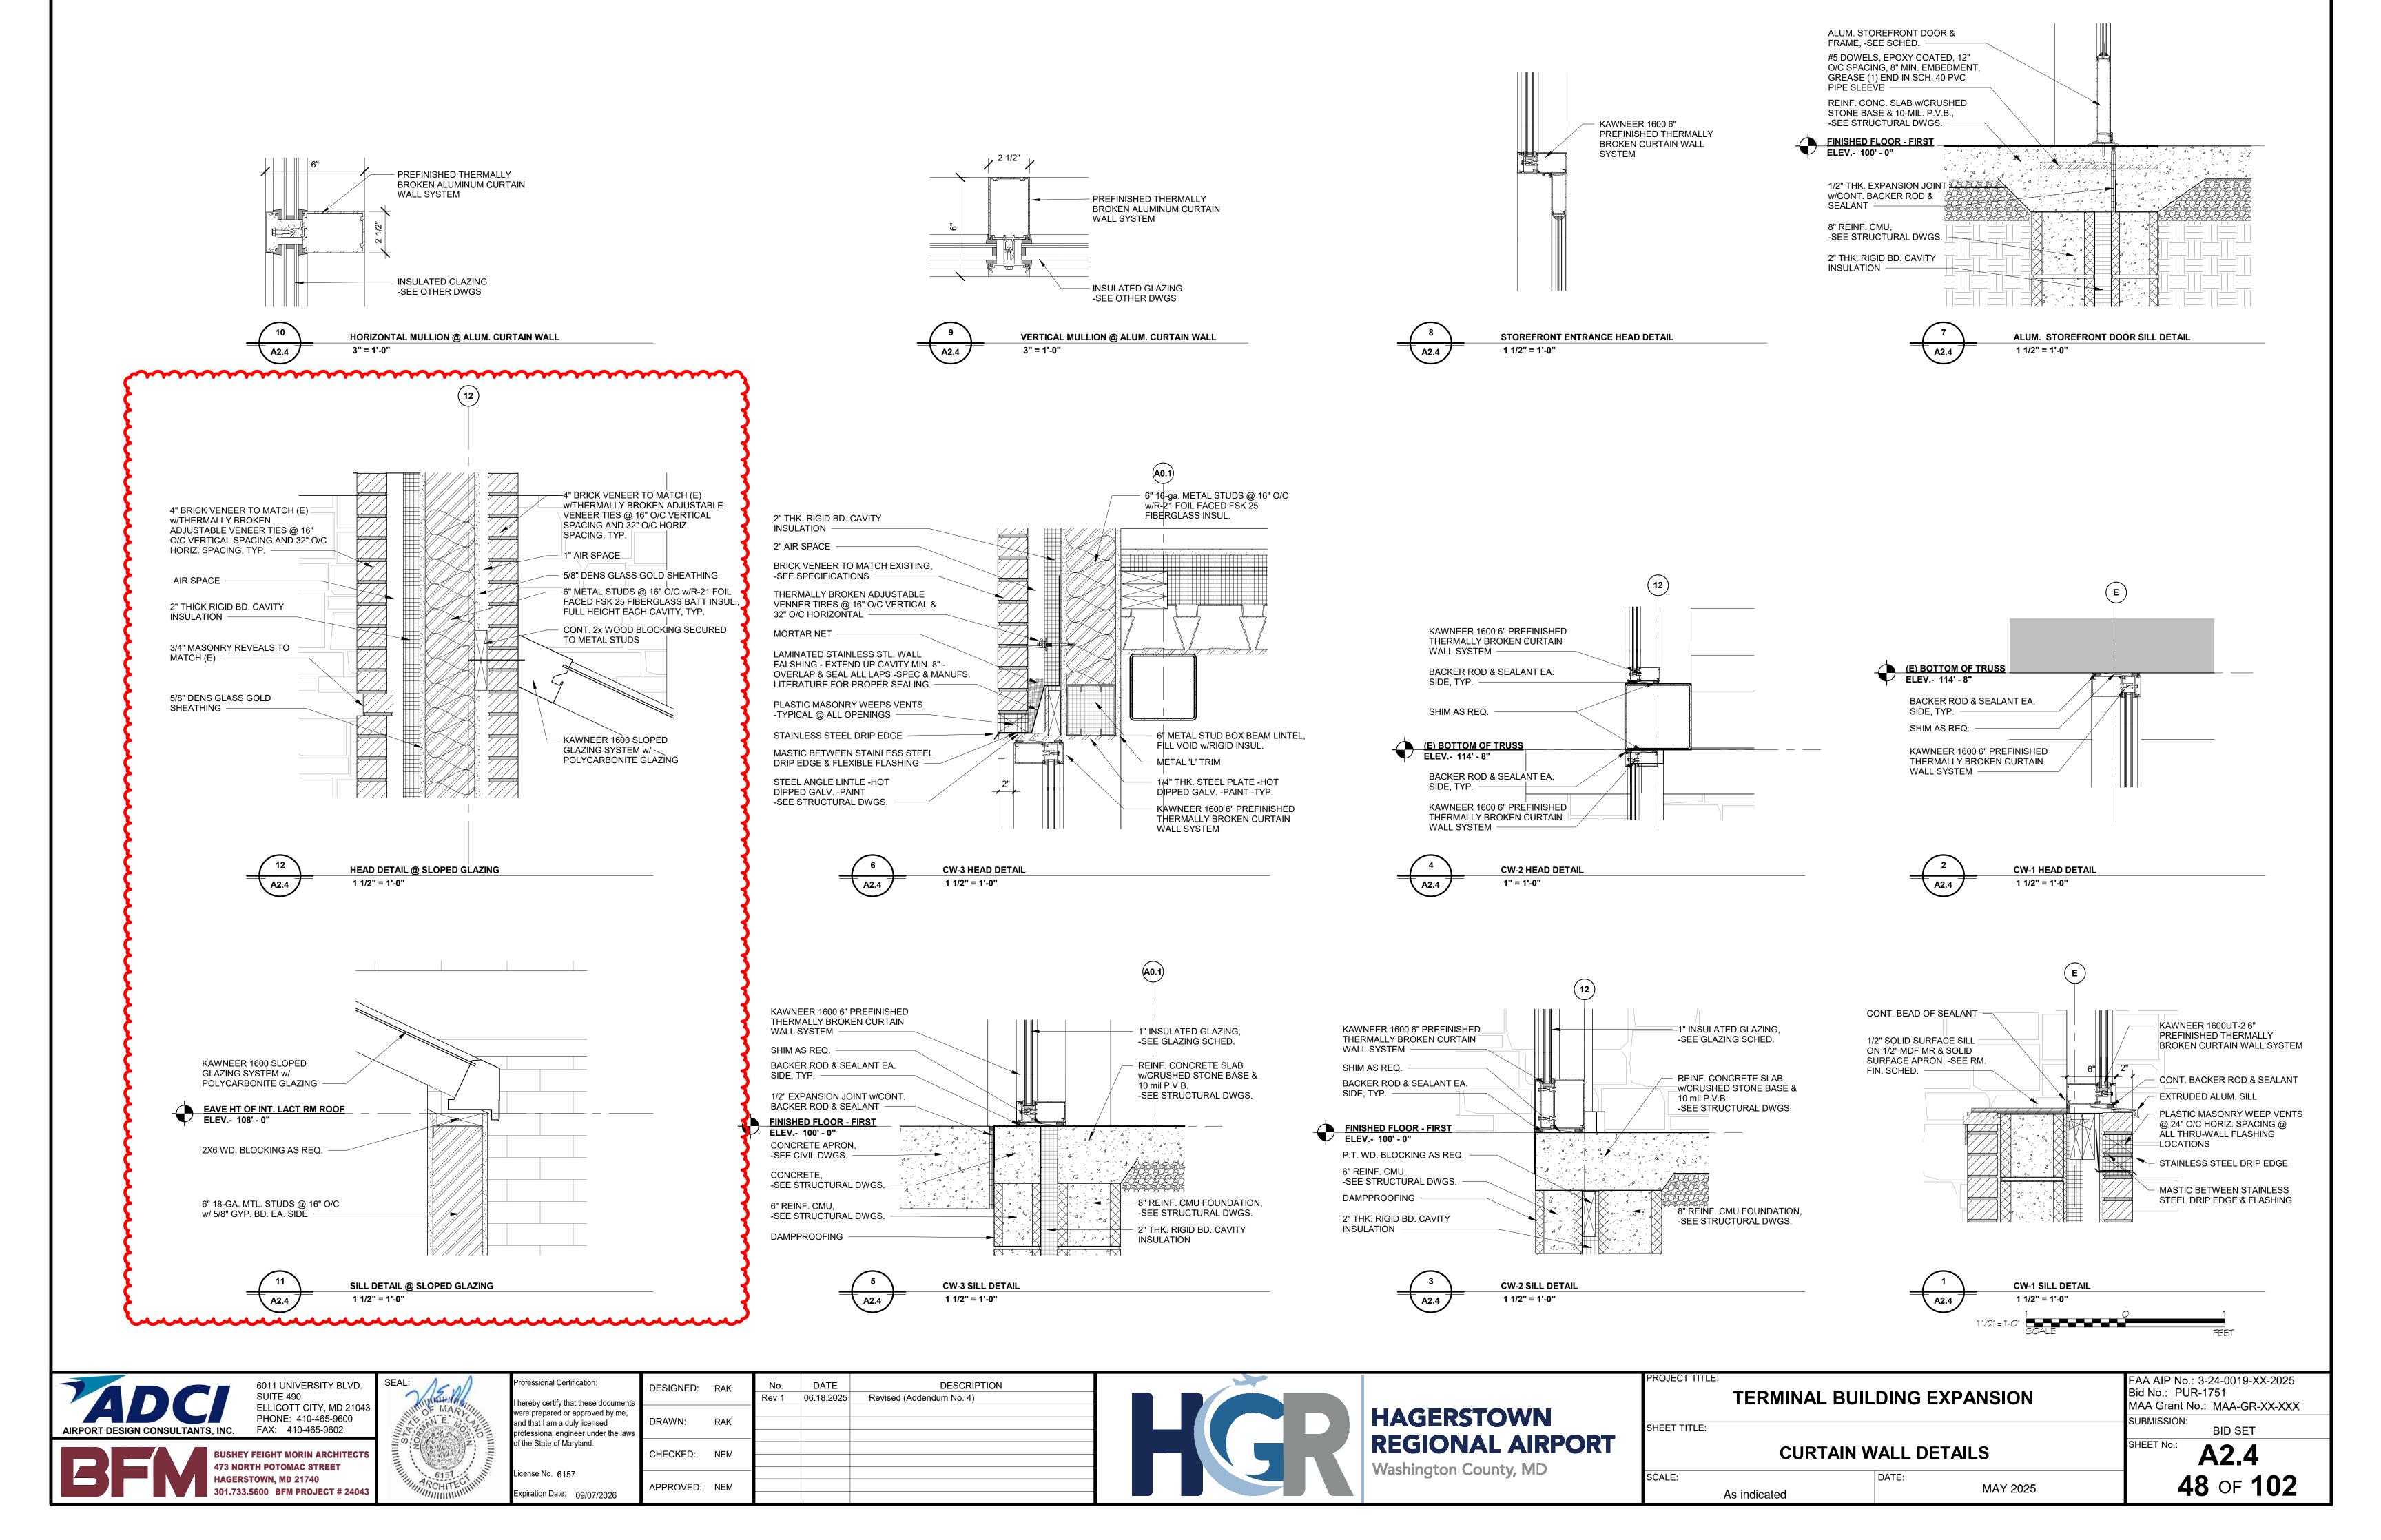

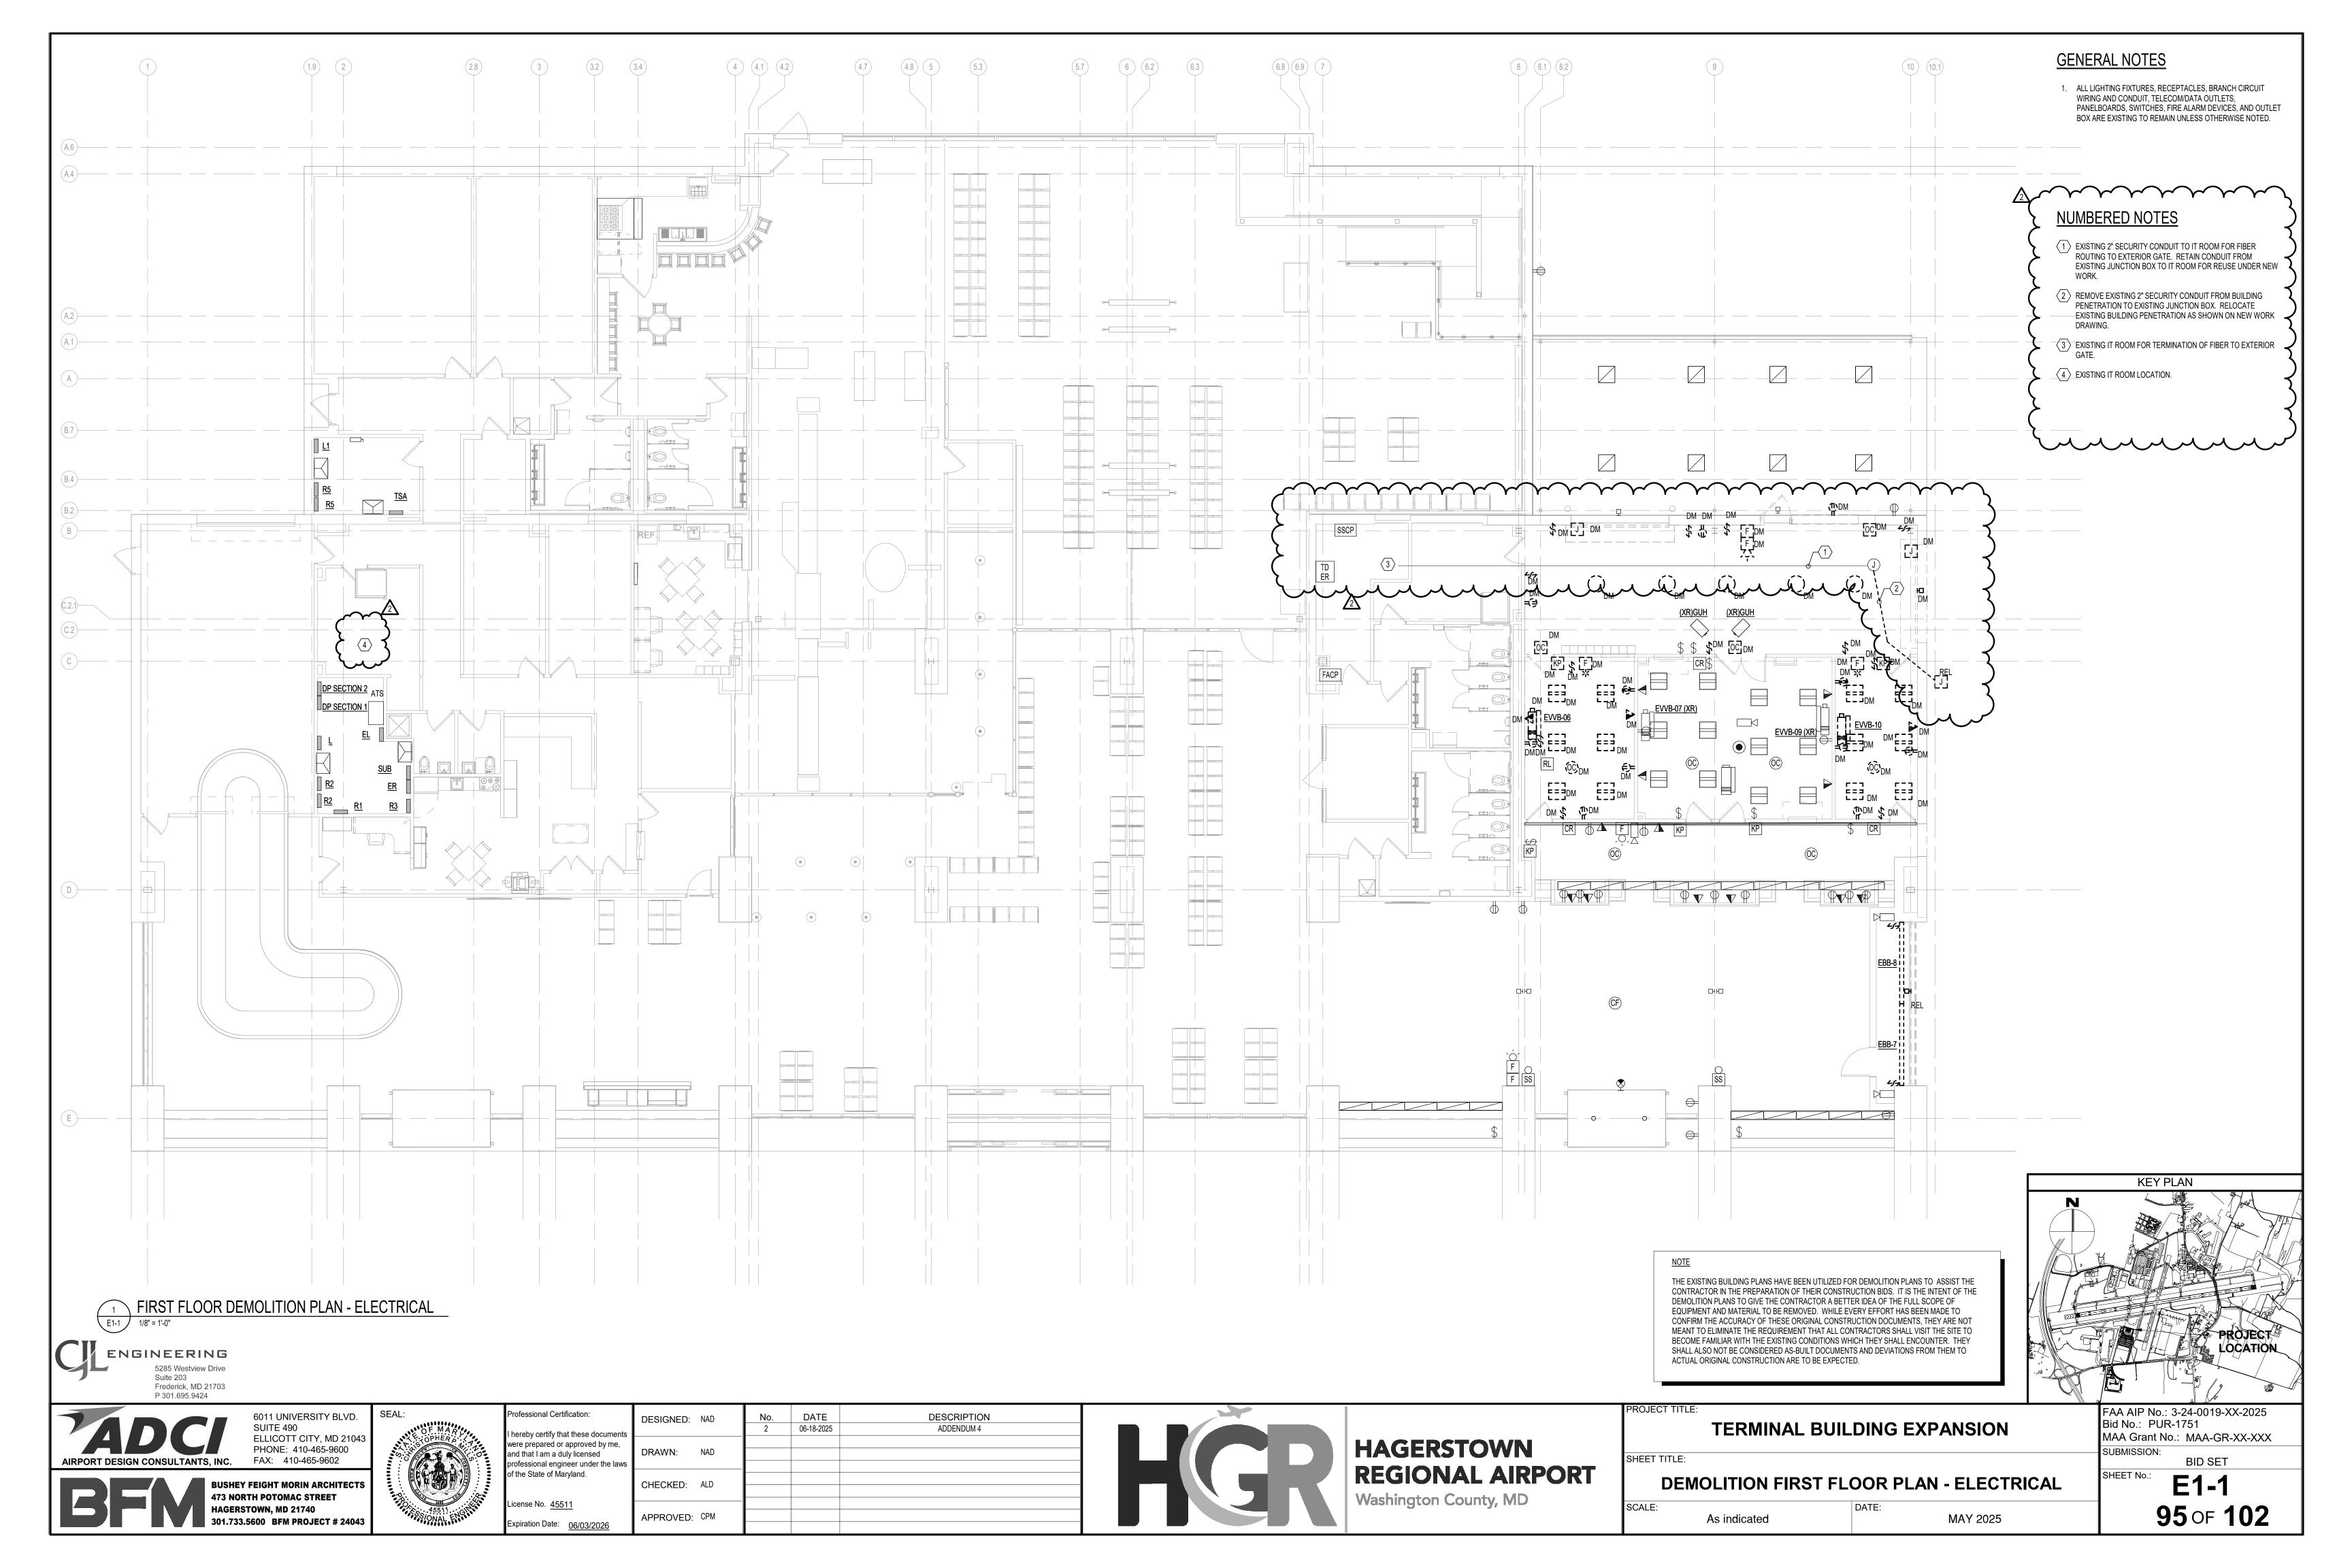

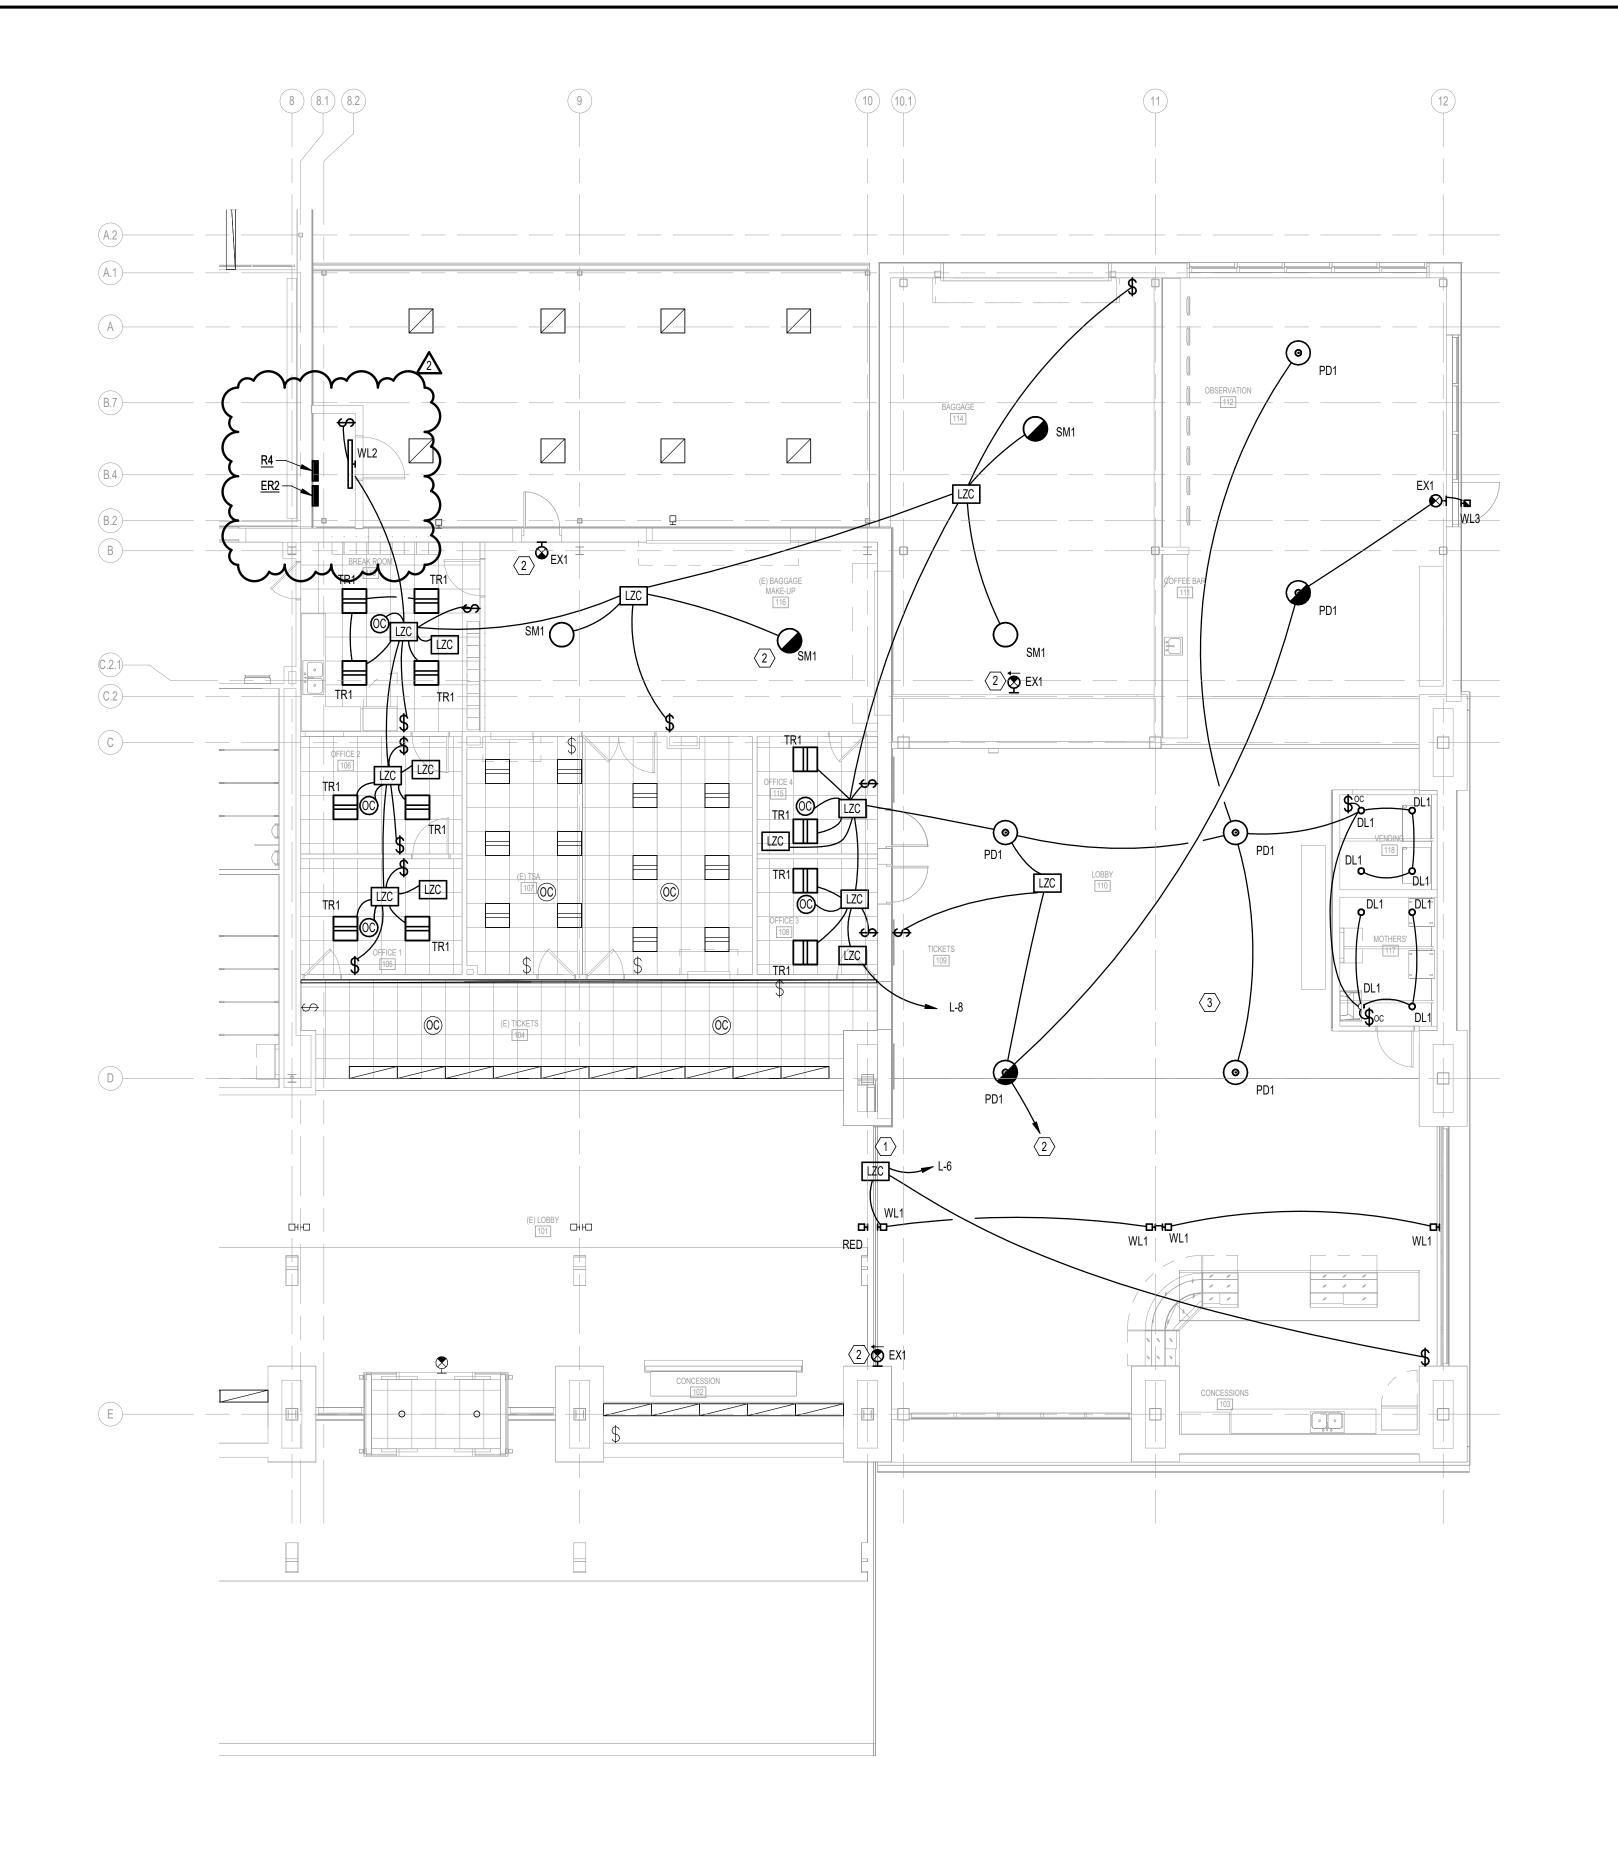




- 1. COORDINATE EXACT MOUNTING HEIGHT ABOVE FINISHED FLOOR AND LENGTH OF SUSPENSION CABLE REQUIRED WITH ARCHITECT. COORDINATE FINAL LOCATION WITH ARCHITECT PRIOR TO ROUGH IN. PROVIDE AND MOUNT TO A SWIVEL
- COORDINATE EXACT HEIGHT, LOCATION AND FINISH OF ALL FIXTURES WITH ARCHITECT PRIOR TO ROUGH IN.
- 3. LOBBY LIGHTING TO BE CONTROLLED BY EXISTING LMZC-301 ZONE CONTROLLER.
- 4. ALL EXIT SIGNS MUST BE CONNECTED TO NORMAL/EMERGENCY POWER CIRCUIT AHEAD OF SWITCHING AND LIGHTING CONTROL PANELS.

NUMBERED NOTES

- $\langle 1 \rangle$ CONNECT TO EXISTING TIME CLOCK.
- (2) CONNECT TO EXISTING EMERGENCY LIGHTING CIRCUIT IN PANEL ER.
- ALL WIRING WITHIN THIS AREA WHERE METAL CEILING DECKING IS USED SHALL BE MC CABLE CONCEALED WITHIN DECKING SYSTEM TO THE LIGHT FIXTURE. COORDINATE WHERE ACCESS PANELS WILL BE REQUIRED AT FIXTURE LOCATIONS WITH THE GC. RUN CONDUIT ALONG THE PURLIN TO FEED THE ACCESS

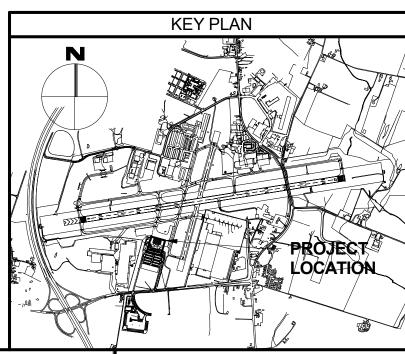





6011 UNIVERSITY BLVD.

BUSHEY FEIGHT MORIN ARCHITECTS

473 NORTH POTOMAC STREET



rofessional Certification: hereby certify that these documents were prepared or approved by me, and that I am a duly licensed professional engineer under the laws of the State of Maryland. License No. <u>45511</u>

Expiration Date: <u>06/03/2026</u>

nts	DESIGNED:	NAD	No. 2	DATE 06-18-2025	DESCRIPTION ADDENDUM 4
ws	DRAWN:	NAD			
	CHECKED:	ALD			
	APPROVED:	СРМ			

\ ENLARGED FIRST FLOOR PLAN - LIGHTING

E2-1 1/8" = 1'-0"



HAGERSTOWN REGIONAL AIRPORT Washington County, MD

SHEET TITLE:	
	FIRST FLOOR PLAN - LIGHTING
SCALE:	DATE:


As indicated

TERMINAL BUILDING EXPANSION

MAY 2025

FAA AIP No.: 3-24-0019-XX-2025 Bid No.: PUR-1751 MAA Grant No.: MAA-GR-XX-XXX **BID SET** SHEET No.:

E2-1 96 OF 102

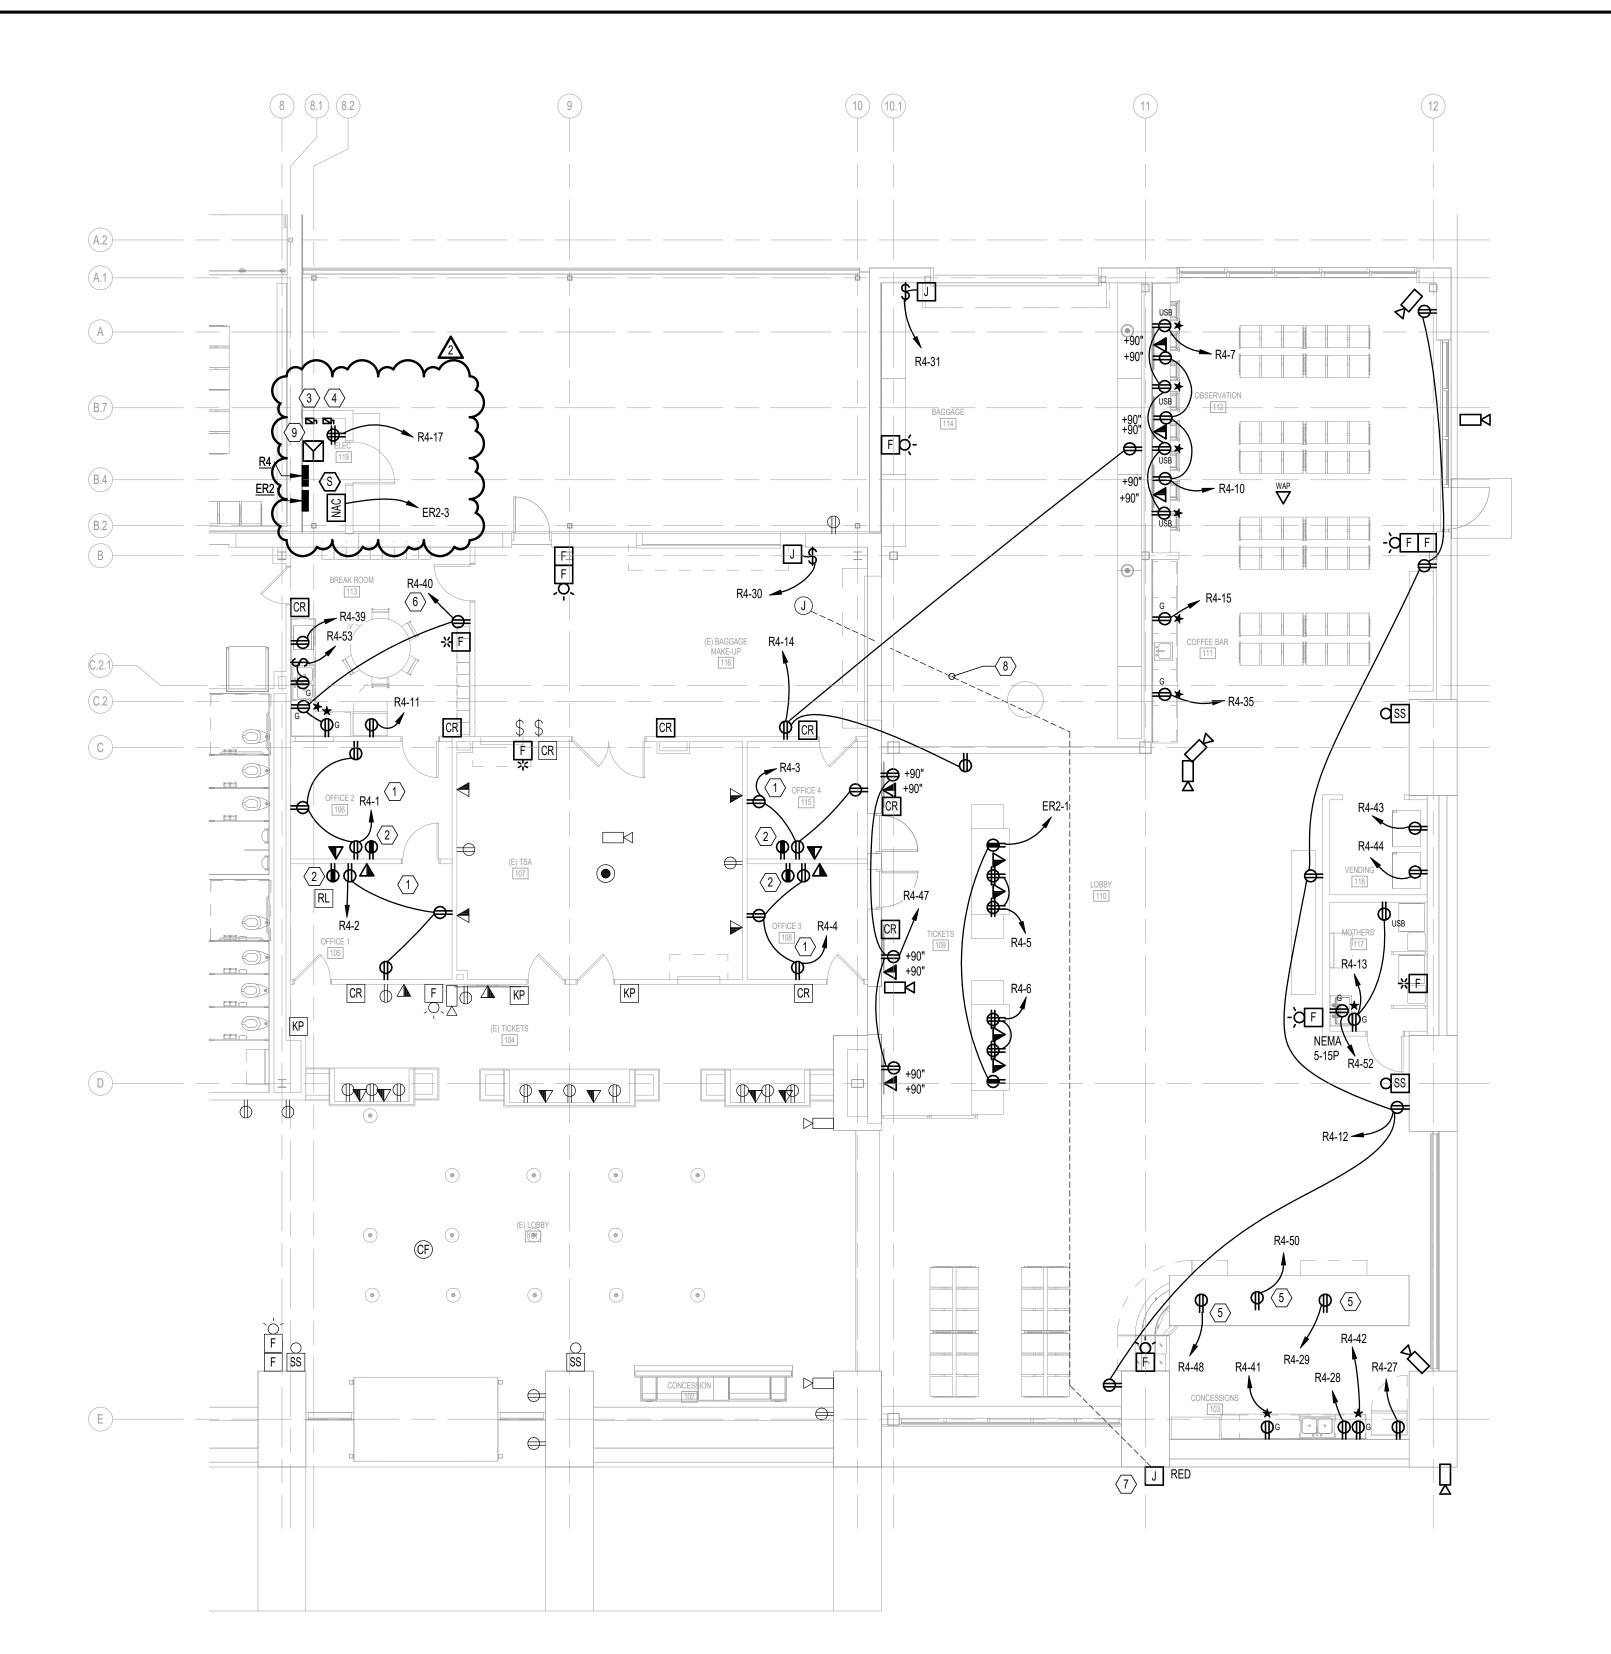


GENERAL NOTES

- 1. ALL RECEPTACLES SHALL BE TAMPER RESISTANT UNLESS OTHERWISE NOTED.
- 2. SECURITY CAMERAS BY OTHERS. COORDINATE WITH ARCHITECT PRIOR TO ROUGH IN. COORDINATE EXACT MODEL NUMBERS WITH HGR SECURITY TEAM.
- 3. ALL VISUAL, AUDIO, AND AUDIO/VISUAL DEVICES MUST BE SYNCHRONIZED.

NUMBERED NOTES

- The receptacles in Room shall be split controlled by occupancy sensor in space. Receptacle shall be labeled as such.
- (2) EMERGENCY RECEPTACLE SHALL NOT BE SPLIT CONTROLLED AND WILL BE ON PANEL ER2-2.
- 3 30A, 208V, 3P, NEMA 1, FUSED DISCONNECT, FUSED AT 30A.
- $\boxed{4}$ 100A, 208V, 3P, NEMA 1, FUSED DISCONNECT, FUSED AT 70A.
- 5 RUN CONDUIT ALONG CASEWORK TO NEAREST FULL HEIGHT
- 6 RECEPTACLES ON GENERAL PURPOSE CIRCUIT WITHIN ROOM SHALL BE SPLIT CONTROLLED BY OCCUPANCY SENSOR IN
- RELOCATE JUNCTION BOX FOR EXISTING FIBER LINE TO ACCESS GATE. RELOCATE UNDERGROUND 2" SCHEDULE 80
 PVC CONDUIT FROM NEW JUNCTION BOX TO GATE LOCATION AS REQUIRED, MATCH EXISTING CONDITIONS. COORDINATE ALL WORK WITH CONCURRENT GATE RELOCATION PROJECT.
- (8) EXTEND EXISTING 2" CONDUITS AS REQUIRED FOR RELOCATED FIBER CABLING TO EXTERIOR GATE.
- $\left< 9 \right>$ 15KVA TRANSFORMER STACKED OVER 45KVA TRANSFORMER.

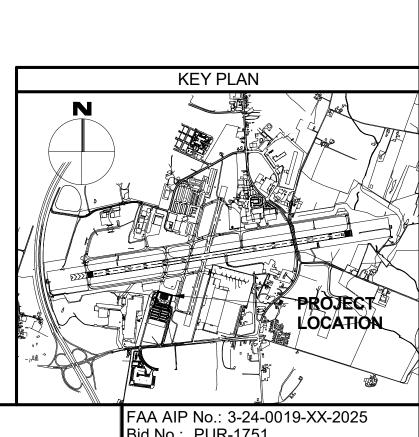





6011 UNIVERSITY BLVD. SUITE 490 ELLICOTT CITY, MD 21043 PHONE: 410-465-9600 **BUSHEY FEIGHT MORIN ARCHITECTS**

473 NORTH POTOMAC STREET

HAGERSTOWN, MD 21740

Expiration Date: <u>06/03/2026</u>

rofessional Certification: hereby certify that these documents were prepared or approved by me, and that I am a duly licensed professional engineer under the laws of the State of Maryland. License No. <u>45511</u>

	DESIGNED:	NAD	N o.	DATE 06-12-2025	DESCRIPTION ADDENDUM 2
nts ,	DRAWN:	NAD	2	06-18-2025	ADDENDUM 4
WS	CHECKED:	ALD			
	APPROVED:	СРМ			
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\ ENLARGED FIRST FLOOR PLAN - POWER & DATA


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	vvasnington County, IVID

ROJECT TITLE:	TERMINAL BUILDING EXPANSION	
HEET TITLE:		
	FIRST FLOOR PLAN - POWER & DATA	

As indicated

MAY 2025

MAA Grant No.: MAA-GR-XX-XXX
SUBMISSION: BID SET
SHEET No.: E3-1
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FEEDER TAG KEY

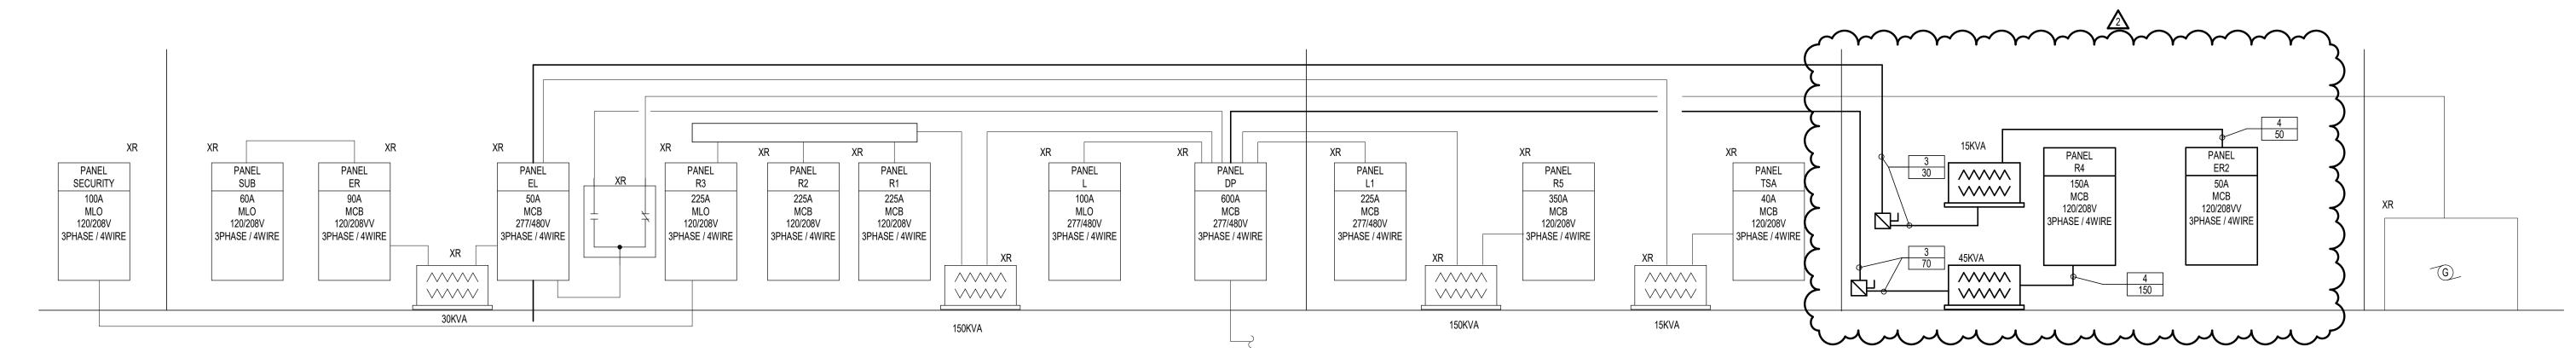NUMBER OF WIRES

WIRE AMPS

0100

NEW RISER DIAGRAM E6-1 NO SCALE

> BRANCH CIRCUIT & FEEDER SCHEDULE - COPPER CONDUCTORS UPDATED 01-01-2013 NOTE: THIS TABLE IS FOR FEEDERS AND BRANCH CIRCUITS. IT IS NOT TO BE USED FOR SERVICE ENTRANCE, MOTORS, COPPER CONDUCTOR; THHN / THWN INSULATION, 600 V OR TRANSFORMERS. USE FOR ALL METAL CONDUITS & PVC - 40 & PVC - 80

SERVICE OCP RATING (AMPS)	TYPE 2 (1 PHASE- 2W)	TYPE 3 (1 PHASE - 3W ; 3 PHASE - 3W)	TYPE 4 (3 PHASE - 4W)
20	2 #12, 1 #12 GND - 3/4"C	3 #12, 1 #12 GND - 3/4"C	4 #12, 1 #12 GND - 3/4"C
25	2 #10, 1 #10 GND - 3/4"C	3 #10, 1 #10 GND - 3/4"C	4 #10, 1 #10 GND - 3/4"C
30	2 #10, 1 #10 GND - 3/4"C	3 #10, 1 #10 GND - 3/4"C	4 #10, 1 #10 GND - 3/4"C
35	2 #8, 1 #10 GND - 3/4"C	3 #8, 1 #10 GND - 3/4"C	4 #8, 1 #10 GND - 1"C
40	2 #8, 1 #10 GND - 3/4"C	3 #8, 1 #10 GND - 3/4"C	4 #8, 1 #10 GND - 1"C
45	2 #6, 1 #10 GND - 3/4"C	3 #6, 1 #10 GND - 1"C	4 #6, 1 #10 GND - 1"C
50	2 #6, 1 #10 GND - 3/4"C	3 #6, 1 #10 GND - 1"C	4 #6, 1 #10 GND - 1"C
60	2 #4, 1 #10 GND - 3/4"C	3 #4, 1 #10 GND - 1"C	4 #4, 1 #10 GND - 1 1/4"C
70	2 #4, 1 #8 GND - 1"C	3 #4, 1 #8 GND - 1"C	4 #4, 1 #8 GND - 1 1/4"C
80	2 #3, 1 #8 GND - 1"C	3 #3, 1 #8 GND - 1 1/4"C	4 #3, 1 #8 GND - 1 1/4"C
90	2 #2, 1 #8 GND - 1"C	3 #2, 1 #8 GND - 1 1/4"C	4 #2, 1 #8 GND - 1 1/2"C
100	2 #1, 1 #8 GND - 1 1/4"C	3 #1, 1 #8 GND - 1 1/4"C	4 #1, 1 #8 GND - 1 1/2"C
110	2 #1, 1 #6 GND - 1 1/4"C	3 #1, 1 #6 GND - 1 1/4"C	4 #1, 1 #6 GND - 1 1/2"C
125	2 #1, 1 #6 GND - 1 1/4"C	3 #1, 1 #6 GND - 1 1/4"C	4 #1, 1 #6 GND - 1 1/2"C
150	2 #1/0, 1 #6 GND - 1 1/4"C	3 #1/0, 1 #6 GND - 1 1/2"C	4 #1/0, 1 #6 GND - 2"C
175	2 #2/0, 1 #6 GND - 1 1/2"C	3 #2/0, 1 #6 GND - 2"C	4 #2/0, 1 #6 GND - 2"C
200	2 #3/0, 1 #6 GND - 1 1/2"C	3 #3/0, 1 #6 GND - 2"C	4 #3/0, 1 #6 GND - 2"C
225	2 #4/0, 1 #4 GND - 2"C	3 #4/0, 1 #4 GND - 2"C	4 #4/0, 1 #4 GND - 2 1/2"C
250	2-250 KCMIL, 1 #4 GND - 2"C	3-250 KCMIL, 1 #4 GND - 2 1/2"C	4-250 KCMIL, 1 #4 GND - 2 1/2"C
300	2-350 KCMIL, 1 #4 GND - 2 1/2"C	3-350 KCMIL, 1 #4 GND - 3"C	4-350 KCMIL, 1 #4 GND - 3"C
350	2-500 KCMIL, 1 #3 GND - 3"C	3-500 KCMIL, 1 #3 GND - 3"C	4-500 KCMIL, 1 #3 GND - 3 1/2"C
400	2-600 KCMIL, 1 #3 GND - 3"C	3-600 KCMIL, 1 #3 GND - 3"C	4-600 KCMIL, 1 #3 GND - 4"C
450	2 SETS EACH: 2 #4/0, 1 #2 GND - 2"C	2 SETS EACH: 3 #4/0, 1 #2 GND - 2"C	2 SETS EACH: 4 #4/0, 1 #2 GND - 2 1/2"C
500	2 SETS EACH: 2-250 KCMIL, 1 #2 GND - 2"C	2 SETS EACH: 3-250 KCMIL, 1 #2 GND - 2 1/2"C	2 SETS EACH: 4-250 KCMIL, 1 #2 GND - 2 1/2"C
600	2 SETS EACH: 2-350 KCMIL, 1 #1 GND - 3"C	2 SETS EACH: 3-350 KCMIL, 1 #1 GND - 3"C	2 SETS EACH: 4-350 KCMIL, 1 #1 GND - 3 1/2"C
700	2 SETS EACH: 2-500 KCMIL, 1 #1/0 GND - 3"C	2 SETS EACH: 3-500 KCMIL, 1 #1/0 GND - 3"C	2 SETS EACH: 4-500 KCMIL, 1 #1/0 GND - 3 1/2"C
800	2 SETS EACH: 2-600 KCMIL, 1 #1/0 GND - 3"C	2 SETS EACH: 3-600 KCMIL, 1 #1/0 GND - 3 1/2"C	2 SETS EACH: 4-600 KCMIL, 1 #1/0 GND - 4"C
1000	3 SETS EACH: 2-500 KCMIL, 1 #2/0 GND - 3"C	3 SETS EACH: 3-500 KCMIL, 1 #2/0 GND - 3"C	3 SETS EACH: 4-500 KCMIL, 1 #2/0 GND - 3 1/2"C
1200	3 SETS EACH: 2-600 KCMIL, 1 #3/0 GND - 3"C	3 SETS EACH: 3-600 KCMIL, 1 #3/0 GND - 3 1/2"C	3 SETS EACH: 4-600 KCMIL, 1 #3/0 GND - 4"C
1600	4 SETS EACH: 2-600 KCMIL, 1 #4/0 GND - 3"C	4 SETS EACH: 3-600 KCMIL, 1 #4/0 GND - 3 1/2"C	4 SETS EACH: 4-600 KCMIL, 1 #4/0 GND - 4"C
2000	5 SETS EACH: 2-600 KCMIL, 1-250 KCMIL GND - 3"C	5 SETS EACH: 3-600 KCMIL, 1-250 KCMIL GND - 3 1/2"C	5 SETS EACH: 4-600 KCMIL, 1-250 KCMIL GND - 4"C
2500	6 SETS EACH: 2-600 KCMIL, 1-350 KCMIL GND - 3"C	6 SETS EACH: 3-600 KCMIL, 1-350 KCMIL GND - 3 1/2"C	6 SETS EACH: 4-600 KCMIL, 1-350 KCMIL GND - 4"C
3000	8 SETS EACH: 2-500 KCMIL, 1-500 KCMIL GND - 3"C	8 SETS EACH: 3-500 KCMIL, 1-500 KCMIL GND - 3"C	8 SETS EACH: 4-500 KCMIL, 1-500 KCMIL GND - 4"C
3500	9 SETS EACH: 2-600 KCMIL, 1-500 KCMIL GND - 3"C	9 SETS EACH: 3-600 KCMIL, 1-500 KCMIL GND - 3 1/2"C	9 SETS EACH: 4-600 KCMIL, 1-500 KCMIL GND - 4"C
4000	10 SETS EACH: 2-600 KCMIL, 1-500 KCMIL GND - 3"C	10 SETS EACH: 3-600 KCMIL, 1-500 KCMIL GND - 3 1/2"C	10 SETS EACH: 4-600 KCMIL, 1-500 KCMIL GND - 4"C

NOTE: FOR CABLE INSULATION OTHER THAN THHN / THWN, SIZE CONDUIT PER NEC.

BRANCH CIRCUIT & FEEDER SCHEDULE - COPPER CONDUCTORS

NO SCALE

ENGINEERING
5285 Westview Drive
Suite 203
Frederick, MD 21703
D 204 COE 0424





	Professional Certification:
OF MAR OPHER D	I hereby certify that these do were prepared or approved and that I am a duly license professional engineer unde of the State of Maryland.
45511 C	License No. <u>45511</u>

	DESIGNED:	NAD	No.	DATE	DESCRIPTION
ments			1	06-12-2025	ADDENDUM 2
me,			2	06-18-2025	ADDENDUM 4
	DRAWN:	NAD			
e laws					
	CHECKED:	ALD			
	CHECKED.				
	APPROVED:	CPM			
	·				<u> </u>



PROJECT TITLE: TERMINA	L BUILDING EXPANSION	FAA AIP No.: 3-24-0019-XX-2025 Bid No.: PUR-1751 MAA Grant No.: MAA-GR-XX-XXX
SHEET TITLE:		SUBMISSION: BID SET
	RISER DIAGRAMS	SHEET No.: E6-1
SCALE: NO SCALE	DATE: MAY 2025	100 of 102

KEY PLAN

