

VICINITY MAP

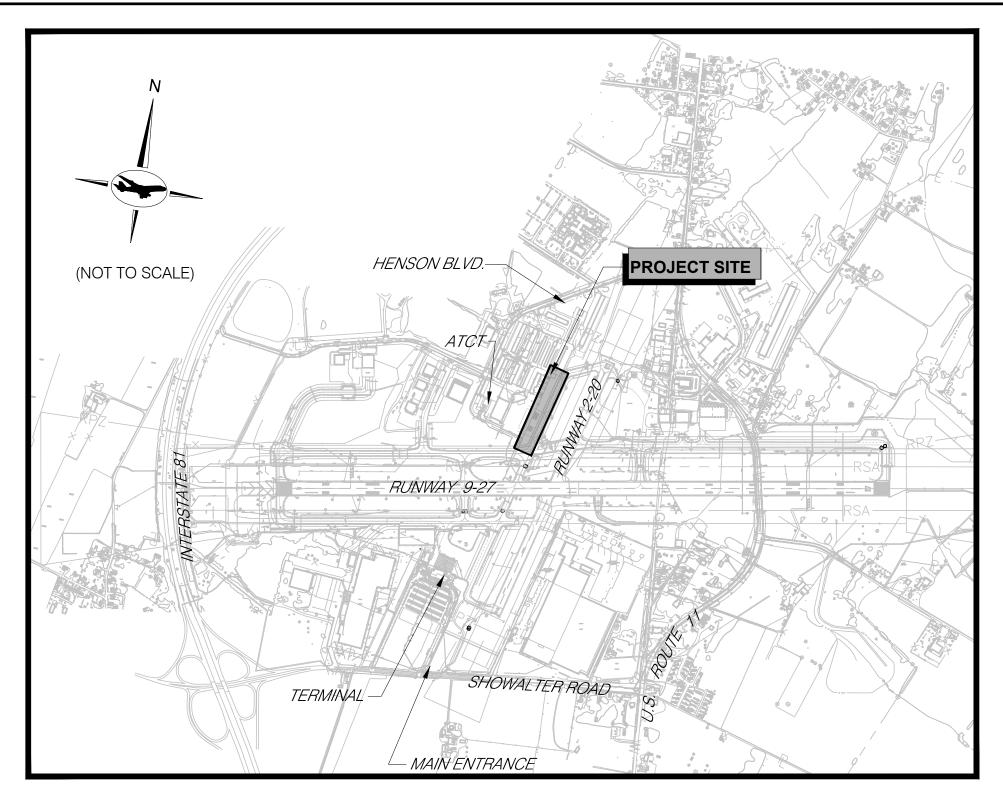


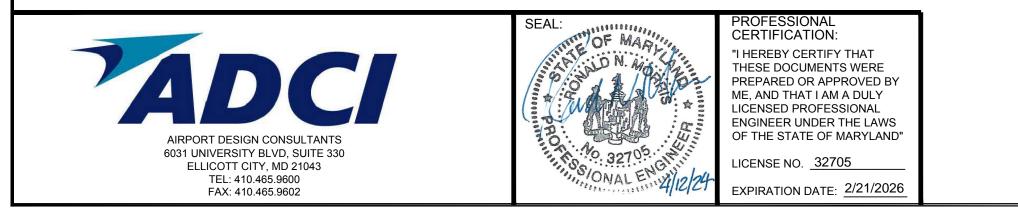



HAGERSTOWN **REGIONAL AIRPORT** Washington County, MD

TAXIWAY C OFA REHABILITATION A.I.G. No. 3-24-0019-070-2024 (DESIGN/CONSTRUCTION) **BID No. PUR-1674 BID DOCUMENTS APRIL 2024**

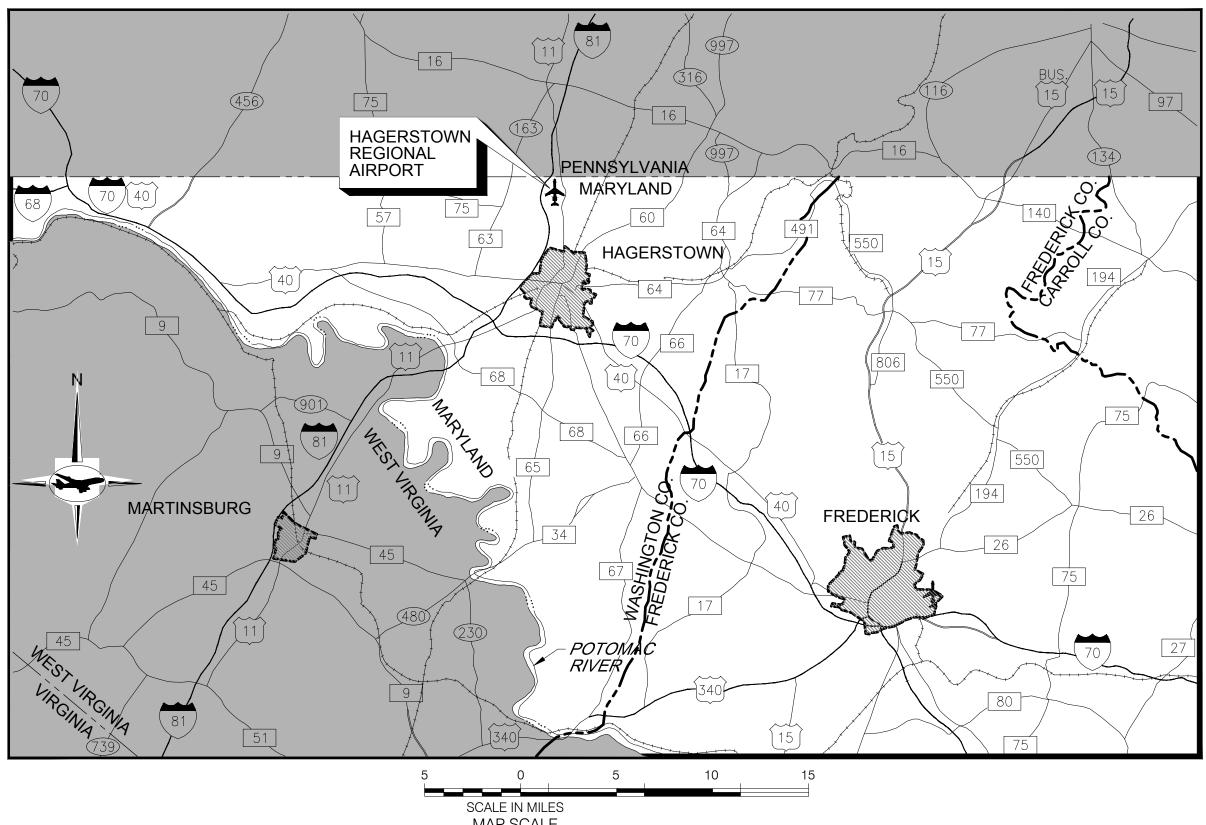

MAP SCALE

HAGERSTOWN

Washington County, MD

REGIONAL AIRPORT



WASHINGTON COUNTY DIVISION OF PLAN REVIEW & PERMITTING

DATE:

PPROVED

SIGNATURE

LOCATION MAP

HAGERSTOWN REGIONAL AIRPORT

APPROVED

	DRAWING INDEX					
NO.	DRAWING NO.	DRAWING TITLE				
	GENERAL					
1	G100	COVER SHEET				
2	G101	DRAWING INDEX AND SCHEDULE OF QUANTITIES				
3	G200	GENERAL CONSTRUCTION AND SAFETY NOTES 1				
4	G201	GENERAL CONSTRUCTION AND SAFETY NOTES 2				
5	G202	GENERAL PROJECT LAYOUT				
6	G203	SURVEY CONTROL, BASELINE LAYOUT, AND BORING PLAN				
7	G204	MAXIMUM EQUIPMENT HEIGHT PLAN				
8	G300	OVERALL CONSTRUCTION SAFETY AND PHASING PLAN				
9	G301	CONSTRUCTION SAFETY AND PHASING PLAN - PHASE 1				
10	G302	CONSTRUCTION SAFETY AND PHASING PLAN - PHASE 2				
11	G303	CONSTRUCTION SAFETY AND PHASING PLAN - PHASE 3				
12	G500	CONSTRUCTION SAFETY AND PHASING NOTES AND DETAILS				
		CIVIL				
13	C100	EXISTING CONDITIONS AND DEMOLITION PLAN				
14	C200	PAVING PLAN				
15	C250	PAVING DETAILS				
16	C300	MARKING PLAN				
17	C350	MARKING DETAILS				
18	C400	BORING LOGS				

CONSULTANT: TARPORT DESIGN CONSULTANTS 6031 UNIVERSITY BLVD, SUITE 330 ELLICOTT CITY, MD 21043 TEL: 410.465.9600 FAX: 410.465.9602 FILE NAME: O:\HGR\Projects\2023-1303 TWC\CAD\SHEETS\0002_G101_DRAWING INDE		PROFESSIONAL CERTIFICATION: "I HEREBY CERTIFY THAT THESE DOCUMENTS WERE PREPARED OR APPROVED BY ME, AND THAT I AM A DULY LICENSED PROFESSIONAL ENGINEER UNDER THE LAWS OF THE STATE OF MARYLAND" LICENSE NO. <u>32705</u> EXPIRATION DATE: <u>2/21/2026</u>	DESIGNED: M.J.B. DRAWN: R.D.H. CHECKED: R.N.M. APPROVED: M.S.K.		REVISION DATE	
FILE NAME. O. INGRIFIUJEUS/2023-1303 TWG/CAD/SHEETS/0002_GT0T_DRAWING INDE	EX AND SCHEDULE OF QUANTITIES.uwg	LATOUT NAME. GTUT USER. MBISHOP	FLUTTED. Fliday, A	vprii 12, 2024 - 4	.uspin	

	QUANTITIES						
PAY ITEM	DESCRIPTION	UNIT	QUANTITY	AS-BUILT			
M-100-4.1	MAINTENANCE AND PROTECTION OF TRAFFIC AND CSPP	LS	1				
M-150-5.1	PROJECT SURVEY AND STAKEOUT	LS	1				
C-100-1.1	CONTRACTOR QUALITY CONTROL PROGRAM (CQCP)	LS	1				
C-105-6.1	MOBILIZATION	LS	1				
P-101-5.1	COLD MILLING, 3-INCH DEPTH	SY	11,300				
P-101-5.2	REMOVAL OF EXISTING JOINT SEALANT	LF	1,400				
P-401-8.1	ASPHALT MIX PAVEMENT SURFACE COURSE	TON	2,100				
P-603-5.1	EMULSIFIED ASPHALT TACK COAT	GAL	1,200				
P-605-5.1	JOINT SEALING	LF	1,400				
P-620-5.1	PAVEMENT MARKING REMOVAL	SF	2,200				
P-620-5.2	PERMANENT PAVEMENT MARKING - WATERBORNE	SF	8,400				
P-620-5.3	TEMPORARY PAVEMENT MARKING - WATERBORNE	SF	3,800				
P-620-5.4	THERMOPLASTIC PAVEMENT MARKING (NON-AIP ELIGIBLE)	SF	450				



TAXIWAY C OFA REHABILITATION

FAA AIG No.: 3-24-0019-070-2024 (DESIGN/CONSTRUCTION) Bid No.: PUR-1674

DRAWING INDEX AND SCHEDULE OF QUANTITIES

N.A.

DATE:

APRIL 2024

G101

2 OF 18

SHEET NO .:

GENERAL CONSTRUCTION NOTES:

- 1. THIS PROJECT SHALL BE CONSTRUCTED IN ACCORDANCE WITH THE CONTRACT PLANS AND SPECIFICATIONS AND ANY RULES. REGULATIONS. STANDARDS OR SPECIFICATIONS REFERENCED THEREIN. THE PROJECT IS SUBJECT TO INSPECTION BY REPRESENTATIVES OF WASHINGTON COUNTY (THE AIRPORT SPONSOR), THEIR AUTHORIZED REPRESENTATIVES, THE FEDERAL AVIATION ADMINISTRATION (FAA), AND OTHER GOVERNING AGENCIES.
- 2. THE PROJECT IS TO BE COMPLETED IN CLOSE CONFORMANCE WITH THE CONSTRUCTION PLANS AND CONTRACT SPECIFICATIONS AND SHALL BE CONSTRUCTED IN A TIMELY MANNER IN ACCORDANCE WITH THE CONTRACTOR'S APPROVED PROJECT SCHEDULE. THE SCHEDULE SHALL PROVIDE FOR COMPLETION OF THE PHASES AS SHOWN ON THE PLANS AND DESCRIBED IN THE CONTRACT SPECIFICATIONS.
- 3. THE CONTRACTOR IS EXPECTED TO COMPLETE THE ENTIRE PROJECT ON TIME. THE IMPORTANCE OF THIS IS STRESSED BY THE INCLUSION OF LIQUIDATED DAMAGES IN THE SPECIFICATIONS.
- HAGERSTOWN REGIONAL AIRPORT WILL BE IN OPERATION DURING THE CONSTRUCTION OF THIS PROJECT COORDINATION OF WORK WITH THE AIRPORT AND AIRLINES (THROUGH THE AIRPORT DIRECTOR) IS MANDATORY SO AS TO MINIMIZE IMPACTS ON AIRPORT OPERATIONS.
- 5. CONSTRUCTION AND MAINTENANCE OPERATIONS BY OTHERS WILL OCCUR CONCURRENTLY AND AT TIMES IN THE VICINITY OF CONSTRUCTION ASSOCIATED WITH THIS PROJECT. THE CONTRACTOR SHALL COORDINATE HIS OPERATIONS AND COOPERATE WITH MAINTENANCE CREWS AND OTHER CONTRACTORS WORKING ON THE AIRPORT. COORDINATION WITH APPROPRIATE GOVERNMENT AND UTILITY AGENCIES IS ALSO REQUIRED.
- 6. ACCESS TO THE SITE THE CONTRACTOR'S ACCESS POINTS TO THE SITE ARE SHOWN ON THE GENERAL PROJECT LAYOUT PLAN. THE CONTRACTOR SHALL BE RESPONSIBLE FOR ALL VEHICLES AND PERSONNEL WHO ENTER THE AIRPORT PROPERTY. THE CONTRACTOR SHALL CONSULT WITH THE MAINTENANCE DEPARTMENT AT THE BEGINNING AND ENDING OF EACH WORK PERIOD.
- 7. HAUL ROUTES THE CONTRACTOR'S ON-AIRPORT HAUL ROUTES ARE SHOWN ON THE GENERAL PROJECT LAYOUT ANY DEBRIS (WHETHER CAUSED BY THE CONTRACTOR OR NOT) SHALL BE REMOVED IMMEDIATELY.


IT SHALL BE THE CONTRACTOR'S RESPONSIBILITY TO COORDINATE OFF-SITE HAUL ROUTES (STATE HIGHWAYS, COUNTY ROADS. OR CITY STREETS) WITH THE APPROPRIATE OWNER WHO HAS JURISDICTION OVER THE AFFECTED ROUTE. ON-SITE PAVEMENTS USED AS HAUL ROUTES SHALL BE MAINTAINED BY THE CONTRACTOR AND SHALL BE RESTORED AT THE CONTRACTOR'S EXPENSE TO THEIR PRE-CONSTRUCTION CONDITION UPON COMPLETION OF BEING USED AS A HAUL ROUTE. THE BEFORE AND AFTER CONDITION OF ON-SITE HAUL ROUTES SHALL BE JOINTLY INSPECTED AND DETERMINED BY THE CONTRACTOR AND THE RESIDENT PROJECT REPRESENTATIVE(RPR).

FENCING, DRAINAGE, GRADING AND OTHER MISCELLANEOUS CONSTRUCTION REQUIRED TO CONSTRUCT TEMPORARY HAUL ROUTES OR ACCESS POINTS ON THE AIRPORT WILL BE THE CONTRACTOR'S TOTAL RESPONSIBILITY AND SHALL BE APPROVED BY THE RPR PRIOR TO COMMENCING THE WORK. THIS WORK IS CONSIDERED INCIDENTAL TO WORK AND NO SEPARATE PAYMENT WILL BE MADE. ALL ON-SITE ACCESS TO AIRPORT FACILITIES SHALL REMAIN OPEN AND MAINTAINED AT ALL TIMES.

- CONTRACTOR'S STAGING AREAS AREAS ARE AVAILABLE FOR CONTRACTOR'S MOBILIZATION AND STORAGE. THESE AREAS ARE SHOWN ON THE GENERAL PROJECT LAYOUT AND PHASING PLANS. THE CONTRACTOR'S STAGING AREAS SHALL BE GRADED, TOPSOILED, SEEDED, AND MULCHED UPON COMPLETION OF USE.
- DISPOSAL AREA ALL MATERIALS THAT ARE SALVAGEABLE INCLUDING PAVEMENT MILLINGS. AND ARE DESIRED BY AIRPORT MAINTENANCE SHALL BE TURNED OVER TO THE AIRPORT. THE AIRPORT WILL ACCEPT A MAXIMUM OF 10 TRUCKLOADS OF PAVEMENT MILLINGS. A DISPOSAL AREA FOR THE NONSALVAGEABLE MATERIAL WILL NOT BE AVAILABLE ON AIRPORT PROPERTY. THE CONTRACTOR'S WASTE MATERIALS, SHALL BE DISPOSED OF OFF AIRPORT PROPERTY. WASTE MATERIALS INCLUDE THOSE ITEMS WHICH ARE A DIRECT RESULT OF CONSTRUCTION. TRASH (I.E. CUPS, CANS, ETC.) SHALL BE DISPOSED OF THROUGH

PROPER SANITARY METHODS.

- 10. SAFETY THE CONTRACTOR SHALL CONDUCT HIS ACTIVITIES IN A SAFE MANNER AS SPECIFIED IN THE SECTION TITLED, "CONTRACTORS SAFETY REQUIREMENTS DURING CONSTRUCTION" ON THIS SHEET.
- 11. PROTECTION OF AND REPAIR TO EXISTING CABLES -LOCATIONS OF KNOWN EXISTING AIRPORT UNDERGROUND CABLES ARE SHOWN ON THE PLANS AND MUST BE VERIFIED BY THE CONTRACTOR. REPAIR OF DAMAGED CABLES MUST BE STARTED IMMEDIATELY AND CONTINUED UNTIL COMPLETED. ALL SUCH REPAIRS SHALL BE IN ACCORDANCE WITH THE SPECIFICATIONS AND SHALL BE AT THE CONTRACTOR'S EXPENSE. IF FAA CABLES ARE DAMAGED. REPAIRS SHALL BE DONE IN ACCORDANCE WITH FAA REQUIREMENTS AND IN THE PRESENCE OF AN FAA REPRESENTATIVE. THE FAA MAY ELECT TO HAVE THE REPAIR PERFORMED BY OTHERS IN WHICH CASE THE CONTRACTOR SHALL BE RESPONSIBLE FOR PAYING THE INCURRED COSTS OF REPAIRS.
- 12. ALL CONSTRUCTION EQUIPMENT IS LIMITED TO A MAXIMUM HEIGHT OF 25 FEET. IF ANY EQUIPMENT IS GOING TO BE HIGHER THAN 25', CONTRACTOR MUST COORDINATE WITH RPR.
- 13. CONSTRUCTION LIMITS ALL CONTRACTOR VEHICLES AND TRAFFIC (UNLESS OTHERWISE AUTHORIZED) SHALL REMAIN WITHIN THE DESIGNATED CONSTRUCTION LIMITS OR HAUL ROUTES. CONSTRUCTION, STORAGE AND STOCKPILING LIMITS ARE FURTHER DEFINED IN THE SECTION TITLED. "CONTRACTORS SAFETY REQUIREMENTS DURING CONSTRUCTION" ON THIS SHEET.
- 14. THE CONTRACTOR SHALL OBTAIN ALL THE PERMITS AND LICENSES REQUIRED FOR THE PROJECT WORK AT HIS OWN EXPENSE.
- 15. BASE MAPPING FOR THIS PROJECT IS BASED ON HISTORICAL MAPPING PROVIDED BY THE AIRPORT.
- 16. EXISTING AND PROPOSED GRADES EXISTING GRADES SHOWN ON THE DRAWINGS ARE BELIEVED TO BE ACCURATE, BUT THE SPONSOR, OR RPR ASSUMES NO RESPONSIBILITY FOR THE ACCURACY OF THESE GRADES. IF THE CONTRACTOR DOES NOT CONCUR WITH THE ELEVATIONS GIVEN ON THE DRAWINGS, HE SHALL NOTIFY THE RPR IN WRITING PRIOR TO INITIATING ANY CONSTRUCTION ACTIVITIES. START OF WORK BY THE CONTRACTOR WITHOUT SUCH NOTIFICATION WILL BE INTERPRETED AS AN AGREEMENT BY THE CONTRACTOR WITH THE ACCURACY OF THE GRADES SHOWN ON THE PLANS.
- 17. PERMITS THE CONTRACTOR MUST OBTAIN APPROPRIATE PERMITS FROM THE PROPER GOVERNMENT AGENCIES FOR ACCESS TO, AND TO USE THEIR ROADS FOR DELIVERY OF MATERIALS AND EQUIPMENT TO THE SITE. ANY DAMAGE TO OFF-SITE OR ON-SITE ROADS SHALL BE REPAIRED BY THE CONTRACTOR AT HIS EXPENSE. IF BLASTING IS REQUIRED TO FACILITATE EXCAVATION PROPER PERMITS MUST BE OBTAINED.
- 18. IF BLASTING IS BEING PROPOSED BY THE CONTRACTOR, THE CONTRACTOR WILL BE REQUIRED TO SUBMIT A BLASTING PLAN. THE CONTRACTOR OR SUBCONTRACTOR PERFORMING THE BLASTING IS REQUIRED TO BE LICENSED IN THE STATE OF MARYLAND IN ACCORDANCE WITH THE MARYLAND PUBLIC SAFETY CODE, TITLE 11, EXPLOSIVES. THE CONTRACTOR SHALL OBTAIN A BLASTER'S PERMIT FROM THE STATE OF MARYLAND. DEPARTMENT OF STATE POLICE. OFFICE OF THE STATE FIRE MARSHALL FOR GENERAL ABOVE GROUND CONSTRUCTION. THE COST FOR OBTAINING SUCH LICENSES AND PERMITS SHALL BE INCIDENTAL TO THE PROJECT.

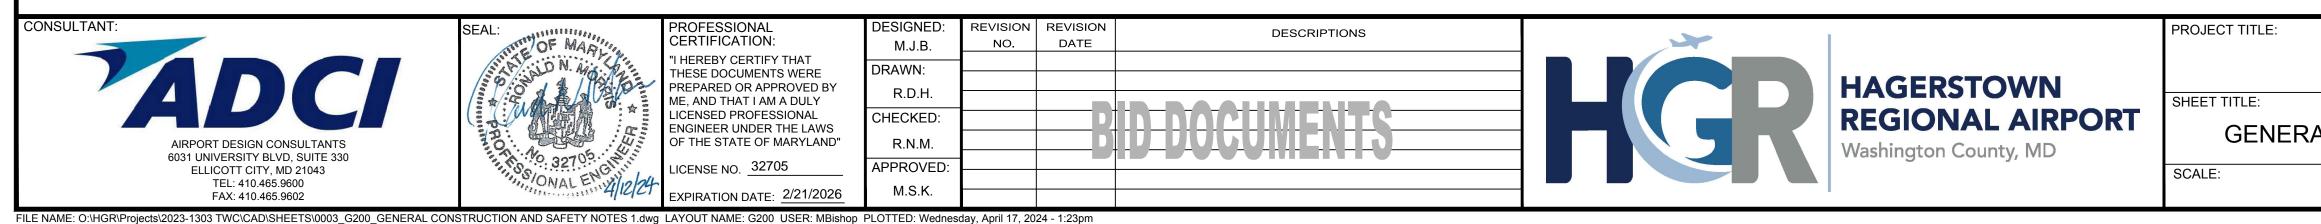

CONTRACTORS SAFETY REQUIREMENTS DURING CONSTRUCTION:

FEDERAL AVIATION ADMINISTRATION (FAA) ADVISORY CIRCULARS (AC), ORDERS AND FEDERAL AVIATION REGULATIONS (F A R).

FOLLOWING PUBLICATIONS CONTAIN THE DEFINITIONS/DESCRIPTIONS OF CRITICAL AIRPORT OPERATING AREAS. THE AREAS DEFINED BELOW PERTAIN TO AIRFIELD SAFETY REQUIREMENTS AND ARE REFERENCED THROUGHOUT THE CONTRACT DOCUMENTS. COPIES OF THESE PUBLICATIONS ARE AVAILABLE THROUGH THE FAA AND CAN BE REVIEWED AT THE OFFICES OF THE HAGERSTOWN REGIONAL AIRPORT.

- 1. AC 150/5370-2G, "OPERATIONAL SAFETY ON AIRPORTS DURING CONSTRUCTION", CURRENT EDITION, SETS FORTH GUIDELINES TO ASSIST AIRPORT OPERATORS IN COMPLYING WITH F A R PART 139. "CERTIFICATION AND OPERATION: LAND AIRPORTS SERVING CERTAIN AIR CARRIERS" AND WITH THE REQUIREMENTS OF FEDERALLY FUNDED CONSTRUCTION PROJECTS.
- 2. F A R PART 77 "OBJECTS AFFECTING NAVIGABLE AIRSPACE, CURRENT EDITION:
 - (A) ESTABLISHES STANDARDS FOR DETERMINING OBSTRUCTIONS TO NAVIGABLE AIRSPACE. CIVIL AIRPORT IMAGINARY SURFACES ARE DEFINED IN THE PUBLICATION AND ARE SHOWN ON THE SAFETY/PHASING NOTES AND DETAILS.
 - (B) SETS FORTH REQUIREMENTS FOR NOTICE OF CERTAIN PROPOSED CONSTRUCTION OR ALTERATION. NOTICE OF CONSTRUCTION PROVIDES A BASIS FOR RECOMMENDATIONS FOR IDENTIFYING THE CONSTRUCTION OR ALTERATION IN ACCORDANCE WITH AC 70/7460-1L "OBSTRUCTION MARKING AND LIGHTING," CURRENT EDITION.
- 3. AC 150/5300-13B. "AIRPORT DESIGN", CURRENT EDITION. ESTABLISHES DESIGN, OPERATIONAL, AND MAINTENANCE STANDARDS FOR AIRPORTS. STANDARD TERMS DEFINED IN THIS AC AND USED IN THE CONTRACT PLANS AND SPECIFICATIONS ARE DEFINED BELOW:
 - (A) OBSTACLE FREE ZONE (OFZ) A VOLUME OF SPACE WHICH IS FREE OF ALL FIXED OBJECTS AND CLEAR OF VEHICLES IN THE PROXIMITY OF AN AIRPLANE CONDUCTING AN APPROACH, MISSED APPROACH, LANDING, TAKEOFF, OR DEPARTURE. AN OFZ TYPICAL SECTION IS SHOWN ON THE SAFETY/PHASING NOTES AND DETAILS SHEET.
 - (B) RUNWAY PROTECTION ZONE (RPZ): A TRAPEZOIDAL AREA CENTERED ON THE RUNWAY BEGINNING AT A POINT 200 FEET BEYOND THE END OF THE AREA USABLE FOR TAKEOFF OR LANDING. THE RPZ IS SHOWN ON THE GENERAL PROJECT LAYOUT PLAN.
 - (C) OBJECT FREE AREA (OFA): A TWO DIMENSIONAL GROUND AREA SURROUNDING RUNWAYS, TAXIWAYS, AND TAXILANES WHICH IS CLEAR OF OBJECTS EXCEPT FOR OBJECTS WHOSE LOCATION IS FIXED BY FUNCTION.
 - (D) SAFETY AREA THE SURFACE ADJACENT TO RUNWAYS. TAXIWAYS, AND TAXILANES OVER WHICH AIRCRAFT SHOULD, IN DRY WEATHER, BE ABLE TO CROSS AT NORMAL SPEEDS WITHOUT INCURRING SIGNIFICANT DAMAGE. A SAFETY AREA IS GRADED, DRAINED AND COMPACTED. IT IS FREE OF ANY HOLES, TRENCHES BUMPS OR OTHER SIGNIFICANT SURFACE VARIATIONS OR OBJECTS OTHER THAN THOSE WHICH MUST BE THERE BECAUSE OF THEIR ESSENTIAL AERONAUTICAL FUNCTION. THE SAFETY AREA REQUIRES THE CAPABILITY OF SUPPORTING MAINTENANCE VEHICLES AND AIRCRAFT RESCUE AND FIRE FIGHTING VEHICLES UNDER NORMAL (DRY) CONDITIONS.
- B GENERAL SAFETY REQUIREMENTS
 - 1. THE CONTRACTOR SHALL ACQUAINT HIS SUPERVISORS AND EMPLOYEES WITH THE AIRPORT ACTIVITY AND OPERATIONS THAT ARE INHERENT TO HAGERSTOWN REGIONAL AIRPORT AND SHALL CONDUCT HIS CONSTRUCTION ACTIVITIES TO CONFORM TO ALL ROUTINE AND EMERGENCY AIR TRAFFIC REQUIREMENTS AND GUIDELINES FOR SAFETY SPECIFIED HEREIN. THF CONTRACTOR SHALL BE RESPONSIBLE FOR PROVIDING ALL SAFETY DEVICES AS REQUIRED FOR THE PROTECTION OF HIS PERSONNEL.
 - 2. PROTECTION OF ALL PERSONS SHALL BE PROVIDED THROUGHOUT THE PROGRESS OF THE WORK. THE WORK SHALL PROCEED IN SUCH A MANNER AS TO PROVIDE SAFE CONDITIONS FOR ALL WORKERS AND GOVERNMENT PERSONNEL. THE SEQUENCE OF OPERATION SHALL BE SUCH THAT MAXIMUM PROTECTION IS AFFORDED TO INSURE THAT PERSONNEL AND WORKERS IN THE WORK AREA ARE NOT SUBJECT TO ANY DANGEROUS CONDITIONS. THE CONTRACTOR MUST PROVIDE SAFETY MEASURES TO GUARD AGAINST INJURY.

- 3. DURING PERFORMANCE OF THIS CONTRACT, THE AIRPOF RUNWAYS, TAXIWAYS, AND AIRCRAFT PARKING APRONS SHAI REMAIN IN USE BY AIRCRAFT TO THE MAXIMUM EXTEN POSSIBLE. ALL AIRCRAFT TRAFFIC ON THESE AREAS SHA HAVE PRIORITY OVER CONTRACTOR'S TRAFFIC. THE OWNE RESERVES THE RIGHT TO ORDER THE CONTRACTOR AT AN TIME TO VACATE ANY AREA NECESSARY TO MAINTAIN SAF AIRCRAFT OPERATIONS. USE OF AREAS NEAR TH CONTRACTOR'S WORK WILL BE CONTROLLED TO MINIMIZ DISTURBANCE TO THE CONTRACTOR'S OPERATION. TH CONTRACTOR SHALL NOT ALLOW EMPLOYEE SUBCONTRACTORS, SUPPLIERS, OR ANY OTHE UNAUTHORIZED PERSON TO ENTER OR REMAIN IN AN AIRPORT AREA WHICH WOULD BE HAZARDOUS TO PERSONS C TO AIRCRAFT OPERATIONS.
- CONSTRUCTION AND FACILITIES MAINTENANCE С
 - 1. THE CONTRACTOR SHALL BE AWARE OF AND PREVENT THE FOLLOWING TYPES OF SAFETY PROBLEMS AND/OR HAZARDS:
 - (A) TRENCHES, HOLES, OR EXCAVATION ON OR ADJACENT ANY OPEN RUNWAY OR IN SAFETY AREAS.
 - (B) UNMARKED/UNLIGHTED HOLES OR EXCAVATION IN AN APRON, OPEN TAXIWAY, OPEN TAXILANE, OR RELATE SAFETY AREA.
 - (C) MOUNDS OR PILES OF EARTH. CONSTRUCTION MATERIAL TEMPORARY STRUCTURES. OR OTHER OBJECTS IN TH VICINITY OF THE OPEN RUNWAY, TAXIWAYS, TAXILANES, (
 - IN A RELATED SAFETY APPROACH OR DEPARTURE AREA. (D) VEHICLES OR EQUIPMENT. WHETHER OPERATING OR IDL ON ANY OPEN RUNWAY, TAXIWAY, TAXILANE, OR IN AN RELATED SAFETY APPROACH OR DEPARTURE AREA.
 - (E) VEHICLES, EQUIPMENT, EXCAVATION, STOCKPILES, OTHER MATERIALS WHICH COULD DEGRADE OTHERWISE INTERFERE WITH ELECTRONIC SIGNALS FRO RADIOS OR ELECTRONIC NAVIGATIONAL AIDS (NAVAIDS).
 - (F) PAVEMENT DROP-OFFS OR PAVEMENT TURF-LIPS (EITHE PERMANENT OR TEMPORARY) WHICH COULD CAUS DAMAGE TO AIRCRAFT IF CROSSED AT NORMA OPERATING SPEEDS. THE NORMAL MAXIMUM DROP-O OR LIP IS 1-1/2 INCHES.
 - (G) UNMARKED UTILITY, NAVAID, WEATHER SERVICE, RUNWA LIGHTING, OR OTHER POWER OR SIGNAL CABLES THA COULD BE DAMAGED DURING CONSTRUCTION.
 - (H) OBJECTS, WHETHER OR NOT MARKED OR FLAGGED, C ACTIVITIES ANYWHERE ON OR IN THE VICINITY OF AIRPOR WHICH COULD BE DISTRACTING, CONFUSING, O ALARMING TO PILOTS DURING AIRCRAFT OPERATIONS.
 - UNFLAGGED/UNLIGHTED LOW VISIBILITY ITEMS SUCH A (1) TALL CRANES, DRILLS, AND THE LIKE ANYWHERE IN TH VICINITY OF ACTIVE RUNWAYS, OR IN ANY APPROACH O DEPARTURE AREAS.
 - (J) MISLEADING OR MALFUNCTIONING OBSTRUCTION LIGHT OR UNLIGHTED/UNMARKED OBSTRUCTIONS IN TH APPROACH TO ANY ACTIVE RUNWAY.
 - (K) INADEQUATE APPROACH/DEPARTURE SURFACES (THES SURFACES ARE NEEDED TO ASSURE ADEQUAT LANDING/TAKEOFF CLEARANCE OVER OBSTRUCTIONS. OF WORK OR STORAGE AREAS).
 - (L) INADEQUATE, CONFUSING OR MISLEADING (TO USE PILOTS) MARKING/LIGHTING OF RUNWAYS, TAXIWAYS, OF TAXILANES (INCLUDING DISPLACED OR RELOCATE THRESHOLDS).
 - (M) WATER, SNOW, DIRT, DEBRIS, OR OTHER TRANSIEN ACCUMULATION WHICH TEMPORARILY OBSCURE PAVEMENT MARKINGS OR PAVEMENT EDGES, OR REDUCE
 - VISIBILITY OF RUNWAY/TAXIWAY MARKINGS OR LIGHTING. (N) INADEQUATE OR IMPROPER METHODS OF MARKING BARRICADING, AND LIGHTING OF TEMPORARILY CLOSE PORTIONS OF THE AIRPORT OPERATIONS AREA.
 - (O) TRASH OR OTHER MATERIALS WITH FOREIGN OBJEC DAMAGE (FOD) POTENTIAL; WHETHER ON RUNWAYS TAXIWAYS. OR APRONS: OR IN RELATED SAFETY AREAS.
 - (P) INADEQUATE BARRICADING OR OTHER MARKING WHICH PLACED TO SEPARATE CONSTRUCTION OR MAINTENANCI AREAS FROM OPEN AIRCRAFT OPERATING AREAS.
 - (Q) FAILURE TO CONTROL UNAUTHORIZED VEHICLE AN HUMAN ACCESS FROM ACTIVE AIRCRAFT OPERATING AREAS.
 - (R) FAILURE TO MAINTAIN RADIO COMMUNICATION BETWEE CONSTRUCTION/MAINTENANCE VEHICLES AND AIR TRAFFI CONTROL TOWER.
 - (S) CONSTRUCTION/MAINTENANCE ACTIVITIES OR MATERIAL WHICH COULD HAMPER THE RESPONSE OF AIRCRAF RESCUE AND FIRE FIGHTING (ARFF) OR OTHE EMERGENCY EQUIPMENT FROM REACHING AIRCRAFT. AL OR ANY PART OF THE RUNWAY/TAXIWAY SYSTEM, RUNWAY APPROACH AND DEPARTURE AREAS AND TO AIRCRAF PARKING LOCATIONS.
 - (T) BIRD ATTRACTANTS ON AIRPORT SUCH AS: EDIBLES (FOOL SCRAPS, ETC.), MISCELLANEOUS TRASH, OR PONDE WATER

RT ALL NT ALL ER NY		2. THE CONTRACTOR SHALL CONDUCT ACTIVITIES SO AS NOT TO VIOLATE ANY SAFETY STANDARDS CONTAINED HEREIN. THE CONTRACTOR SHALL INSPECT ALL CONSTRUCTION AND STORAGE AREAS AS OFTEN AS NECESSARY AND PROMPTLY TAKE ALL STEPS NECESSARY TO PREVENT/REMEDY ANY UNSAFE OR
NFE HE IZE ES, ER NY OR		POTENTIALLY UNSAFE CONDITIONS OR ACTIVITIES DISCOVERED. 3. BEFORE ACTUAL COMMENCEMENT OF CONSTRUCTION ACTIVITY, THE CONTRACTOR SHALL NOTIFY, IN WRITING, AT LEAST 48 HOURS IN ADVANCE, THE AIRPORT DIRECTOR OF HIS INTENTIONS OF CONSTRUCTION, STATING THE PROPOSED TIME, DATE, AND AREA OF WHICH COMMENCEMENT IS TO OCCUR.
ТО		UPON COMPLETION OF WORK AND RETURN OF ALL RELATED AREAS TO STANDARD CONDITIONS, THE CONTRACTOR SHALL AGAIN NOTIFY THE AIRPORT DIRECTOR, IN WRITING, AND DESCRIBE THE AREA THAT IS COMPLETE AND AVAILABLE FOR NORMAL AIRPORT OPERATIONS.
NY FED NLS, FHE OR DLE, NY OR OR		THE ISSUANCE OF NOTAMS SHALL BE REQUIRED FOR ALL AIRFIELD IMPACTS (I.E. RUNWAY CLOSURES, TAXIWAY CLOSURES, NAVAID IMPACTS, BLASTING, ETC.). THE CONTRACTOR SHALL COORDINATE THE NECESSARY NOTAMS FOR ALL AIRFIELD IMPACTS WITH THE RESIDENT PROJECT REPRESENTATIVE (RPR) AND THE OWNER A MINIMUM OF 72 HOURS IN ADVANCE OF THE DESIRED CLOSURE. IN ACCORDANCE WITH THE CONTRACTORS ACCEPTED SCHEDULE, THE CONTRACTOR SHALL ALSO PROVIDE A MINIMUM OF TWO (2) WEEKS PRIOR WRITTEN NOTIFICATION, TO THE RPR, OF ANTICIPATED AIRFIELD IMPACTS
OM IER JSE JAL DFF	D	THE AIRPORT DIRECTOR WILL BE RESPONSIBLE FOR ISSUING APPROPRIATE NOTICE TO AIR MISSIONS (NOTAM) CONCERNING CONSTRUCTION ACTIVITY ON THE AIRFIELD. MOTORIZED VEHICLES
AY AT OR RT OR AS HE OR TS		THIS PROJECT INCLUDES WORK WITHIN THE AIRFIELD OPERATIONS AREA (AOA) (I.E.), THE SECURE PORTION OF THE AIRPORT. ALL PERMITTED VEHICLES SHALL DISPLAY IN FULL VIEW ABOVE THE VEHICLE A 3-FOOT X 3-FOOT OR LARGER, ORANGE AND WHITE CHECKERBOARD, PLASTIC FLAG. EACH CHECKERBOARD COLOR SHALL BE ONE FOOT SQUARE. IN LIEU OF FLAGS, VEHICLES MAY DISPLAY A FLASHING AMBER (YELLOW) DOME-TYPE LIGHT, MOUNTED ON TOP OF THE VEHICLE AND OF SUCH INTENSITY TO CONFORM TO LOCAL CODES FOR MAINTENANCE AND EMERGENCY VEHICLES. THESE LIGHTS SHALL REMAIN FLASHING AT ALL TIMES WHEN THE VEHICLE IS IN THE AOA, EVEN IF PARKED.
HE SE TE DR ER DR ED		ANY VEHICLE OPERATING IN THE AOA DURING THE HOURS OF DARKNESS SHALL BE EQUIPPED WITH A FLASHING AMBER (YELLOW) DOME-TYPE LIGHT, MOUNTED ON TOP OF THE VEHICLE AND OF SUCH INTENSITY TO CONFORM TO LOCAL CODES FOR MAINTENANCE AND EMERGENCY VEHICLES. DARKNESS SHALL BE DEFINED AS ONE HOUR BEFORE OFFICIAL SUNSET UNTIL ONE HOUR AFTER SUNRISE.
NT ES ES IG, ED		ALL VEHICLES OPERATING WITHIN THE AIRFIELD BOUNDARY SHALL BE IDENTIFIED WITH A SIGN ON EACH SIDE OF THE VEHICLE BEARING THE CONTRACTOR'S NAME. THE MINIMUM SIZE FOR LETTERING ON THE VEHICLE SIGNS IS 12 INCHES. IN ADDITION ALL CONSTRUCTION VEHICLES OPERATING IN THE AIRFIELD MUST BE ISSUED AND DISPLAY AN AIRPORT VEHICLE ID TAG.
CT /S, IS CE		VEHICLES MAKING ONLY OCCASIONAL VISITS TO THE JOB SITE ARE EXEMPT FROM THE IDENTIFICATION REQUIREMENTS CONTAINED HEREIN PROVIDED THAT THEY ARE ESCORTED INTO, THROUGH, AND OUT OF THE AOA BY A PROPERLY IDENTIFIED VEHICLE.
ND NG EN FIC LS FT ER LL AY FT DD ED	E	RADIO COMMUNICATIONS RADIO COMMUNICATIONS MAY BE REQUIRED BETWEEN THE CONTRACTOR'S REPRESENTATIVE AND THE AIR TRAFFIC CONTROL TOWER (ATCT). RADIO CONTACT IS REQUIRED AT ALL TIMES WHILE THE CONTRACTOR HAS PERSONNEL AND EQUIPMENT ON THE PROJECT SITE AND WHILE THEY ARE IN AN ACTIVE AIRFIELD OPERATIONS AREA (AOA) OF THE AIRPORT. RADIOS SHALL BE FURNISHED BY THE CONTRACTOR AND SHALL BE CAPABLE OF TRANSMITTING AND RECEIVING AT A GROUND CONTROL FREQUENCY OF 120.8 MHZ. THIS FREQUENCY IS TO BE UTILIZED WHEN CROSSING ACTIVE FACILITIES. SUFFICIENT RADIOS SHALL BE ON SITE AND OPERATING AT ALL TIMES SO THAT INSTRUCTIONS OR COMMUNICATIONS MAY BE DISPATCHED TO ALL CREWS AND/OR EQUIPMENT WORKING IN AN ACTIVE AOA IMMEDIATELY AFTER RECEIPT FROM THE ATCT. HAGERSTOWN REGIONAL AIRPORT IS SERVED BY PART-TIME ATCT. DURING CERTAIN PHASES OF CONSTRUCTION, THE ATCT MAY BE CLOSED. DURING THOSE PERIODS WHEN THE ATCT IS CLOSED, THE CONTRACTOR SHALL MAINTAIN CONTACT WITH AIRCRAFT USING THE AIRPORT BY MONITORING THE CTAF FREQUENCY OF 120.3 MHZ AND UNICOM FREQUENCY OF 122.95 MHZ.

TAXIWAY C OFA REHABILITATION

FAA AIG No .: 3-24-0019-070-2024 (DESIGN/CONSTRUCTION) Bid No.: PUR-1674

GENERAL CONSTRUCTION AND SAFETY NOTES 1

N.A.

DATE:

APRIL 2024

3 OF 18

G200

SHEET NO .:

F DEBRIS

DEBRIS, WASTE, AND LOOSE MATERIAL (INCLUDING DUST AND DIRT) CAPABLE OF CAUSING DAMAGE TO AIRCRAFT LANDING GEAR OR PROPELLERS, OR BEING INGESTED IN JET ENGINES, SHALL NOT BE ALLOWED ON ACTIVE AIRCRAFT MOVEMENT AREAS OR ADJACENT GRASSED AREAS. MATERIALS OBSERVED TO BE WITHIN THESE AREAS SHALL BE REMOVED IMMEDIATELY AND/OR CONTINUOUSLY BY THE CONTRACTOR. THE CONTRACTOR SHALL HAVE A SWEEPING MACHINE AND OPERATOR ON SITE AND READY AT ALL TIMES DURING CONSTRUCTION ACTIVITY WHERE TRAVEL ON OR ACROSS RUNWAYS, RAMP AREAS, TAXIWAYS, OR AIRCRAFT APRONS IS REQUIRED THE CONTRACTOR SHALL PROVIDE ADEQUATE PERSONNEL AND EQUIPMENT TO KEEP SUCH SURFACES CLEAR OF DEBRIS. THE CONTRACTOR SHALL ALSO MAINTAIN A WATER TRUCK ON SITE FOR DUST CONTROL PURPOSES.

G FLAGMEN

IN ACCORDANCE WITH THE PLANS AND SPECIFICATIONS. THE CONTRACTOR SHALL, AT HIS OWN EXPENSE, FURNISH FLAGMEN AS NECESSARY TO CONTROL HIS TRAFFIC (UNLESS OTHERWISE DIRECTED BY THE RPR)

ALL CONTRACTOR VEHICLES THAT ARE REQUIRED TO CROSS ACTIVE RUNWAYS, TAXIWAYS AND APRONS SHALL DO SO UNDER THE DIRECT CONTROL OF A COMPETENT FLAGMAN WHO IS IN DIRECT RADIO CONTACT WITH GROUND CONTROL. ALL AIRCRAFT TRAFFIC ON RUNWAYS, TAXIWAYS, AND APRONS SHALL HAVE PRIORITY OVER CONTRACTOR'S TRAFFIC. AT NO TIME SHALL THE CONTRACTOR'S VEHICLES OR PERSONNEL BE ALLOWED TO ENTER OR CROSS ACTIVE RUNWAYS, TAXIWAYS, SAFETY AREAS, OBJECT FREE AREAS, OR RUNWAY PROTECTION ZONES WITHOUT PROPER AUTHORIZATION OBTAINED THROUGH GROUND CONTROL.

- H MISCELLANEOUS
 - OPEN FLAME, WELDING OR TORCH CUTTING OPERATIONS ARE PROHIBITED UNLESS ADEQUATE FIRE AND SAFETY PRECAUTIONS HAVE BEEN TAKEN AND THE PROCEDURE PREVIOUSLY APPROVED BY THE RPR
 - EQUIPMENT AND STOCKPILED MATERIAL SHALL BE CONSTRAINED IN A MANNER TO PREVENT MOVEMENT RESULTING FROM AIRCRAFT JET BLAST OR WIND CONDITIONS IN EXCESS OF 10 KNOTS.
 - THE CONTRACTOR SHALL PROVIDE POLYETHYLENE CONSTRUCTION BARRIERS WITH FLASHING RED LIGHTS AS SHOWN ON THE DRAWINGS TO DELINEATE THE WORK AREAS WHEN CLOSED TO AIRPORT TRAFFIC. OPEN TRENCHES, EXCAVATIONS AND STOCKPILED MATERIAL LOCATED IN THE AOA SHALL BE PROMINENTLY MARKED WITH ORANGE FLAGS AND LIGHTED BY APPROVED LIGHT UNITS DURING HOURS OF LIMITED VISIBILITY AND DARKNESS.
 - ALL MATERIALS AND EQUIPMENT WHEN NOT IN USE SHALL BE PLACED IN APPROVED AREAS WHERE THEY WILL NOT CONSTITUTE A HAZARD TO AIRCRAFT OPERATIONS AND NOT PENETRATE CLEARANCE SURFACES DEFINED PREVIOUSLY AND SHOWN ON THE CONSTRUCTION SAFETY AND PHASING NOTES AND DETAILS SHEET. EQUIPMENT SHALL BE PARKED AT THE STAGING AREA WHEN NOT IN USE.
 - 5. UPON COMPLETION OF ANY STAGE/PHASE OF WORK. THE RPR WILL ARRANGE A PHYSICAL INSPECTION OF THE AREA WITH AIRPORT OPERATIONS PERSONNEL PRIOR TO OPENING ANY PORTION OR WHOLE RUNWAY. TAXIWAY, OR RAMP AREA THAT HAS BEEN CLOSED FOR WORK OR USED FOR A CROSSING POINT OR HAUL ROUTE BY THE CONTRACTOR.
 - ENTRANCE TO THE AIRFIELD IS SUBJECT TO STRICT SECURITY REGULATIONS. ALL PERSONNEL ENTERING THE AIRFIELD MAY BE SUBJECT TO A BACKGROUND CHECK. THE CONTRACTOR SHALL BE RESPONSIBLE FOR ASSURING THAT ALL OF HIS EMPLOYEES WHO NEED TO HAVE ACCESS TO THE AIRFIELD, HAVE INFORMATION AVAILABLE FOR A BACKGROUND CHECK TO BE PERFORMED, DATING BACK TEN (10) YEARS VERIFYING REPRESENTATIONS MADE BY THE EMPLOYEE RELATING TO EMPLOYMENT.
 - THE CONTRACTOR SHALL PROVIDE THE RPR AND AIRPORT DIRECTOR A CURRENT LIST OF ALL EMPLOYEES WORKING ON THE AIRPORT. THE LIST SHALL BE MAINTAINED CURRENT BY THE CONTRACTOR AND APPLIES TO BOTH THE CONTRACTOR AND SUBCONTRACTORS.
 - THE CONTRACTOR SHALL FAMILIARIZE HIS PERSONNEL WITH CLEARANCES NEEDED TO PROVIDE FOR THE SAFE OPERATION OF RUNWAYS AND TAXIWAYS AS SHOWN IN THE PLANS.
 - EXCEPT FOR EMERGENCIES, ALL CONTACT WITH AIRPORT PERSONNEL SHALL BE MADE THROUGH THE FOR EMERGENCIES INVOLVING SAFETY RPR. (INJURIES, FIRES, SECURITY BREACHES, ETC.) THE CONTRACTOR SHALL MAKE DIRECT CONTACT WITH AIRPORT OPERATIONS MANAGER FOLLOWED BY NOTIFICATION TO THE RPR AS SOON AS POSSIBLE.

- 10. THE CONTRACTOR SHALL PROVIDE THE PHONE NUMBERS OF THREE PERSONNEL, INCLUDING THE PROJECT SUPERINTENDENT, WHO MAY BE CONTACTED IN AN EMERGENCY. PERSONNEL SHALL BE ON CALL 24 HOURS PER DAY FOR MAINTAINING AIRPORT HAZARD LIGHTING AND BARRICADES.
- 11. IN ACCORDANCE WITH THE SPECIFICATIONS, FEDERAL WAGE RATES SHALL BE POSTED OUTSIDE THE SITE FIELD OFFICE(S) IN A WEATHERPROOF ENCLOSURE.
- UTILITIES
- 1. UNDERGROUND UTILITIES: THE LOCATIONS OF THE UNDERGROUND UTILITIES SHOWN ON THE PLANS ARE CONSIDERED TO BE ONLY APPROXIMATE LOCATIONS. ALL UTILITY LOCATIONS SHALL BE FIELD VERIFIED BY CONTRACTOR PRIOR TO COMMENCING CONSTRUCTION. IN THE EVENT ANY UTILITY IS DAMAGED, THE CONTRACTOR SHALL BE RESPONSIBLE FOR PAYING FOR INCURRED COSTS OF REPAIRS.
- 2. THE CONTRACTOR SHALL ALSO NOTIFY "MISS UTILITY" AT 1-800-257-7777. THE COST ASSOCIATED WITH CONTACTING MISS UTILITY SHALL BE BORNE BY THE CONTRACTOR. ANY COSTS ASSOCIATED WITH DAMAGE TO UTILITIES SHALL BE BORNE BY THE CONTRACTOR.
- UTILITIES NOTIFICATION: AT LEAST TWO WORKING DAYS PRIOR TO COMMENCING CONSTRUCTION OPERATIONS IN AN AREA WHICH MAY INVOLVE UNDERGROUND UTILITY FACILITIES, THE CONTRACTOR SHALL NOTIFY THE RPR AND THE OWNER OF EACH UNDERGROUND UTILITY FACILITY AFFECTED.

SECURITY


- 1. IT IS THE CONTRACTOR'S RESPONSIBILITY TO FAMILIARIZE HIMSELF/HERSELF WITH THE VARIOUS ASPECTS OF TRANSPORTATION SECURITY ADMINISTRATION (TSA) SECTION 1542 "AIRPORT SECURITY". ANY VIOLATION OF TSA SECTION 1542 BY THE CONTRACTOR AND ANY SUBSEQUENT FINES IMPOSED DUE TO THE VIOLATION WILL BE THE RESPONSIBILITY OF THE CONTRACTOR.
- 2. ALL VEHICLES TO BE USED ON THE AIRPORT SHALL BE REGISTERED WITH THE AIRPORT OPERATIONS MANAGER. REGISTRATION CONSISTS OF LICENSE PLATE NUMBER AND OWNER. IT IS THE CONTRACTOR'S RESPONSIBILITY TO ENSURE THAT VEHICLES ARE REGISTERED IN A TIMELY MANNER SO AS NOT TO DELAY THE PROJECT. VISITING VEHICLES ARE EXEMPT FROM THE REGISTRATION REQUIREMENTS SO LONG AS THEY ARE ESCORTED BY A REGISTERED VEHICLE AT ALL TIMES WHEN ON THE AOA.
- 3. THE AIRPORT WILL NOT PROVIDE AIRFIELD OPERATIONS AREA ESCORTS. THE CONTRACTOR MUST PROVIDE HIS OWN RADIO, ACQUAINT HIMSELF AND ANY OTHER PERSONNEL THAT ARE ANTICIPATED TO USE THE RADIO WITH THE PROPER PROCEDURES IN COMMUNICATING WITH GROUND CONTROL (FREQUENCY 121.9 MHZ). THE CONTRACTOR WILL NEED TO ATTEND SECURITY/GROUND VEHICLE OPS TRAINING.
- 4. THE PROJECT SUPERVISORS SHALL HAVE WITH THEM AT ALL TIMES THE TELEPHONE NUMBERS FOR THE FOLLOWING PERSONS. IN THE EVENT OF AN EMERGENCY THESE PERSONNEL SHOULD BE CONTACTED IN DESCENDING ORDER:

MR. NEIL DORAN, AIRPORT DIRECTOR

MR. TERRY STOUFFER, AIRPORT MAINTENANCE SUPERVISOR

MR. GENE BOLANOWSKI, OPERATIONS MANAGER MR DANNY SHIRLEY, AIRPORT FIRE CHIEF

TELEPHONE NUMBERS WILL BE PROVIDED TO THE CONTRACTOR AT THE PRE-CONSTRUCTION MEETING. ADDITIONAL CONTACTS MAY BE PROVIDED TO THE CONTRACTOR AT THAT TIME.

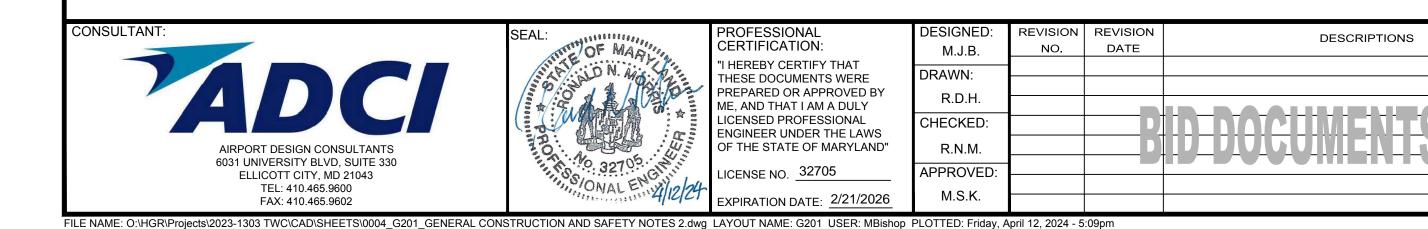

5.

DESCRIPTIONS

WHEN CONSTRUCTION ACTIVITY IS CONDUCTED IN THE AOA. KEY PROJECT SITE SUPERVISORY PERSONNEL OF THE CONTRACTOR AND ITS SUBCONTRACTORS (INCLUDING CONSTRUCTION GATE GUARD PERSONNEL) SHALL BE ISSUED AIRPORT IDENTIFICATION (ID) BADGES. ALL INDIVIDUALS WHO RECEIVE AN AIRPORT BADGE ARE REQUIRED TO ATTEND A SECURITY TRAINING CLASS PROVIDED BY THE AIRPORT. IT IS THE CONTRACTOR'S RESPONSIBILITY TO OBTAIN APPLICATIONS AND MAKE ALL NECESSARY ARRANGEMENTS TO ENABLE ITS PERSONNEL TO OBTAIN ID BADGES. THE CONTRACTOR IS ALSO RESPONSIBLE FOR ENSURING THAT IT HAS SUFFICIENT SUPERVISORY AND CONSTRUCTION GATE PERSONNEL ON THE PROJECT SITE WHENEVER WORK IS OCCURRING TO FULFILL THE RESPONSIBILITIES.

PROJECT SITE SUPERVISORY PERSONNEL ARE SUBJECT TO FEDERAL CRIMINAL RECORDS CHECKS AND MUST PROVIDE EMPLOYMENT VERIFICATION FORMS THAT COVER THE LAST TEN (10) YEARS OF EMPLOYMENT AND EDUCATION. INFORMATION ON THESE FORMS WILL BE VERIFIED BY THE AIRPORT.

APPLICATIONS AND FORMS CAN BE OBTAINED FROM THE AIRPORT BY CALLING MR. GENE BOLANOWSKI, 240-313-2769. ALL APPLICATIONS AND FORMS ARE TO BE SUBMITTED TO THE AIRPORT AT LEAST TWO (2) WEEKS PRIOR TO THE PROJECT START DATE IN ORDER TO ALLOW TIME TO PERFORM THE EMPLOYMENT AND BACKGROUND CHECKS. THERE IS A REFUNDABLE DEPOSIT OF ONE HUNDRED DOLLARS (\$100.00) FOR EACH PHOTO ID BADGE ISSUED. PAYMENT MUST ACCOMPANY THE APPLICATION. APPLICATIONS. ACCESS INVESTIGATION FORMS AND EMPLOYMENT VERIFICATION FORMS MUST BE FILLED OUT COMPLETELY BEFORE AN APPLICATION WILL BE PROCESSED. NON-REFUNDABLE CONTRACTOR BADGE FEES WILL NOT BE RETURNED TO THE CONTRACTOR IF AN APPLICATION CANNOT BE PROCESSED BECAUSE IT IS INCOMPLETE. COST FOR SECURITY SHALL BE INCLUDED IN CONTRACTORS BID PRICE FOR MOBILIZATION/DEMOBILIZATION.

PHOTO ID BADGES MUST BE RETURNED TO THE AIRPORT ID PROCESSING OFFICE NO LATER THAN FIVE (5) DAYS AFTER COMPLETION OF THE CONTRACT TO RECEIVE A REFUND OF THE DEPOSIT AND MUST BE RETURNED BEFORE THE FINAL PAY ESTIMATE WILL BE PROCESSED. IN ADDITION TO THE LOSS OF THE BADGE SECURITY DEPOSIT, HOLDERS OF BADGES WHICH ARE LOST WILL BE ASSESSED A BADGE REPLACEMENT FEE OF FIFTY DOLLARS (\$50.00). THE AIRPORT MUST BE NOTIFIED IMMEDIATELY IF A BADGE IS LOST OR STOLEN OR IF ITS HOLDER TERMINATES EMPLOYMENT OR IS REASSIGNED.

PHOTO ID BADGES SHALL BE DISPLAYED ON THE OUTERMOST GARMENT ABOVE THE WAIST SO THEY CAN BE SEEN BY FAA, POLICE AND OTHER AIRPORT PERSONNEL.



PROJECT TITLE:

SHEET TITLE:

TAXIWAY C OFA REHABILITATION

N.A.

DATE:


APRIL 2024

SHEET NO .: G201

FAA AIG No.: 3-24-0019-070-2024 (DESIGN/CONSTRUCTION) Bid No.: PUR-1674

GENERAL CONSTRUCTION AND SAFETY NOTES 2

4 OF 18

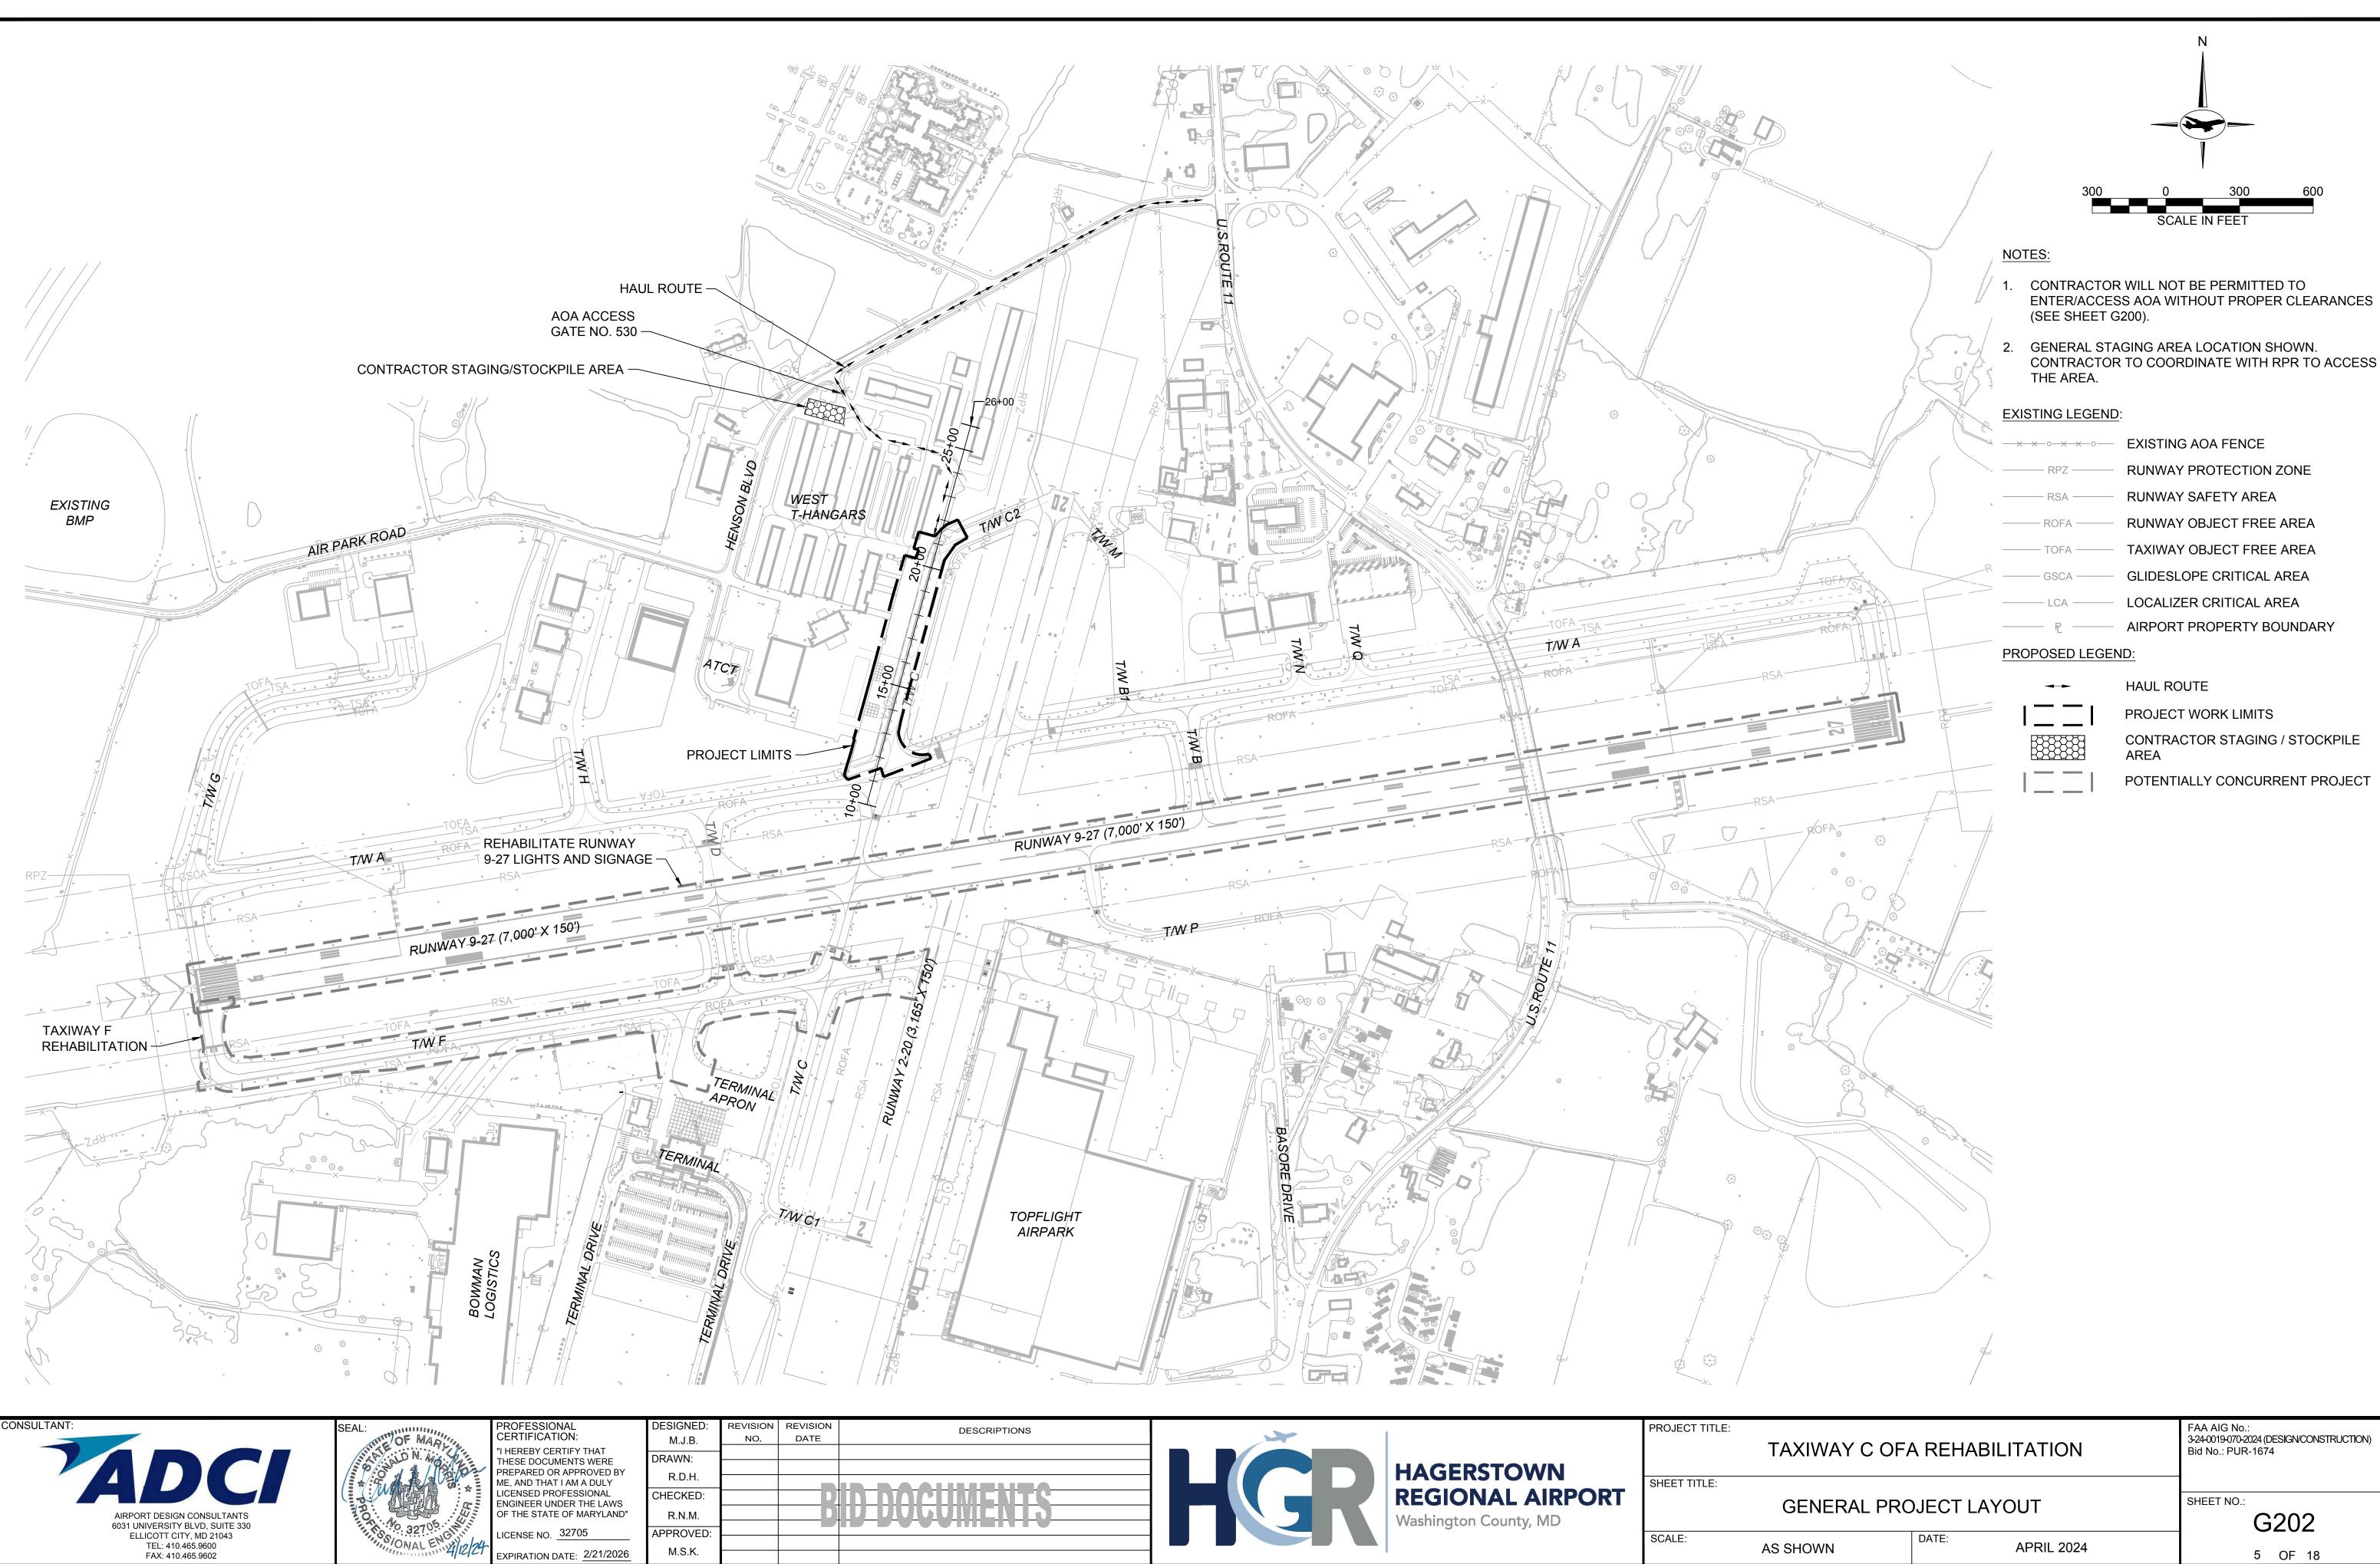


EXPIRATION DATE: 2/21/2026

AS	SH	OWN


APRIL 2024

5 OF 18

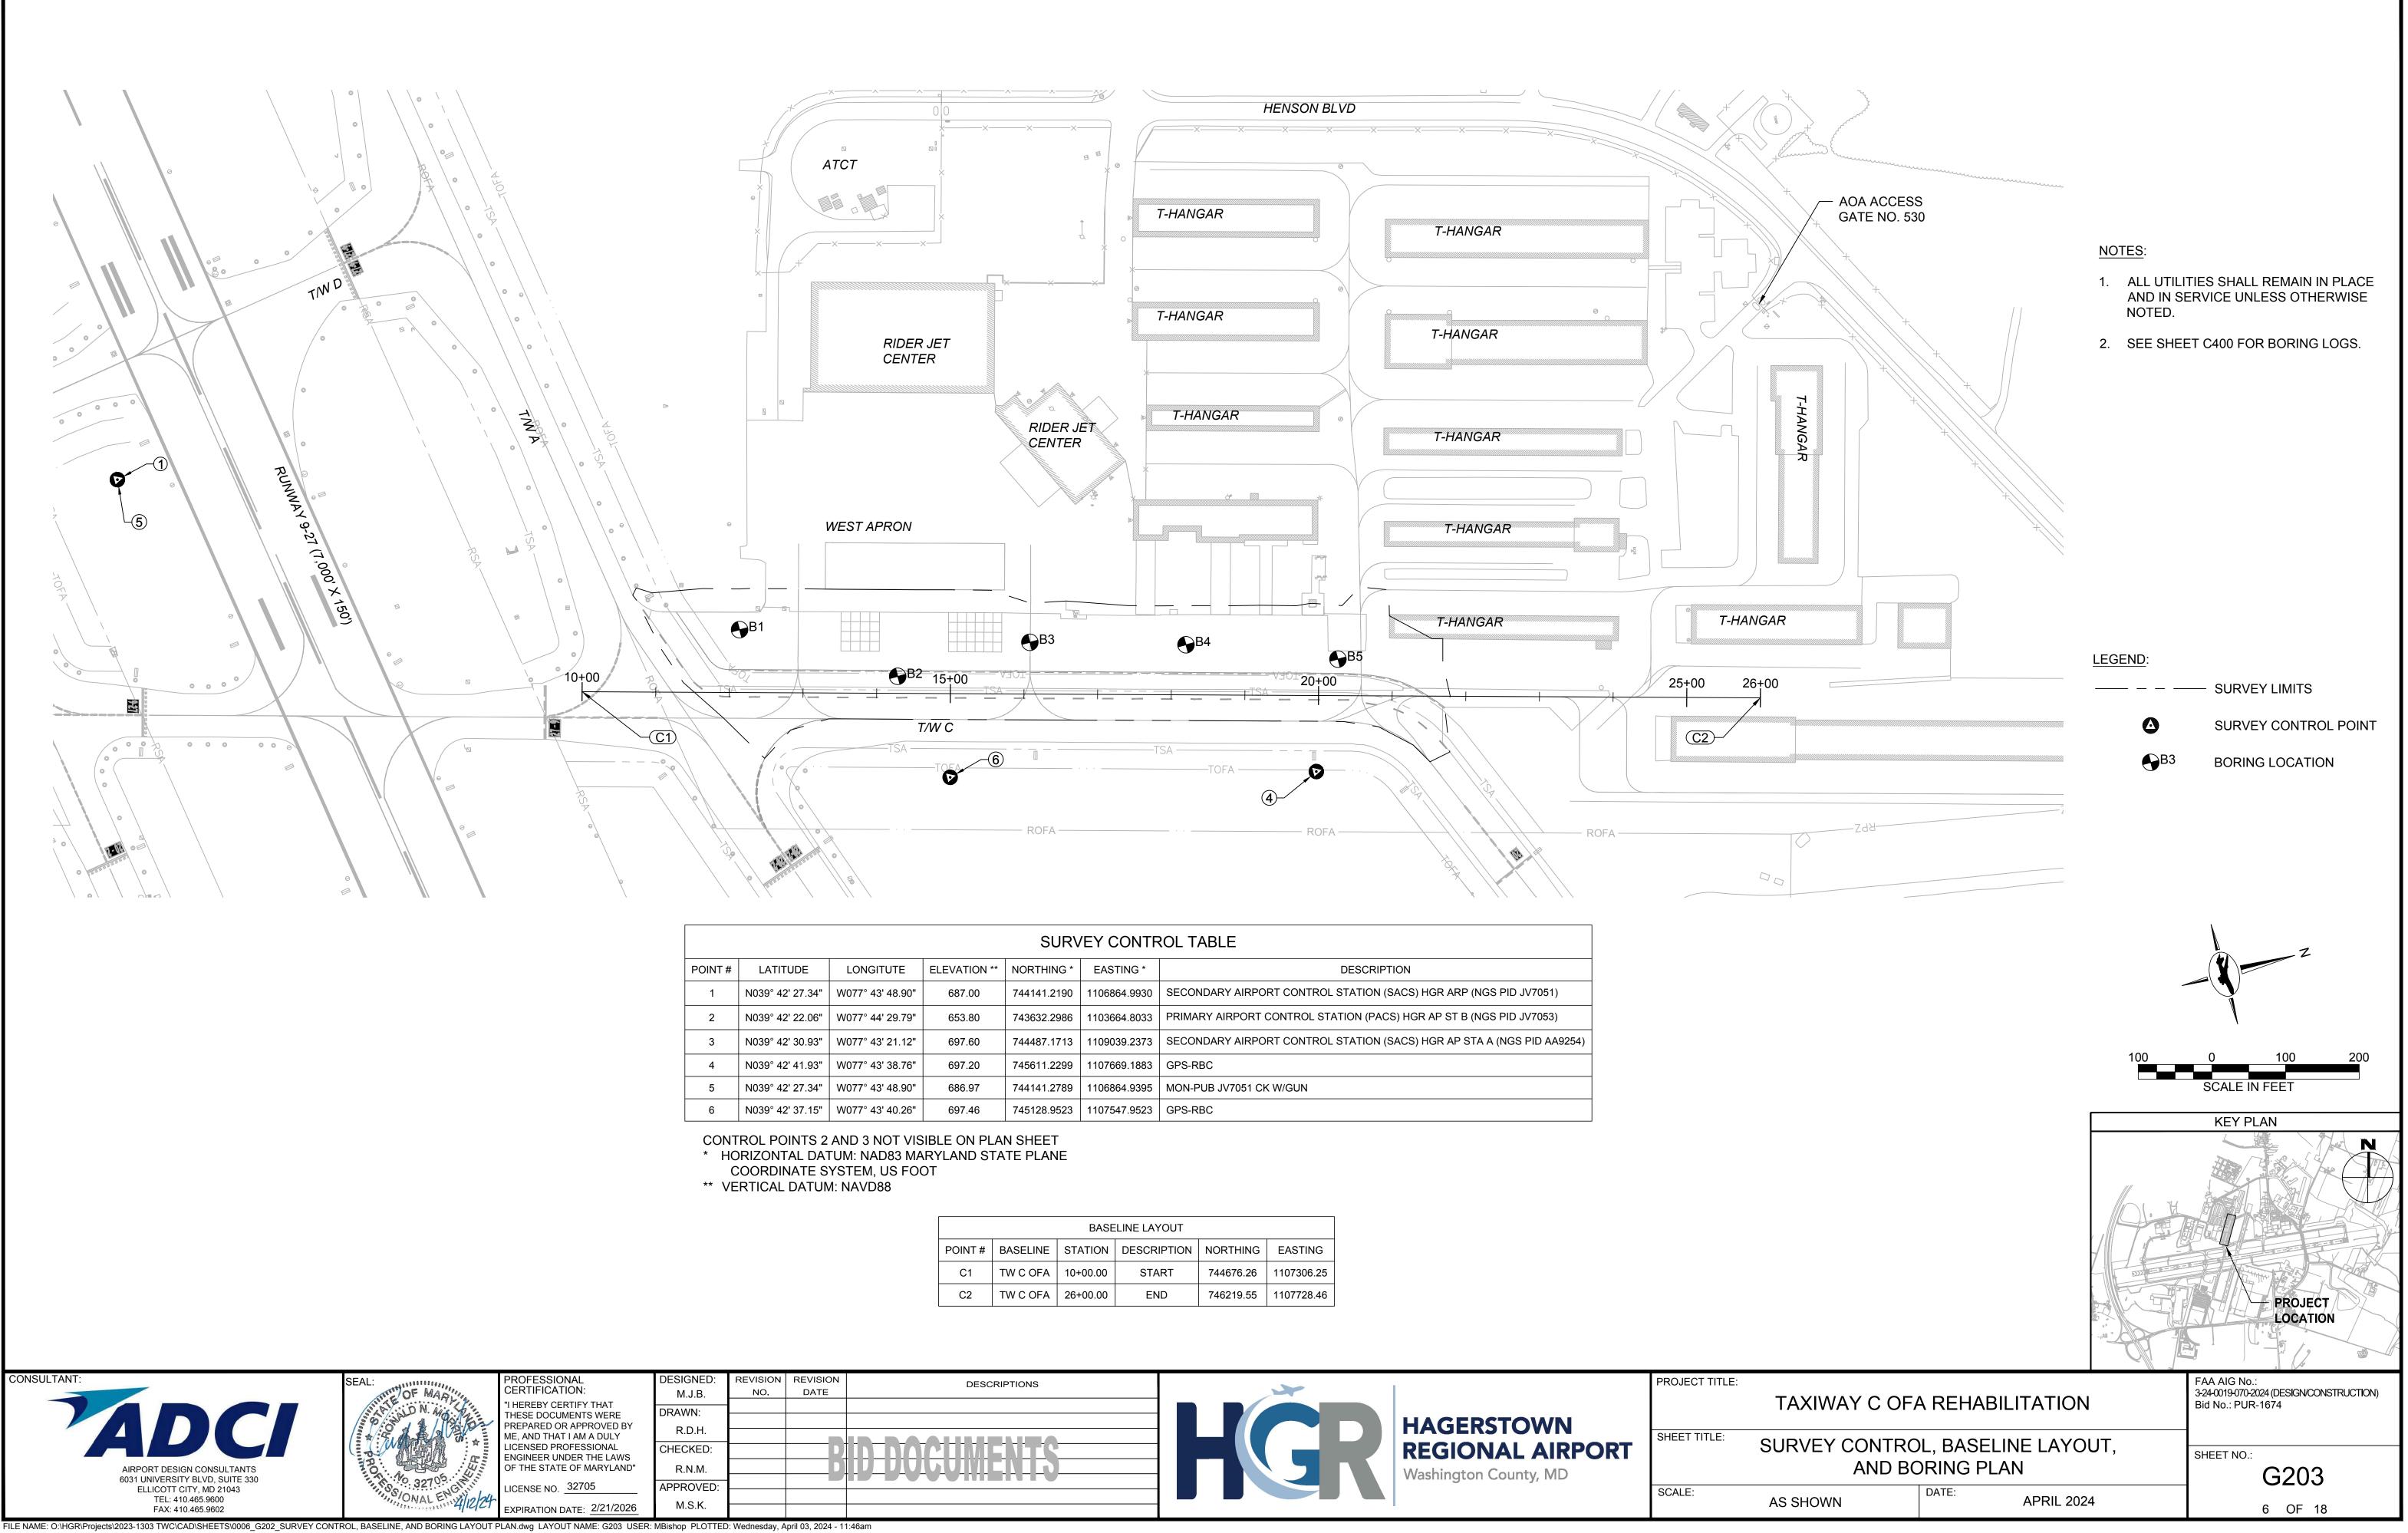


	SURVEY CONTROL TABLE					
LONGITUTE	ELEVATION **	NORTHING *	EASTING *	DESCRIPTION		
077° 43' 48.90"	687.00	744141.2190	1106864.9930	SECONDARY AIRPORT CONTROL STATION (SACS) HGR ARP (NGS PID JV7051)		
077° 44' 29.79"	653.80	743632.2986	1103664.8033	PRIMARY AIRPORT CONTROL STATION (PACS) HGR AP ST B (NGS PID JV7053)		
077° 43' 21.12"	697.60	744487.1713	1109039.2373	SECONDARY AIRPORT CONTROL STATION (SACS) HGR AP STA A (NGS PID AA9254)		
077° 43' 38.76"	697.20	745611.2299	1107669.1883	GPS-RBC		
077° 43' 48.90"	686.97	744141.2789	1106864.9395	MON-PUB JV7051 CK W/GUN		
077° 43' 40.26"	697.46	745128.9523	1107547.9523	GPS-RBC		

POINT #	BASELINE	STATION	DESCRIPTION	NORTHING	EAST
C1	TW C OFA	10+00.00	START	744676.26	110730
C2	TW C OFA	26+00.00	FND	746219 55	110772

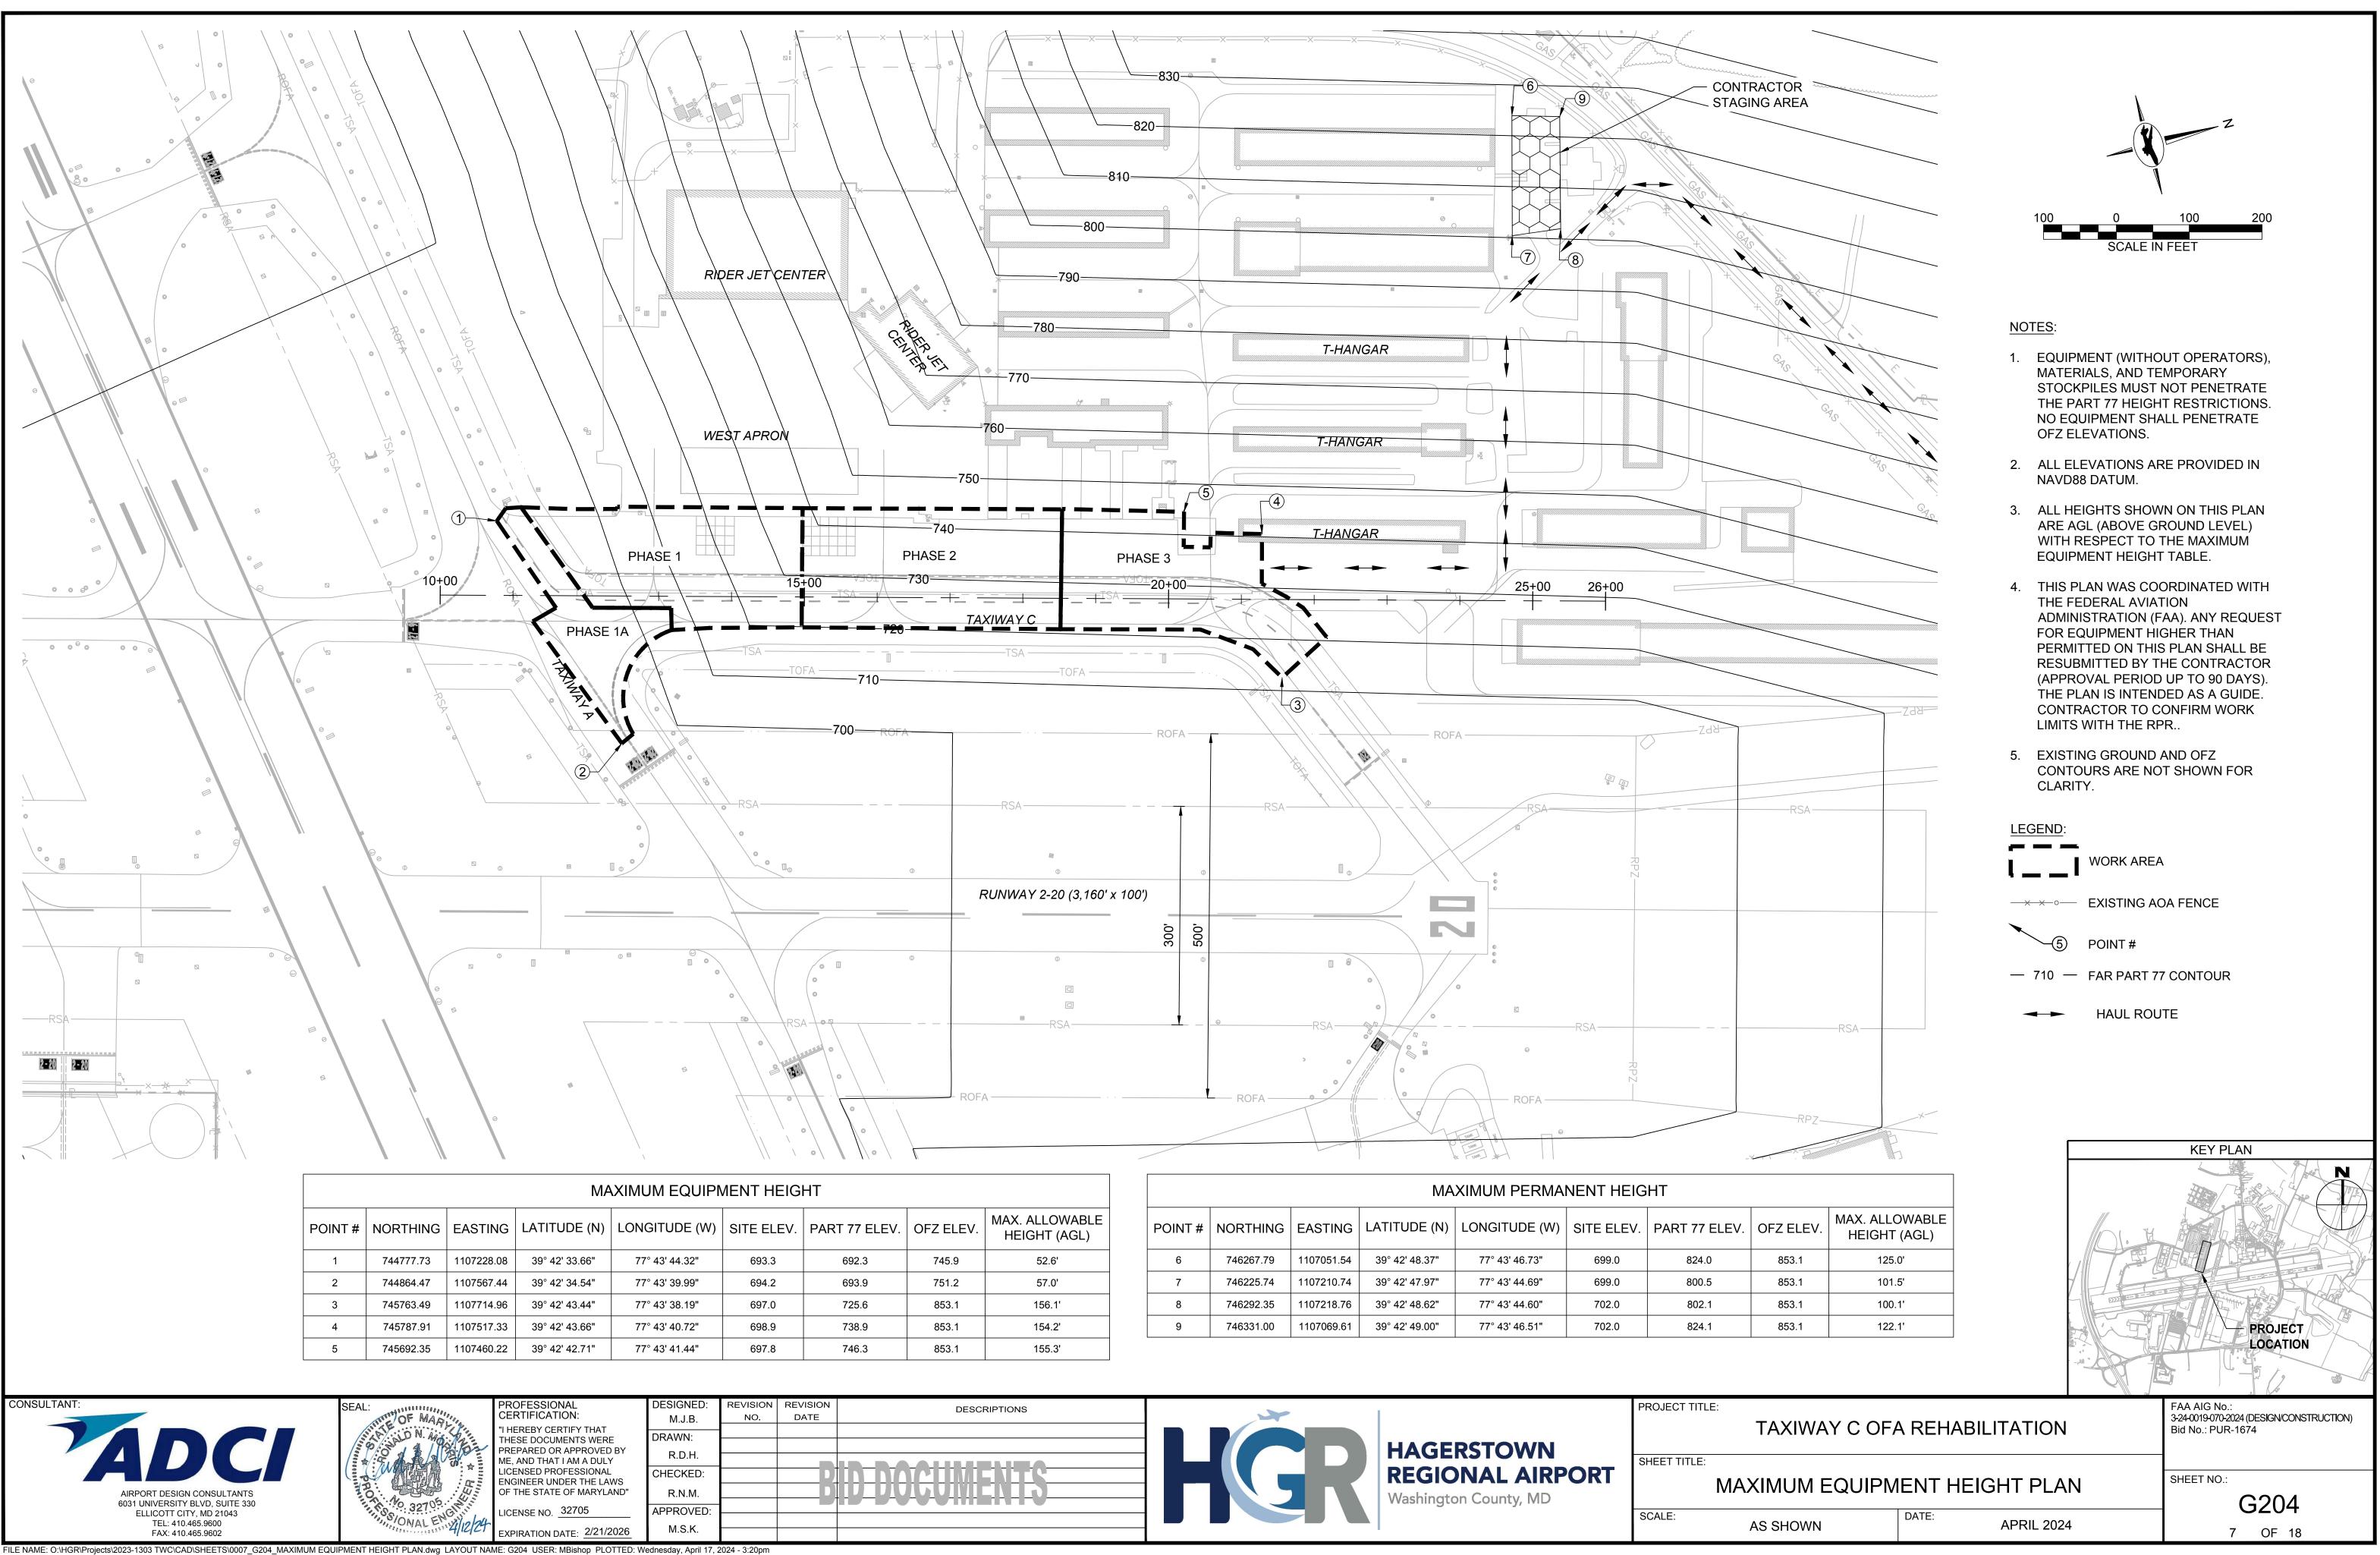


POINT #	NORTHING	EASTING	LATITUDE (N)	LONGITUDE (W)	SITE ELEV.	PART 77 ELEV.	OFZ ELEV.	MAX. ALLOWABLE HEIGHT (AGL)
1	744777.73	1107228.08	39° 42' 33.66"	77° 43' 44.32"	693.3	692.3	745.9	52.6'
2	744864.47	1107567.44	39° 42' 34.54"	77° 43' 39.99"	694.2	693.9	751.2	57.0'
3	745763.49	1107714.96	39° 42' 43.44"	77° 43' 38.19"	697.0	725.6	853.1	156.1'
4	745787.91	1107517.33	39° 42' 43.66"	77° 43' 40.72"	698.9	738.9	853.1	154.2'
5	745692.35	1107460.22	39° 42' 42.71"	77° 43' 41.44"	697.8	746.3	853.1	155.3'




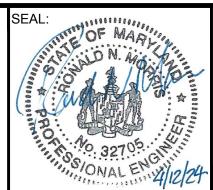


	DESIGNED:	REVISION	REVISION	
	M.J.B.	NO.	DATE	
	DRAWN:			
<i>'</i>	R.D.H.			
	CHECKED:			-
	ONEONED.		K-	
)"	R.N.M.		L	
	APPROVED:			
6	M.S.K.			
ED: We	ednesday, April 17, 2	2024 - 3:20pm		


MAXIMUM PERMANENT HEIGHT							
POINT #	NORTHING	EASTING	LATITUDE (N)	LONGITUDE (W)	SITE ELEV.	PART 77 ELEV.	
6	746267.79	1107051.54	39° 42' 48.37"	77° 43' 46.73"	699.0	824.0	
7	746225.74	1107210.74	39° 42' 47.97"	77° 43' 44.69"	699.0	800.5	
8	746292.35	1107218.76	39° 42' 48.62"	77° 43' 44.60"	702.0	802.1	
9	746331.00	1107069.61	39° 42' 49.00"	77° 43' 46.51"	702.0	824.1	

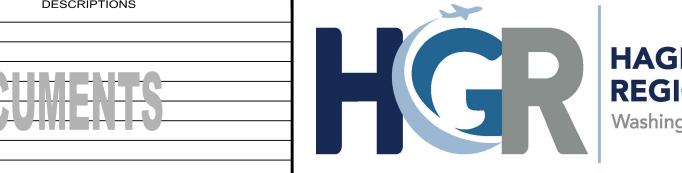


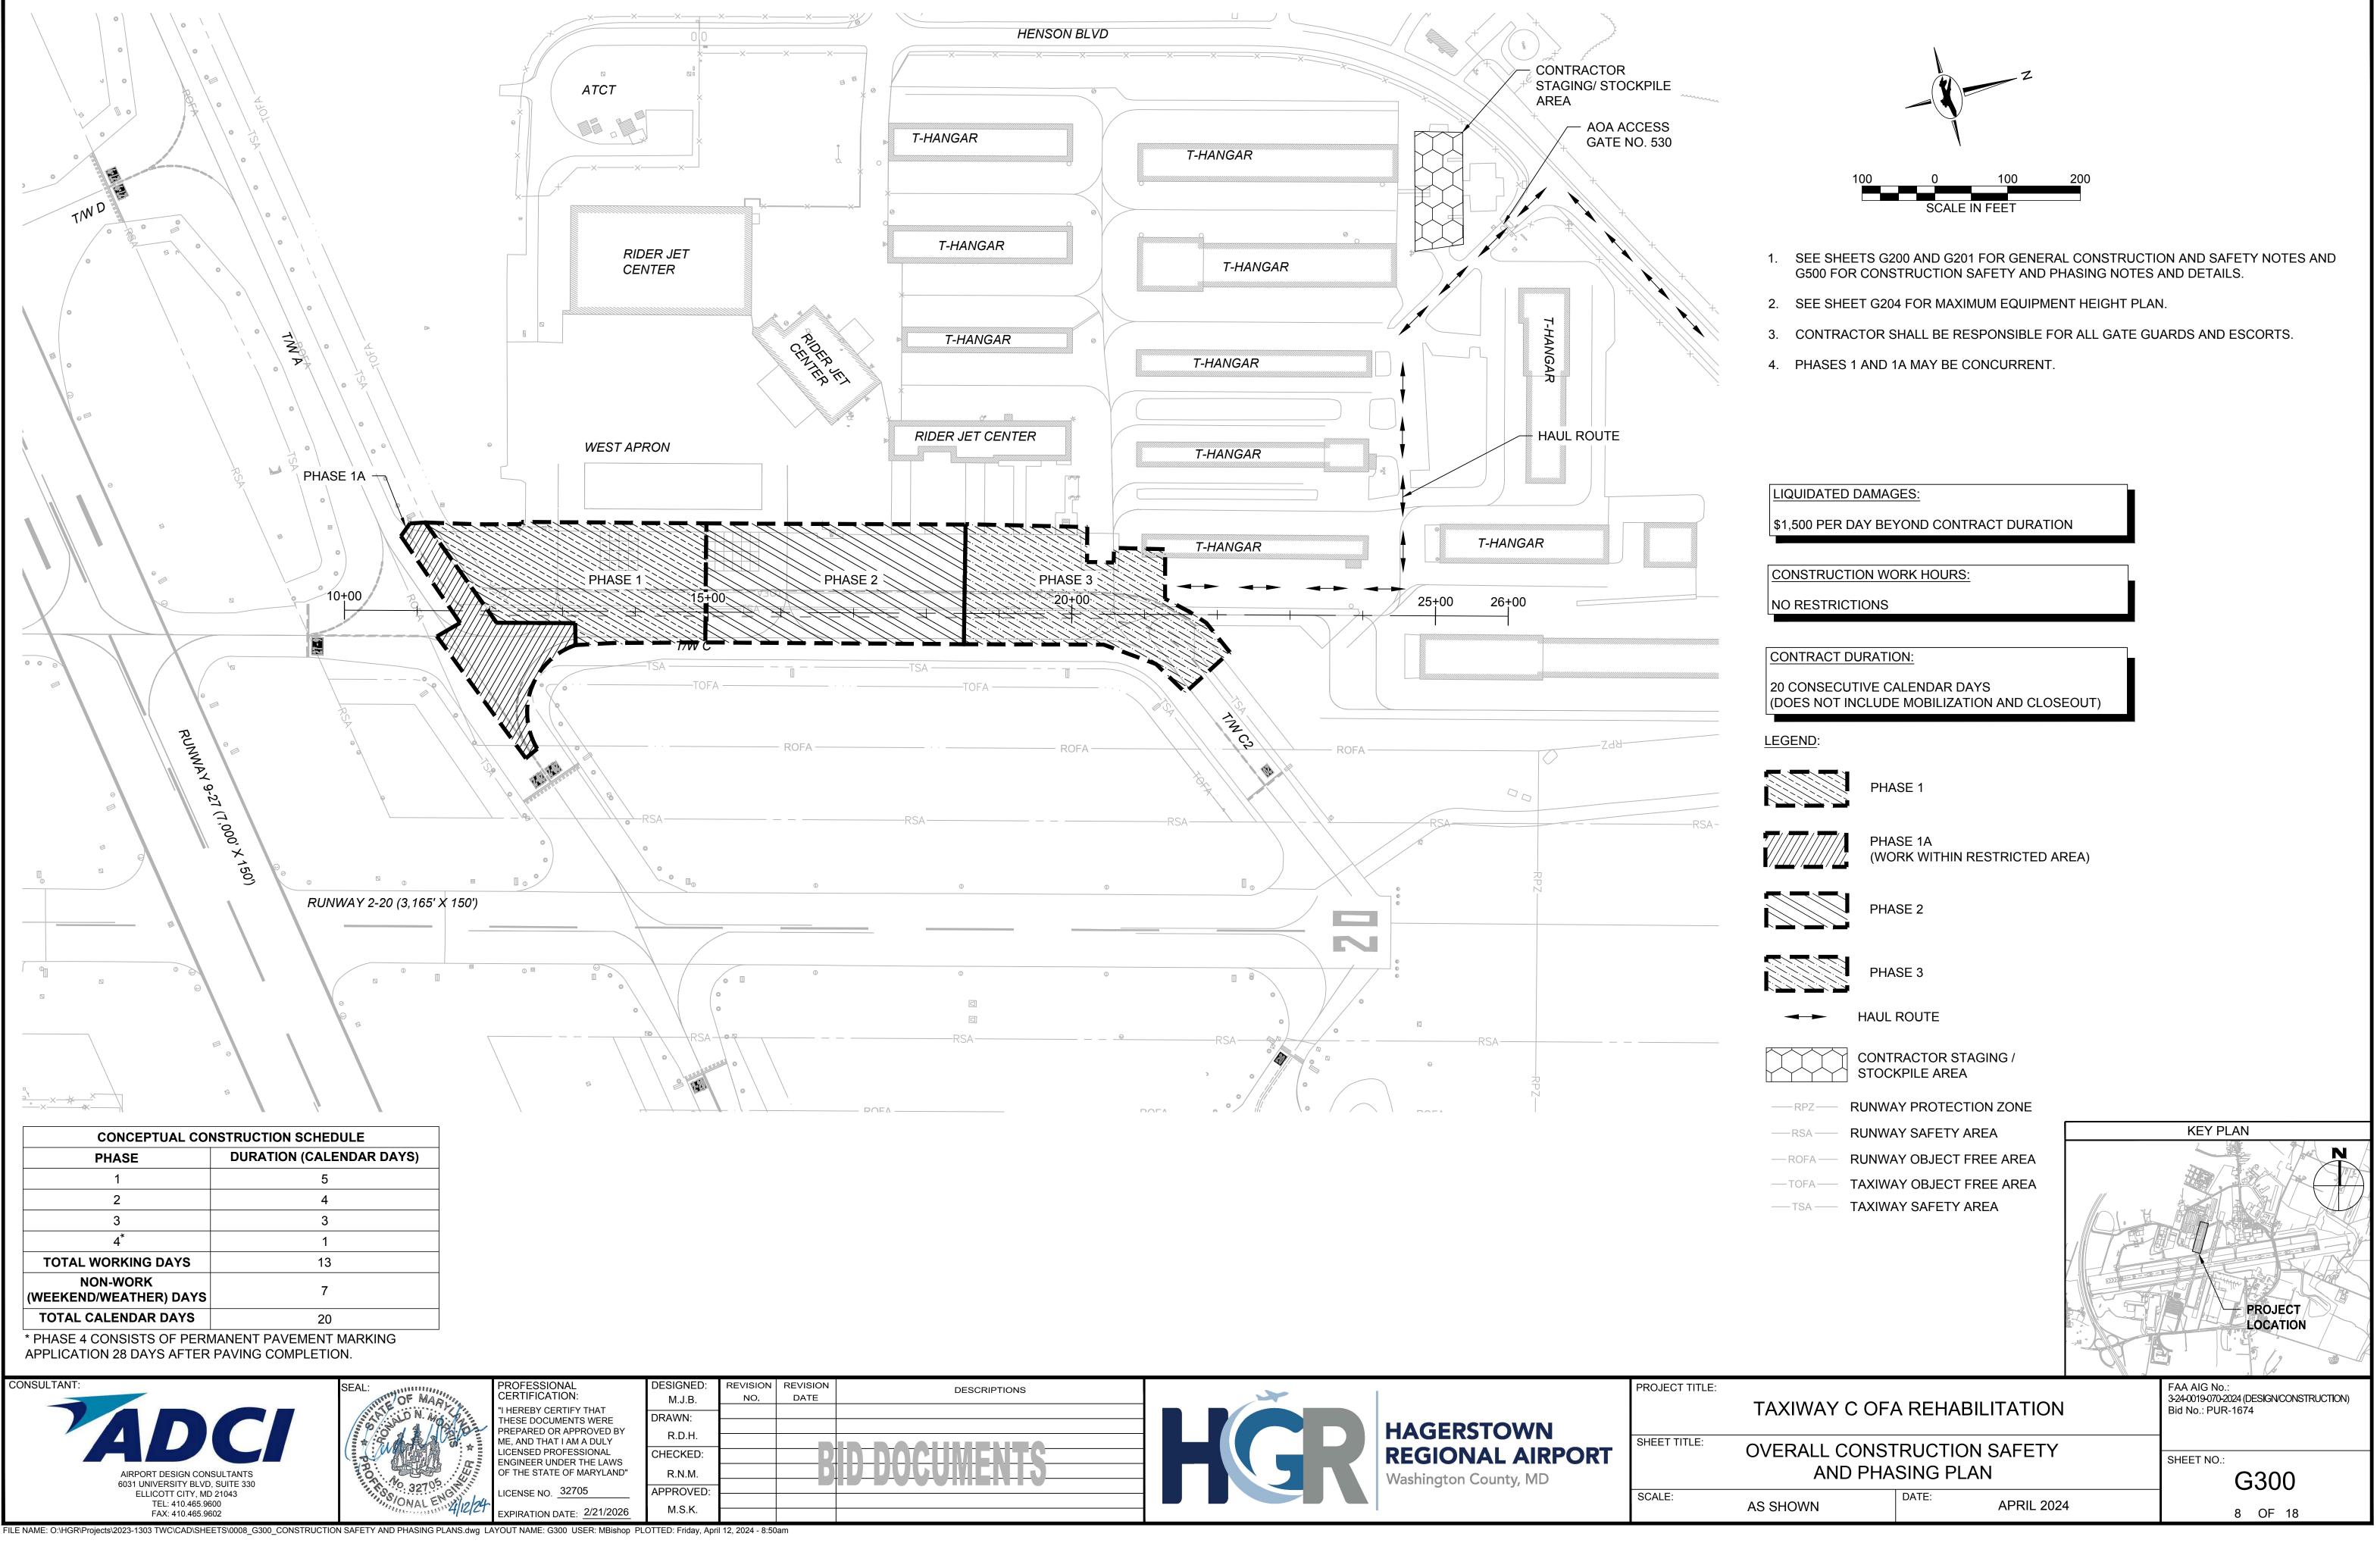


	DESIGNED: M.J.B.	REVISION NO.	REVISION DATE	
	DRAWN:			
	R.D.H.			
	CHECKED:			
	R.N.M.			
_	APPROVED:			
5	M.S.K.			

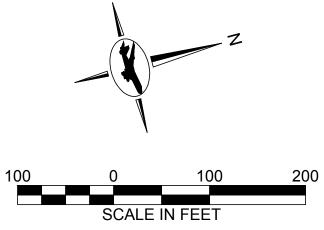

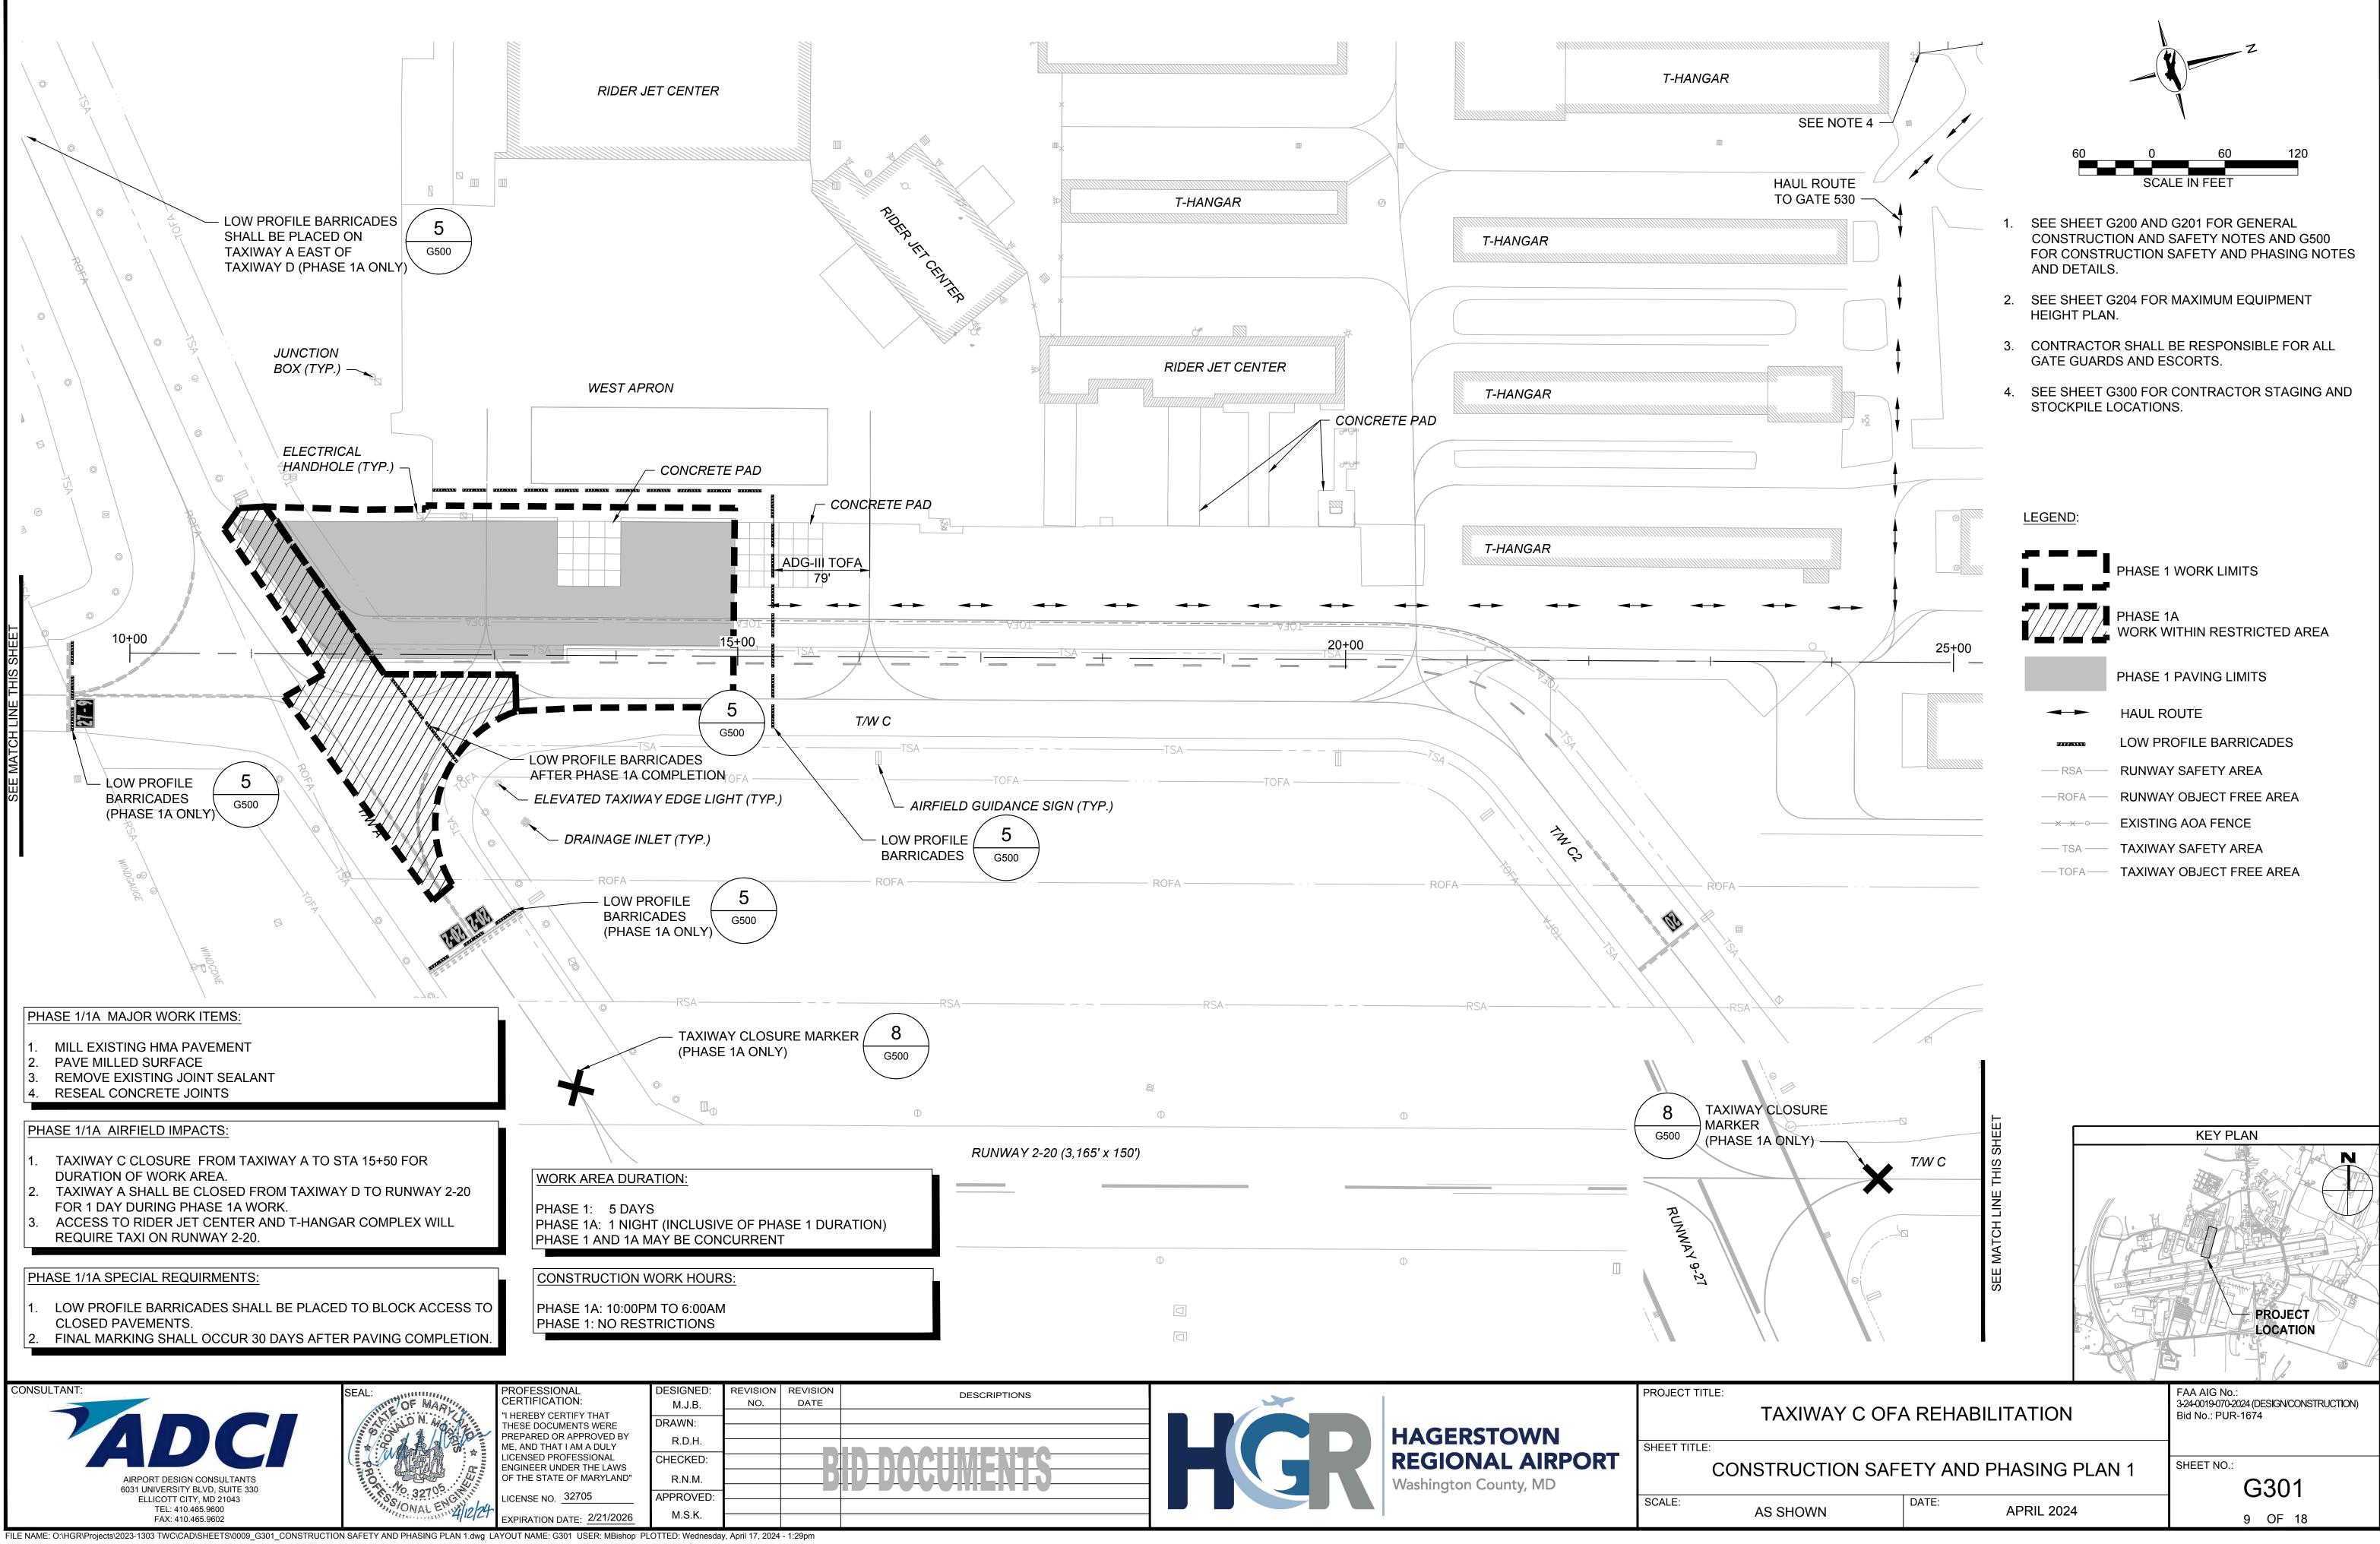

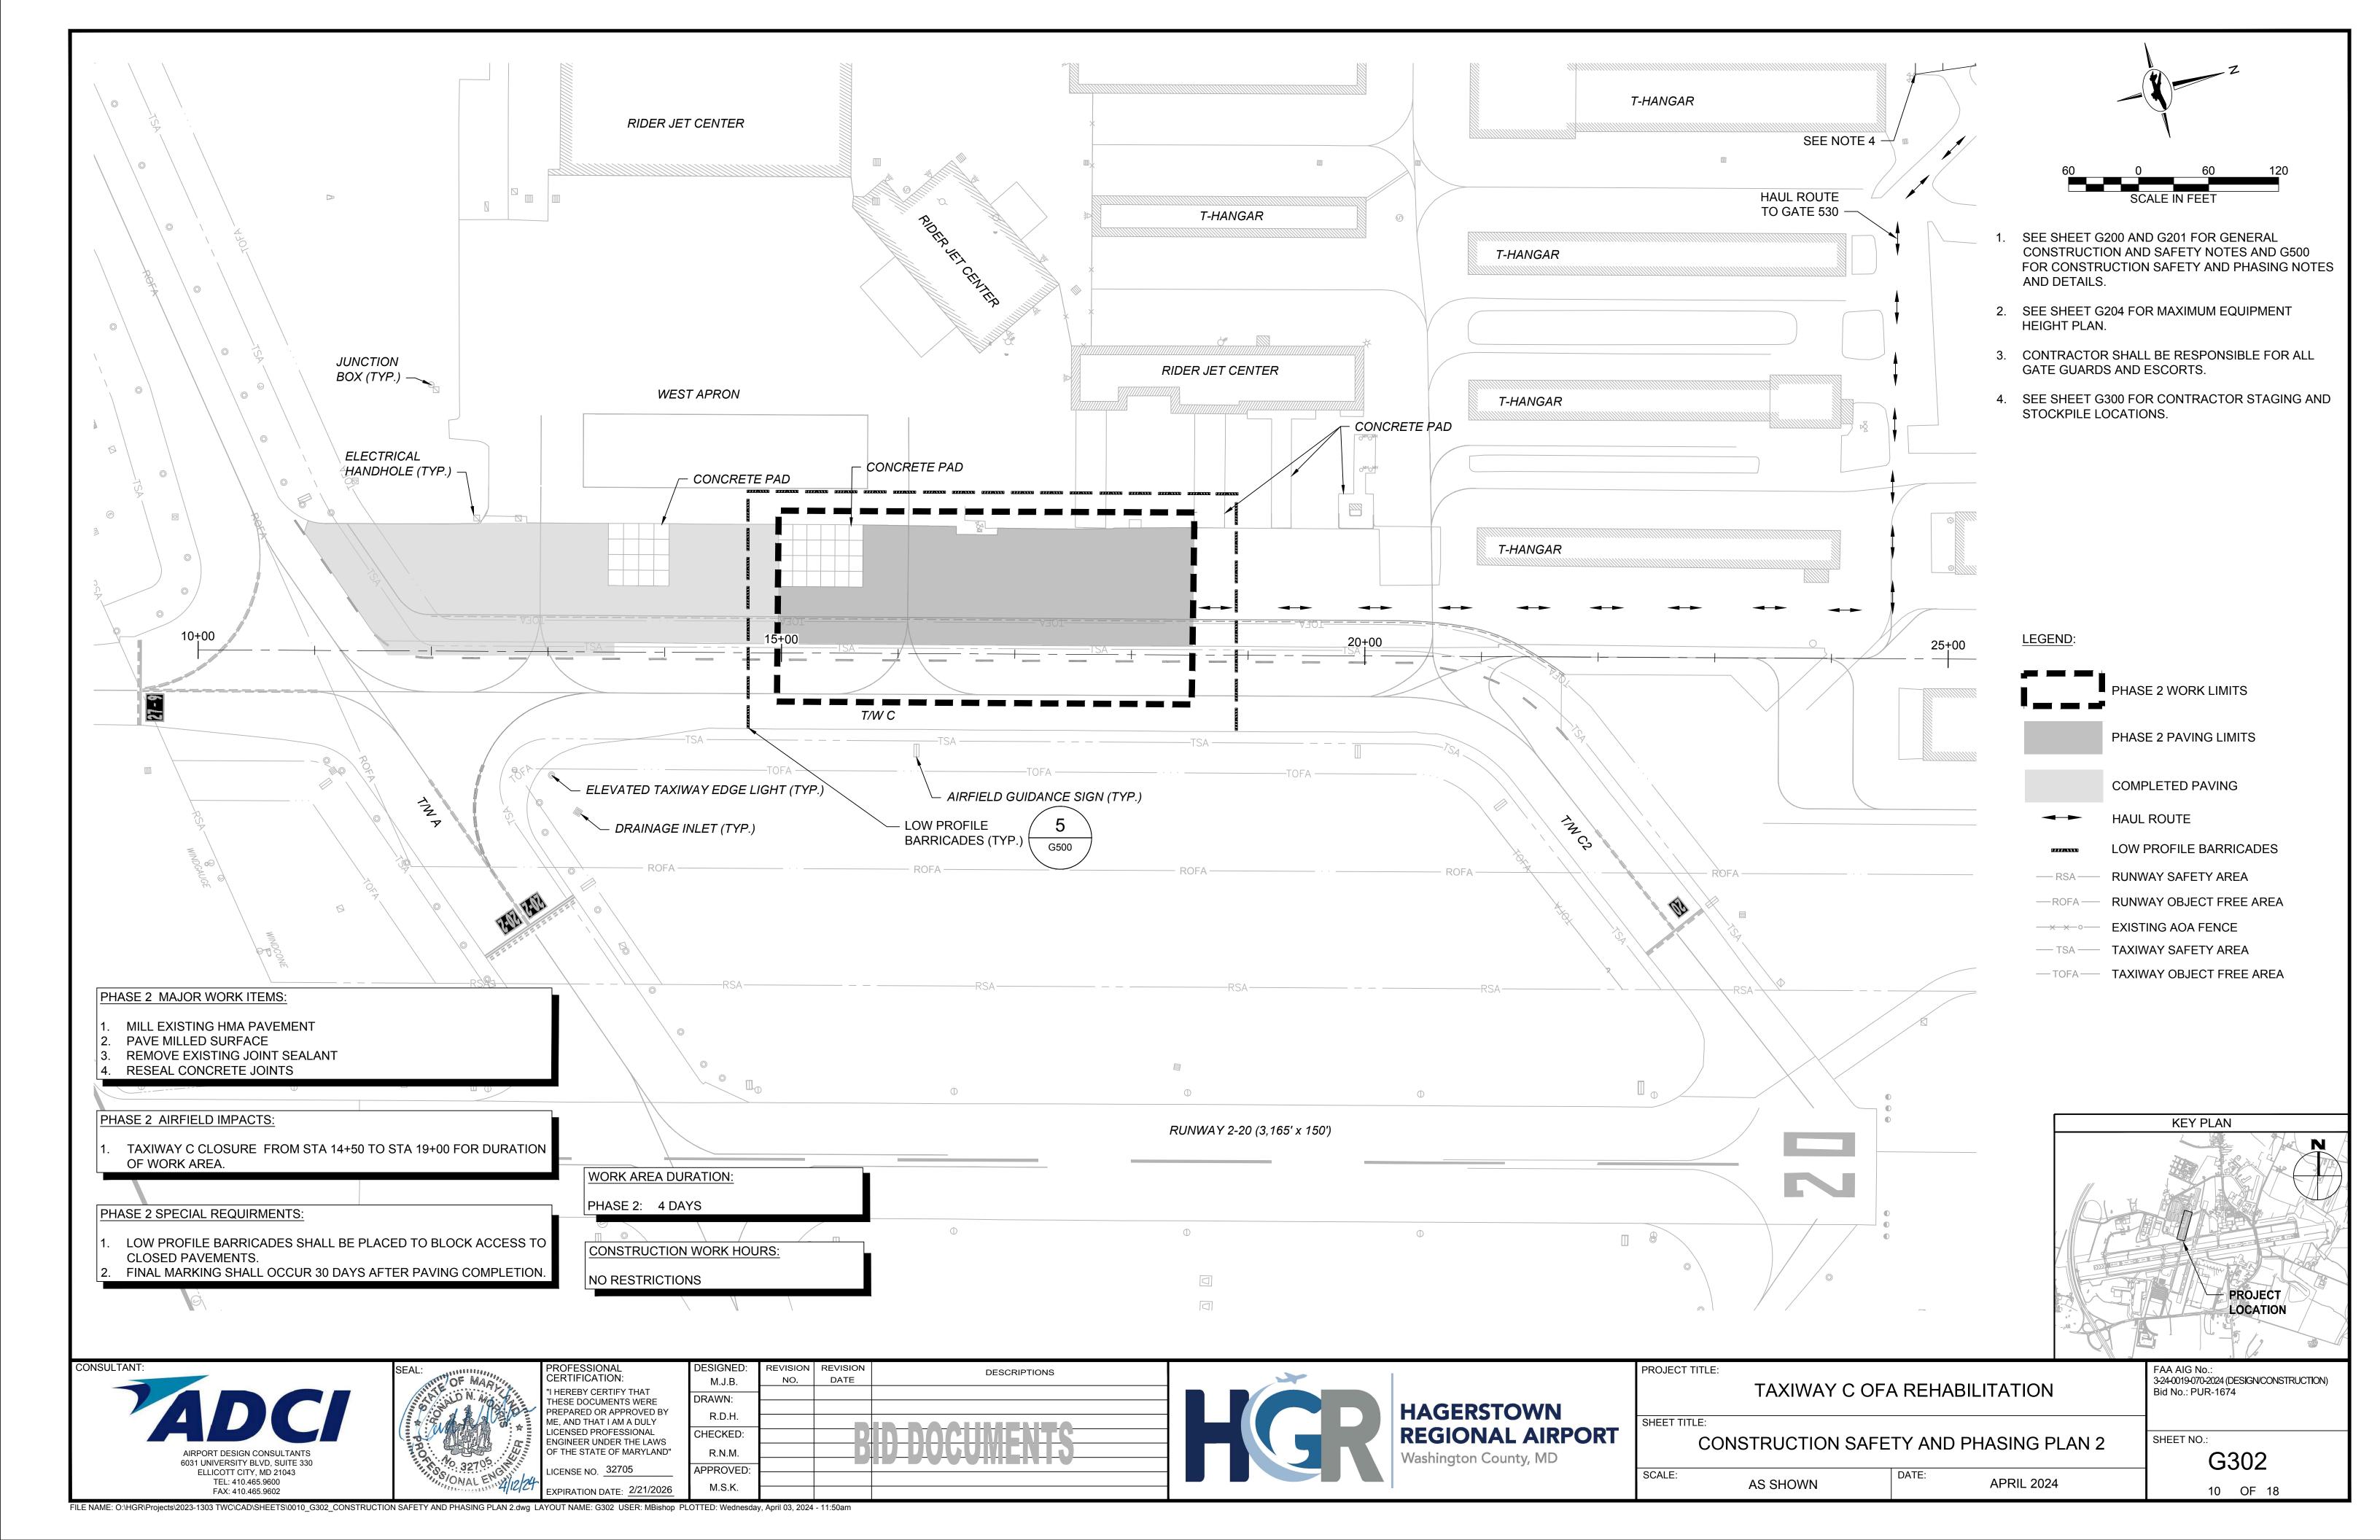

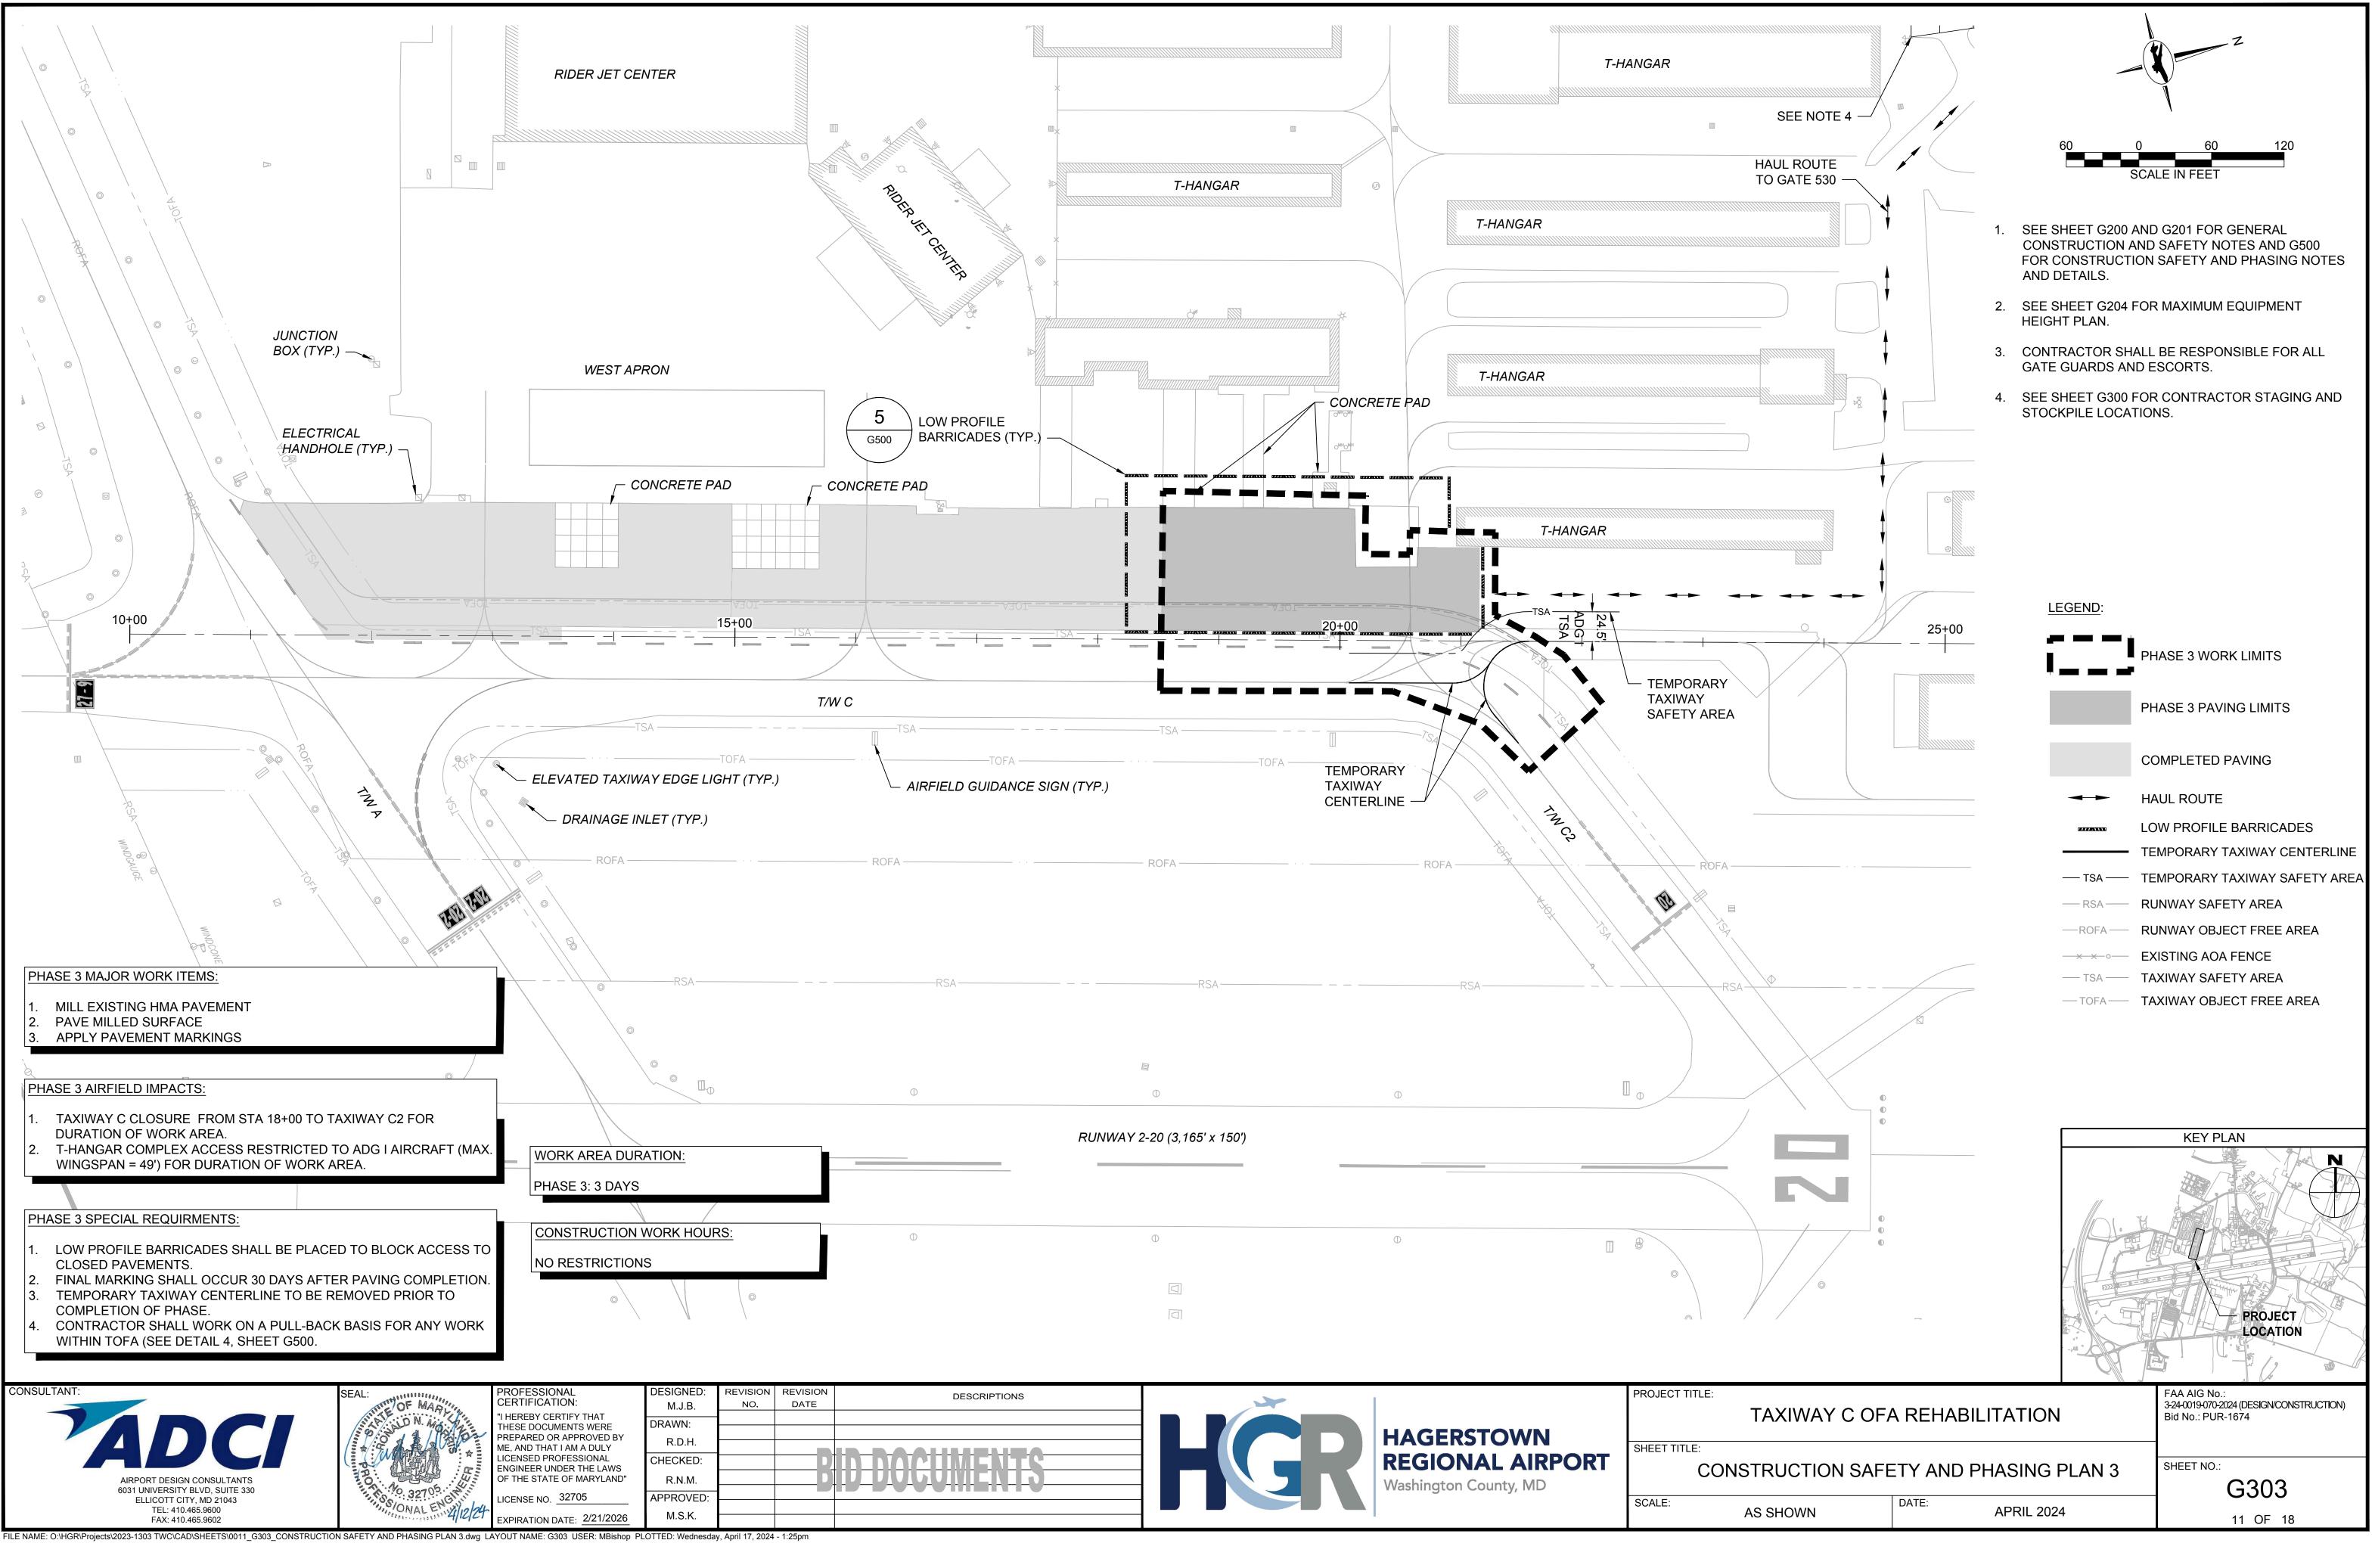


DEDOCCUMENTS INTERVIEW OF A COUNTY, MD SHEET	T TITLE: CO E:

GENERAL PHASING NOTES:

- 1. THE INTENT OF THE PHASING PLAN IS TO MINIMIZE THE IMPACT OF CONSTRUCTION ON THE OPERATION OF THE AIRPORT. THE CONTRACTOR SHALL CONSTRUCT THE PROJECT AS OUTLINED IN THE PLANS UNLESS OTHERWISE APPROVED BY THE RESIDENT PROJECT REPRESENTATIVE (RPR). ADJUSTMENTS TO THE PHASING PLAN MAY BE NECESSARY TO ACCOMMODATE UNFORESEEN PROBLEMS WITH AIRPORT OPERATION.
- 2. THE CONTRACTOR SHALL PROVIDE, MAINTAIN, MOVE, REMOVE (AS DIRECTED) THE SAME PERSON EACH DAY THROUGHOUT THE CONSTRUCTION BARRIERS TO DELINEATE AREAS CLOSED TO AIRCRAFT TRAFFIC AND TO PROJECT. THE SUPERINTENDENT SHALL HAVE THE MARK ALL OPEN EXCAVATIONS, PAVEMENT DROP-OFFS ETC. RESPONSIBILITY OF COORDINATING EACH DAY'S WORK
- 3. THE CONTRACTOR SHALL SUBMIT A CONSTRUCTION SCHEDULE FOR REVIEW AND APPROVAL OF THE RPR PRIOR TO STARTING CONSTRUCTION. STRICT ADHERENCE TO THE APPROVED SCHEDULE WILL BE ENFORCED TO AVOID CONFLICTS WITH OTHER CONSTRUCTION ACTIVITIES AND ADVERSE EFFECTS ON AIRPORT OPERATIONS.
- 4. ELECTRICAL WORK SHALL BE SEQUENCED TO MAINTAIN ALL ELECTRICAL SYSTEMS WITHOUT ANY INTERRUPTIONS. TEMPORARY WIRING IF REQUIRED SHALL BE INCIDENTAL TO THE CORRESPONDING ELECTRICAL WORK. ALL ELECTRICAL WORK SHALL BE COORDINATED WITH THE RPR AND THE AIRPORT MAINTENANCE DEPARTMENT. THE RPR AND WEEKENDS MUST B
- 5. EROSION AND SEDIMENT CONTROL DEVICES MUST BE IN PLACE PRIOR TO THE START OF GRADING OPERATIONS.
- 6. ACTIVE PAVEMENTS MUST BE KEPT CLEAR AND FREE OF DEBRIS AT ALL TIMES. THE CONTRACTOR MUST HAVE A VACUUM SWEEPER AND OPERATOR READY AT ALL TIMES DURING WORK ADJACENT TO ACTIVE AIRFIELD PAVEMENTS.
- 7. THE CONTRACTOR MUST COMPLY WITH ALL APPLICABLE FAA ADVISORY CIRCULARS AND FEDERAL AVIATION REGULATIONS. PAY PARTICULAR ATTENTION TO FAA AC 150/5370-2G.
- 8. MAXIMUM EQUIPMENT HEIGHTS FOR ACTIVE WORK AREAS AND STAGING AREA ARE LIMITED BY FAR PART 77 AND OBSTACLE FREE ZONE (OFZ) SURFACES IDENTIFIED ON THIS SHEET.
- 9. DUST ON CONSTRUCTION PROJECTS IS A MAJOR PROBLEM. THE CONTRACTOR SHALL BE RESPONSIBLE FOR DUST CONTROL ON-SITE AT ALL TIMES ON A CONTINUOUS BASIS. THE CONTRACTOR MUST SUBMIT A DETAILED DUST CONTROL PLAN TO THE RPR FOR APPROVAL PRIOR TO BEGINNING WORK. THE COST FOR THIS WORK SHALL BE INCLUDED UNDER VARIOUS CONTRACT ITEMS.
- 10. RED LIGHTS SHALL MEET THE LUMINANCE REQUIREMENTS OF THE FAA.


TEL: 410.465.9600

FAX: 410.465.9602

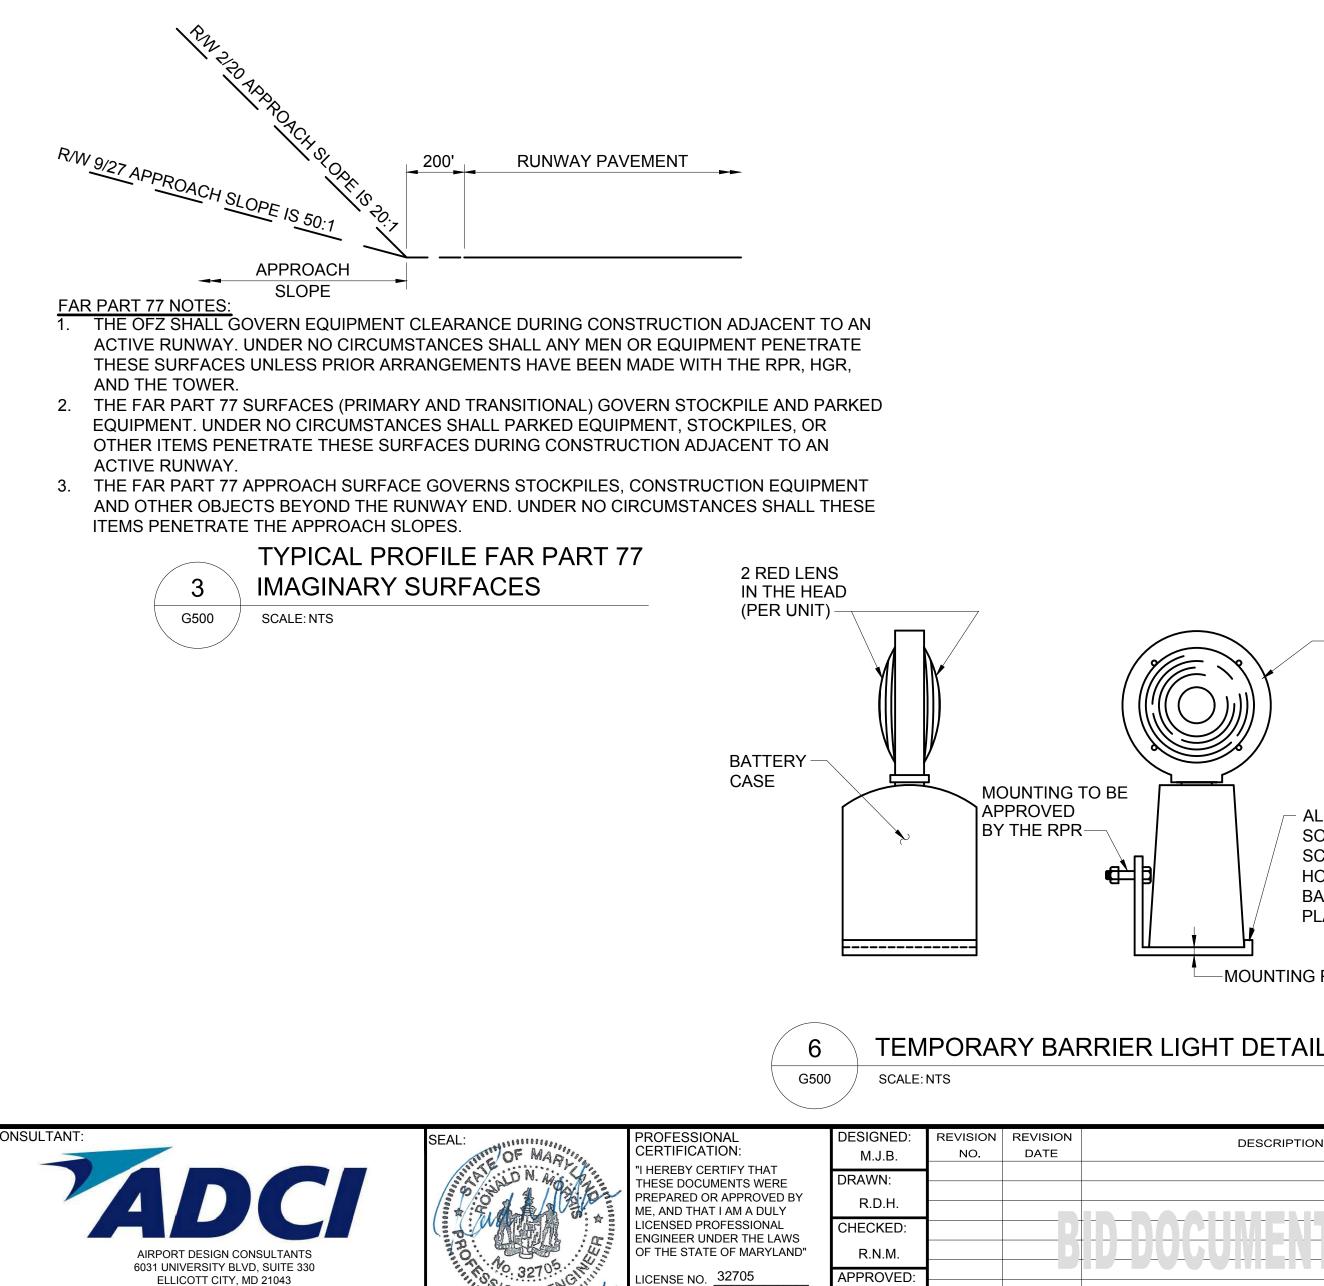


SUPERVISION:


THE PRIME CONTRACTOR SHALL HAVE THE PROJECT SUPERINTENDENT OR SOMEONE IN RESPONSIBLE CHARGE BE PRESENT AT ALL TIMES ON THE PROJECT SITE. THIS PERSON SHALL BE FAMILIAR WITH ALL TYPES OF CONSTRUCTION BEING PERFORMED AND SHALL BE THE SAME PERSON EACH DAY THROUGHOUT THE RESPONSIBILITY OF COORDINATING EACH DAY'S WORK WITH THE RPR AND AIRPORT PERSONNEL AND SHALL HAVE AUTHORITY TO SCHEDULE AND ADJUST ALL WORKERS, PRIME AND SUB CONTRACTORS, TO ACCOMMODATE AIRPORT OPERATION AS DIRECTED BY ALL WORK MUST BE PERFORMED WITH THE RPR AND/OR AIRPORT PERSONNEL ON THE SITE. WORK DURING EVENINGS AND WEEKENDS MUST BE COORDINATED WITH THE RPR AND AIRPORT PERSONNEL AT LEAST 7 DAYS IN ADVANCE, EXCLUDING EMERGENCIES AND SHALL CLEAR THE CONSTRUCTION AREA ONCE WORK HAS STOPPED FOR THE DAY. ALL MECHANICS NEEDING ACCESS TO THE AIR OPERATIONS AREA DURING EVENINGS AND WEEKENDS TO WORK ON CONSTRUCTION EQUIPMENT SHALL HAVE A PICTURED IDENTIFICATION BADGE, RECEIVE DRIVING PRIVILEGES, AND HAVE THEIR VEHICLES IDENTIFIED WITH THE CONTRACTOR NAME OR MAGNETIC PLACARD ISSUED BY THE AIRPORT

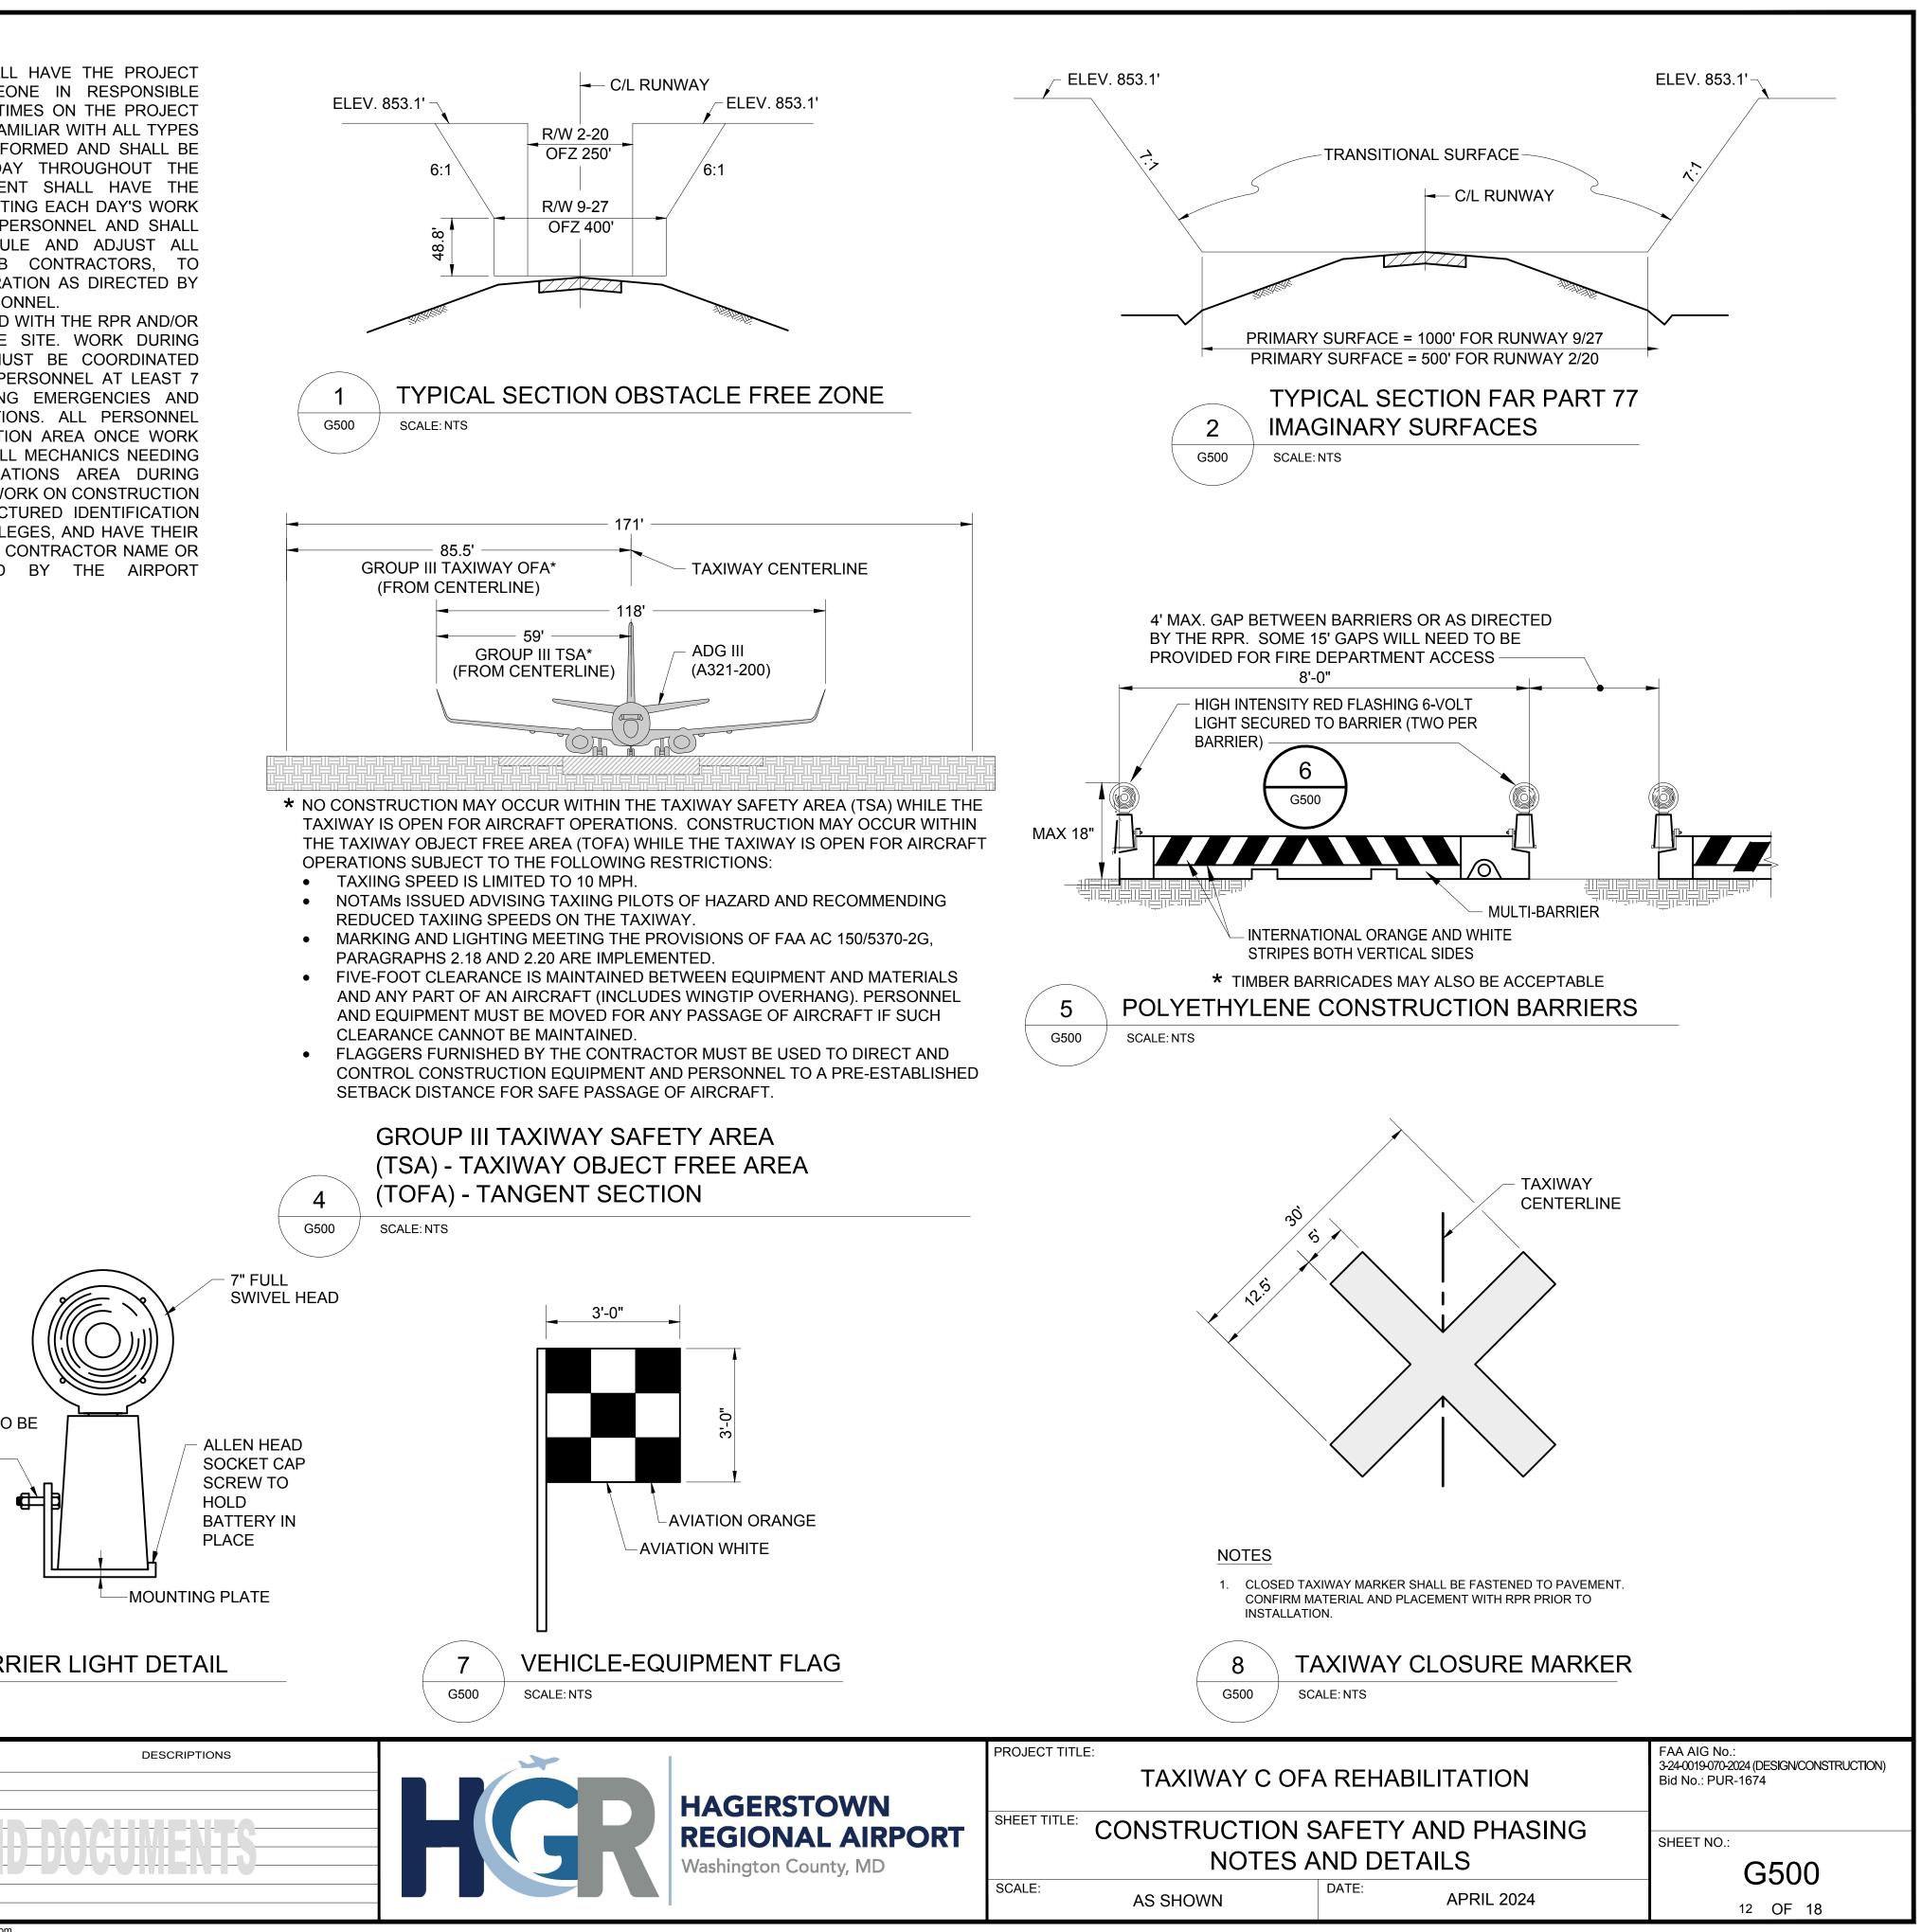



M.S.K.

EXPIRATION DATE: 2/21/2026

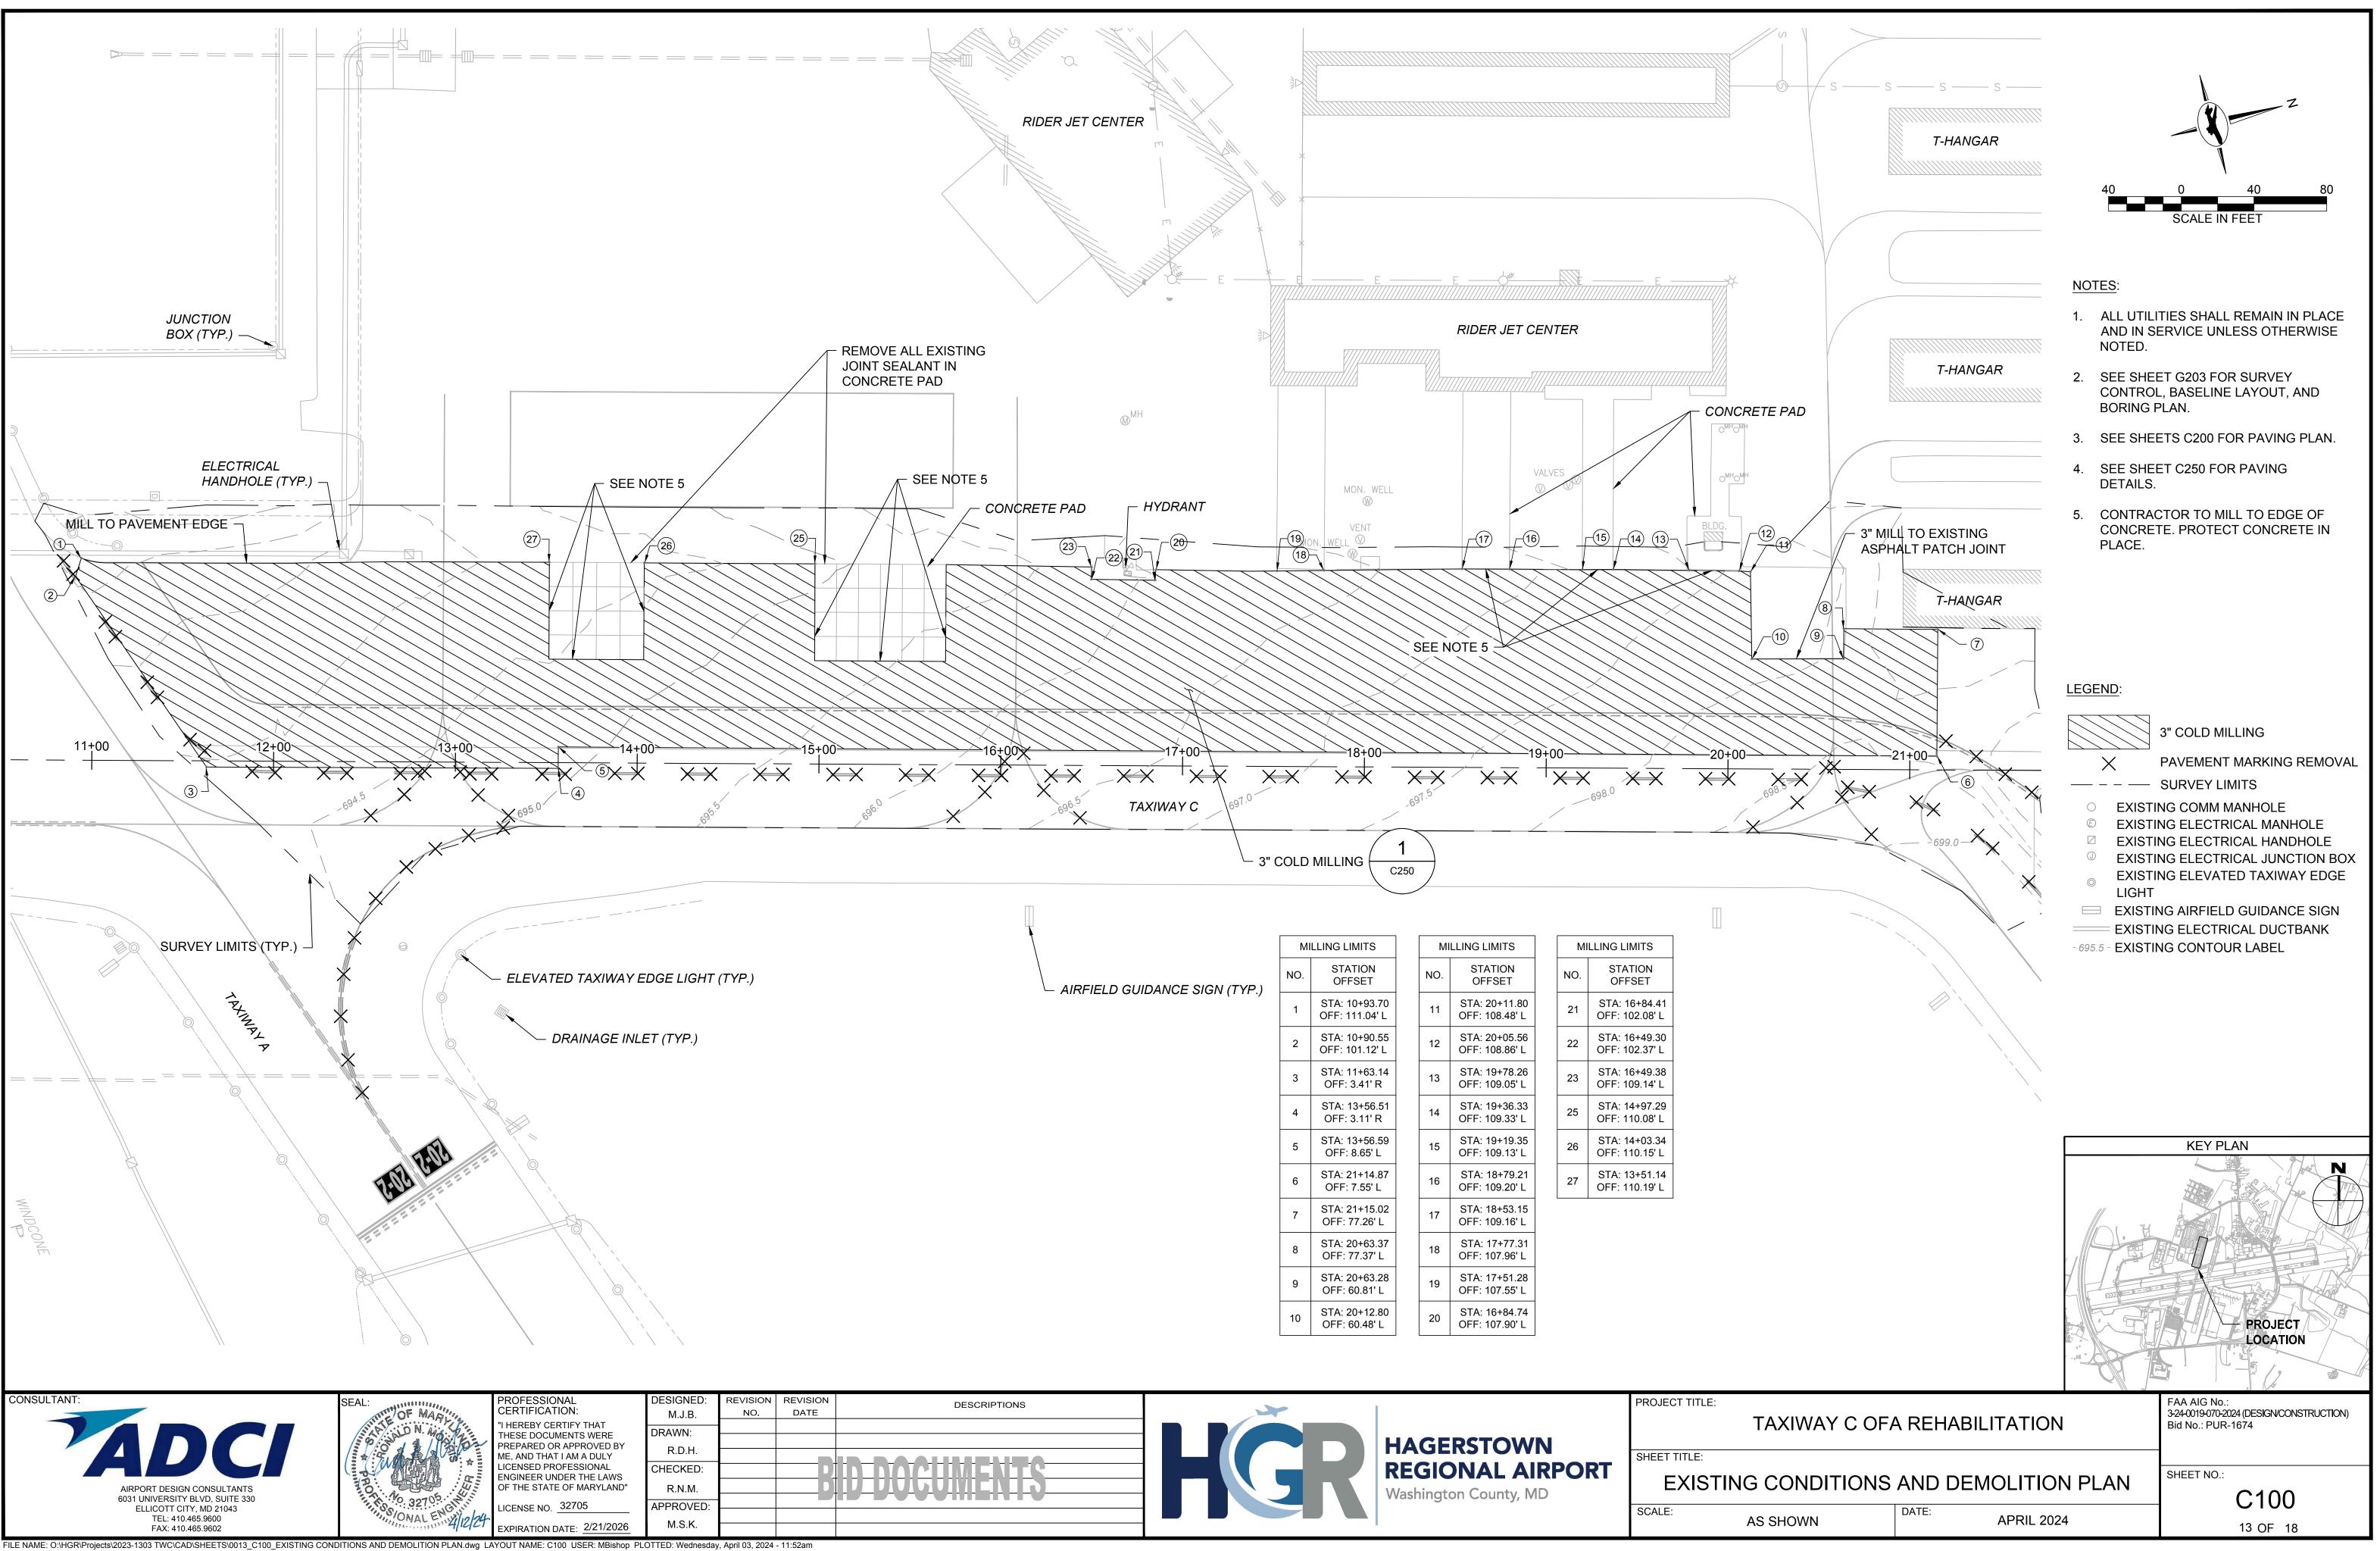


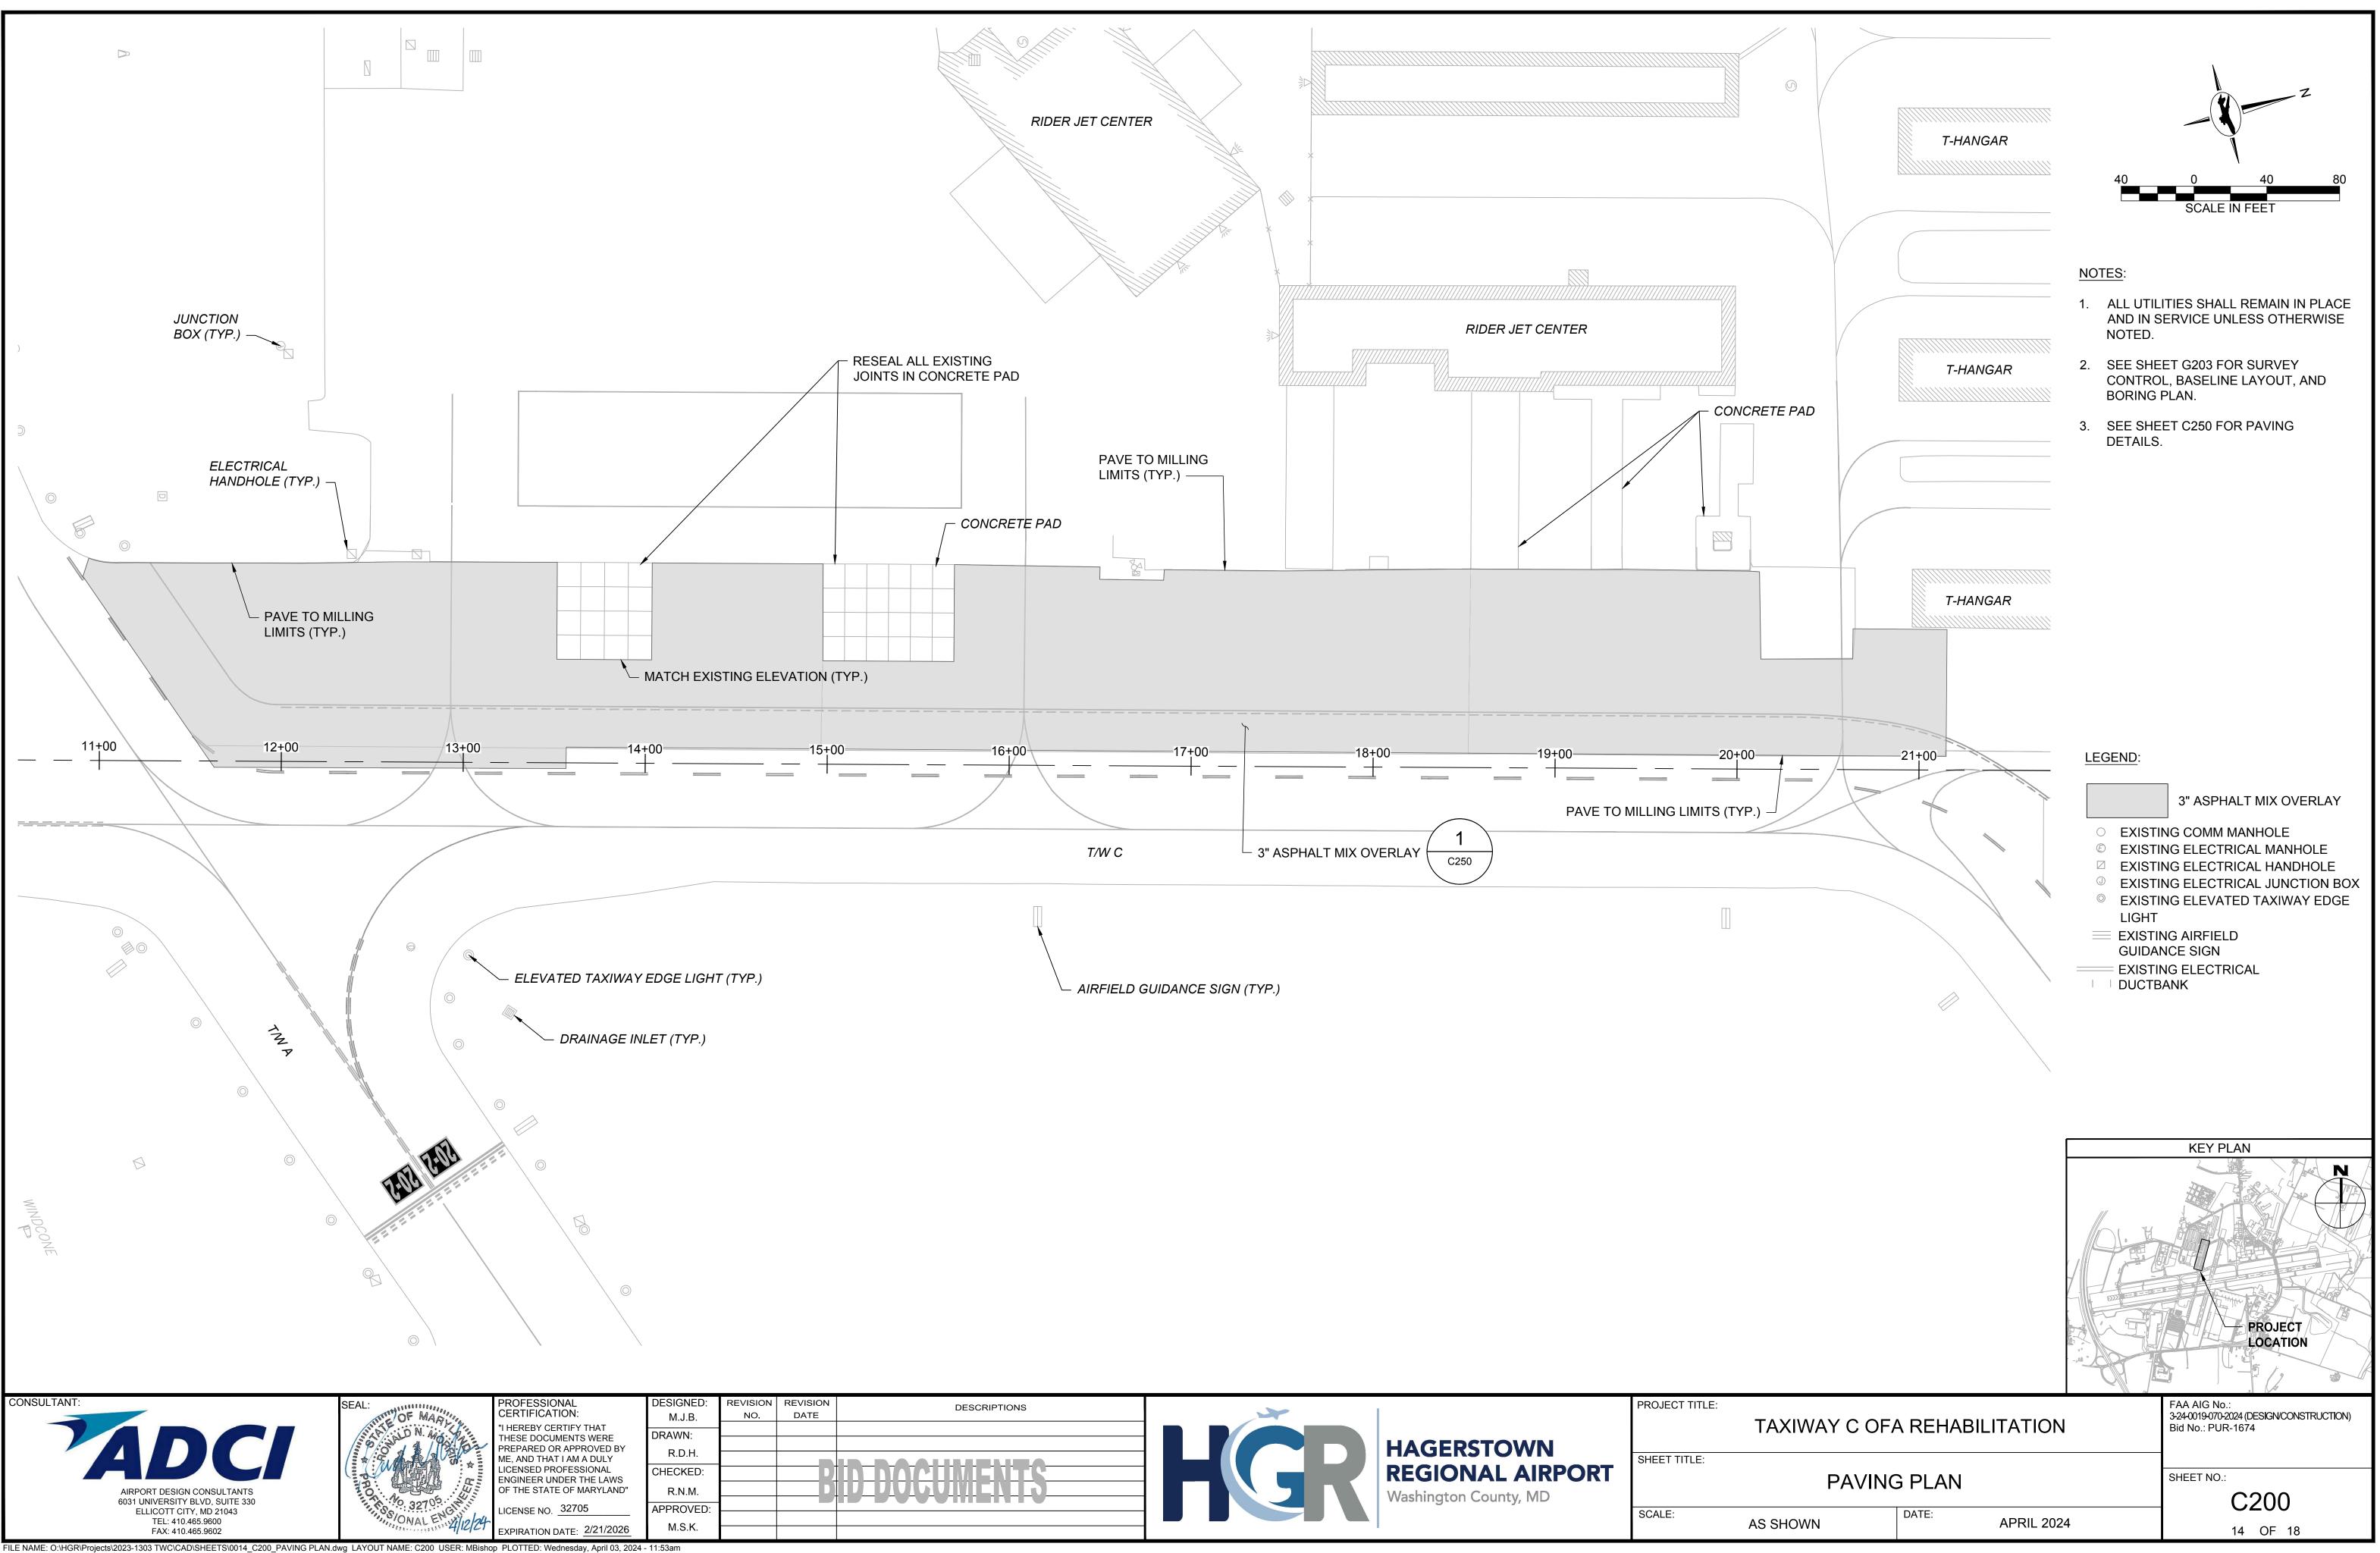

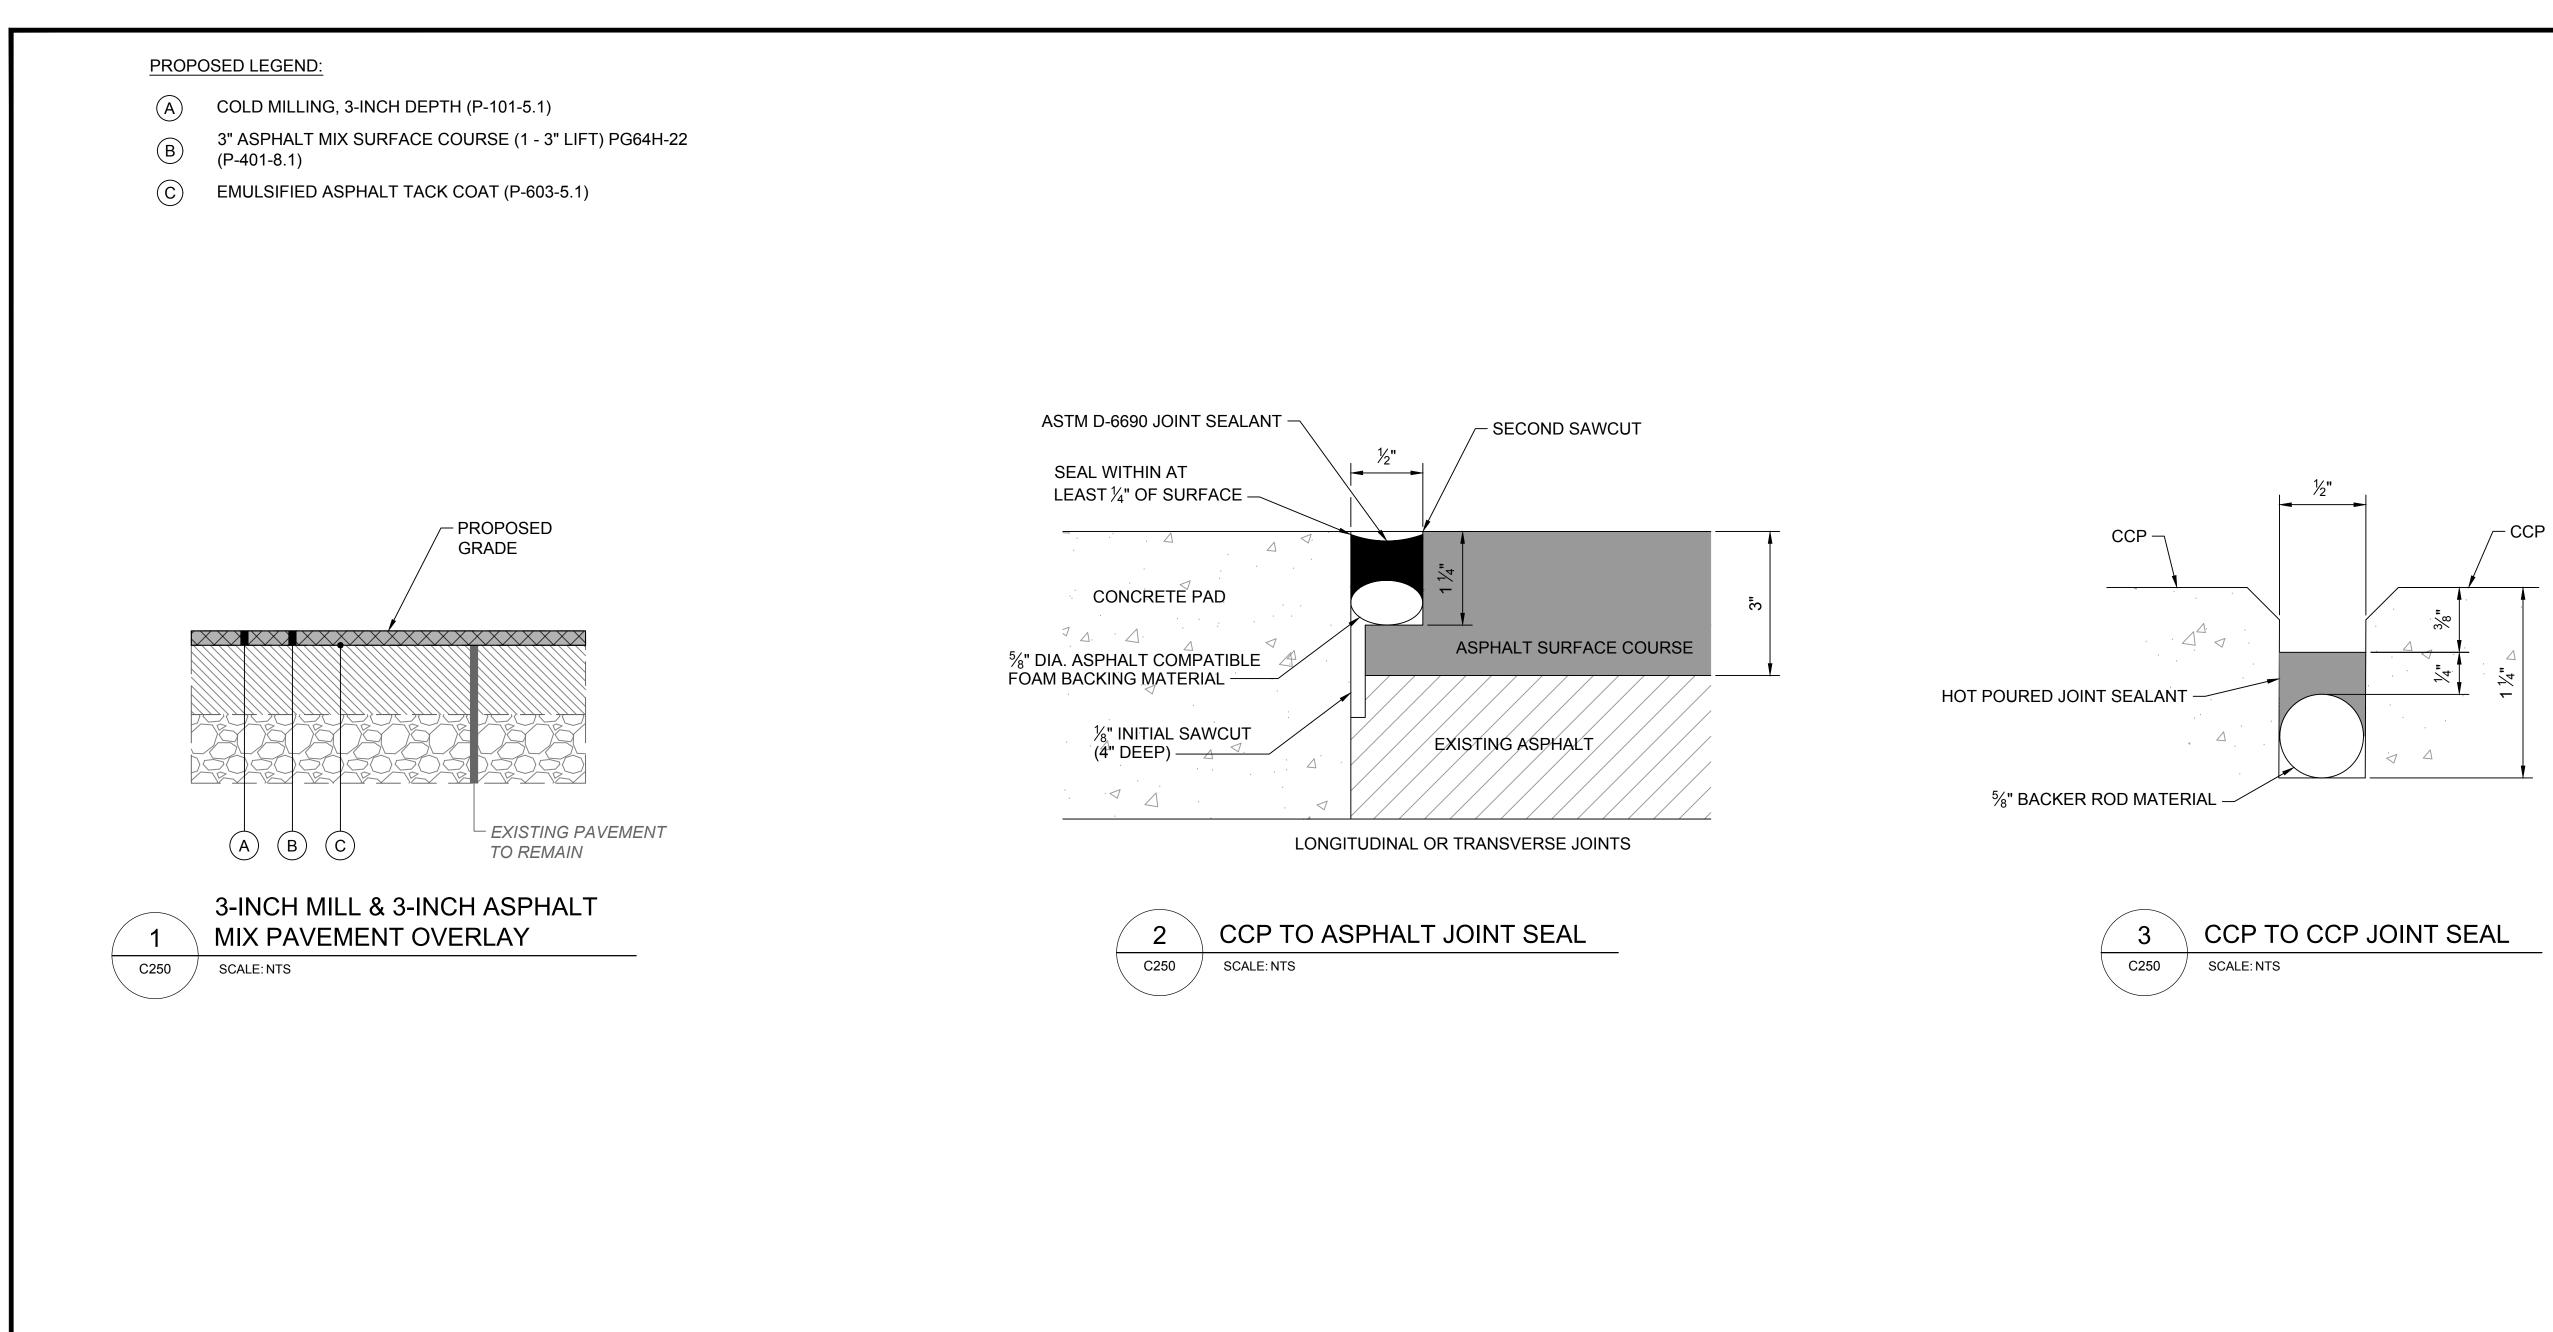

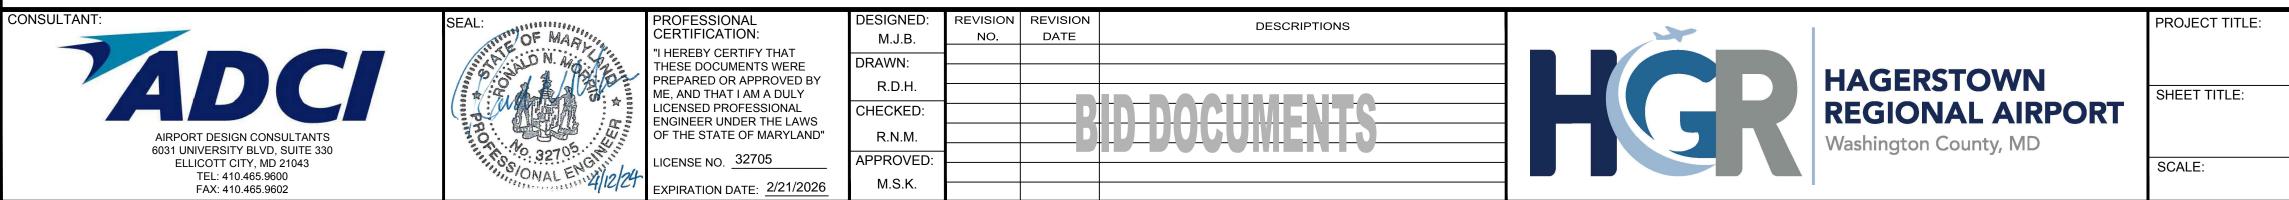

TAXIWAY C OF	COFAREHABILITATION Bid No.: PUR-1674		-24-0019-070-2024 (DESIGN/CONSTRUCTION)
PAVING	DETAILS	S	C250
AS SHOWN	DATE: APRIL 20	24	15 OF 18

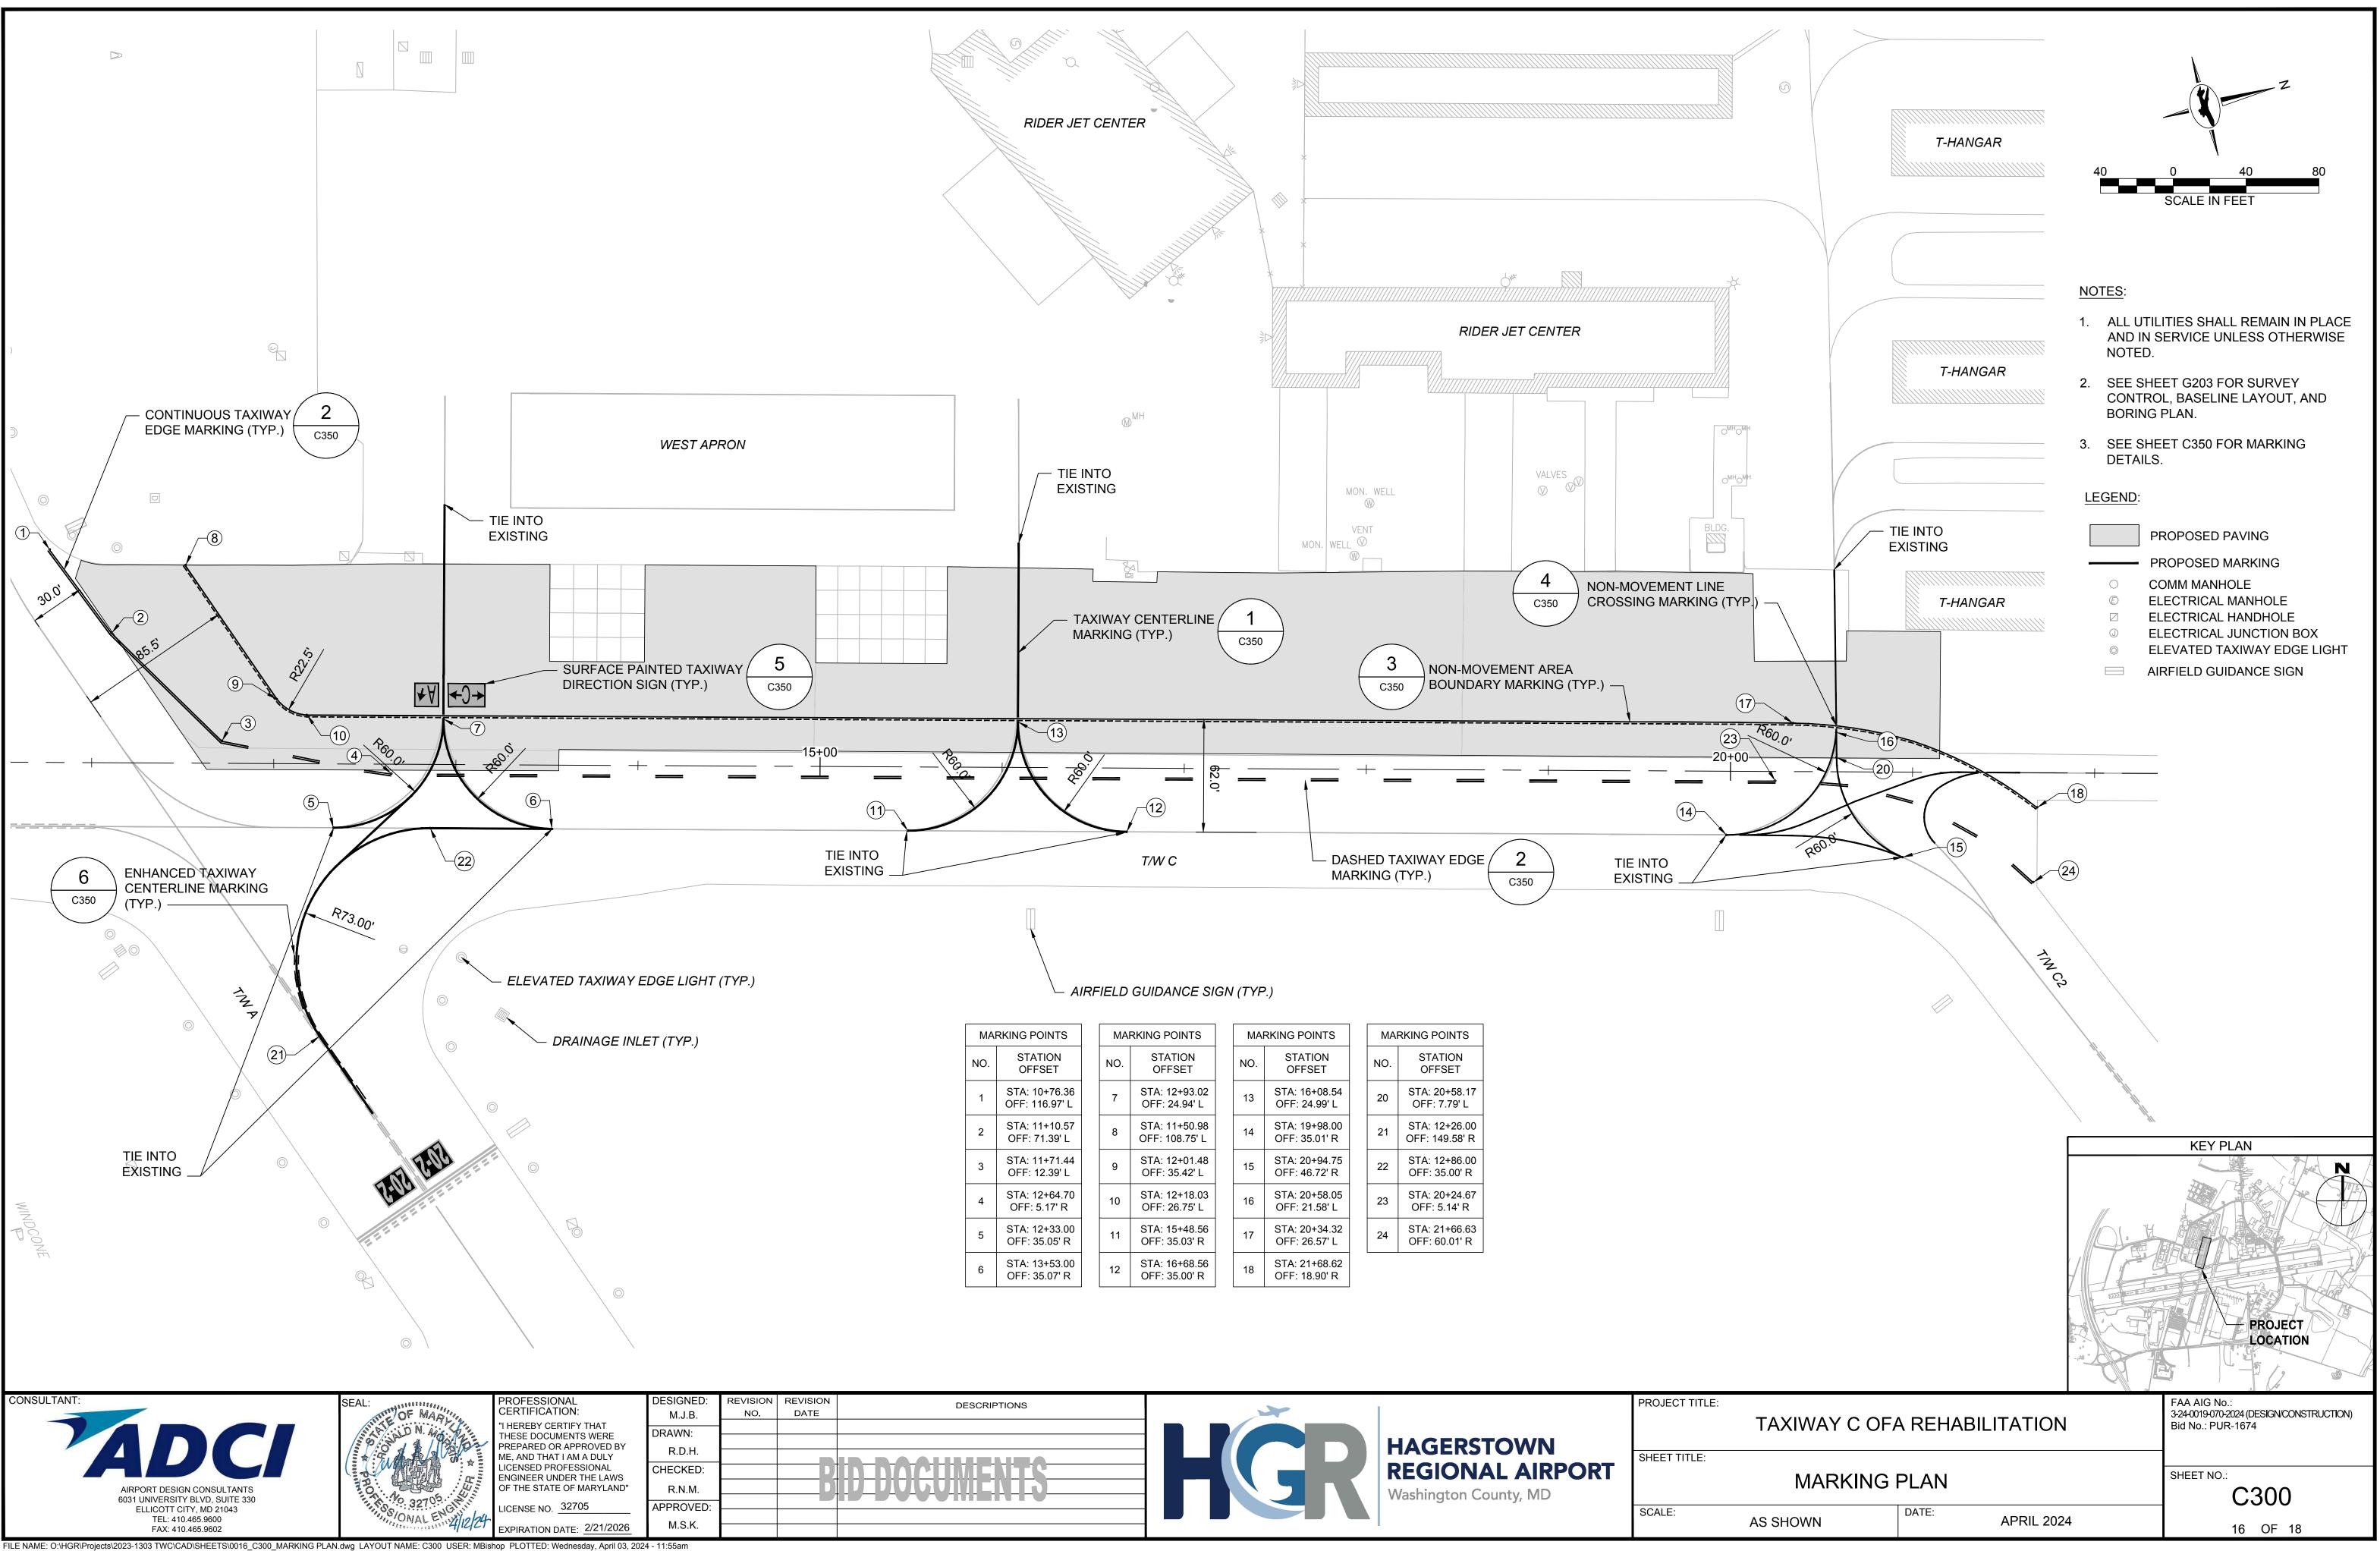


└─ AIRFIELD GUIDANCE SIGN (TYP.,)
----------------------------------	---

MA	RKING POINTS
NO.	STATION OFFSET
1	STA: 10+76.36 OFF: 116.97' L
2	STA: 11+10.57 OFF: 71.39' L
3	STA: 11+71.44 OFF: 12.39' L
4	STA: 12+64.70 OFF: 5.17' R
5	STA: 12+33.00 OFF: 35.05' R
6	STA: 13+53.00 OFF: 35.07' R

POINTS	MA	RKING POIN
ATION FSET	NO.	STATIC OFFSE
12+93.02 : 24.94' L	13	STA: 16+0 OFF: 24.9
11+50.98 108.75' L	14	STA: 19+9 OFF: 35.0
12+01.48 : 35.42' L	15	STA: 20+9 OFF: 46.7
12+18.03 : 26.75' L	16	STA: 20+5 OFF: 21.5
15+48.56 35.03' R	17	STA: 20+3 OFF: 26.5
16+68.56 35.00' R	18	STA: 21+6 OFF: 18.9
	•	


MARKING POINTS			
NO.	STATION OFFSET		
20	STA: 20+58.17 OFF: 7.79' L		
21	STA: 12+26.00 OFF: 149.58' R		
22	STA: 12+86.00 OFF: 35.00' R		
23	STA: 20+24.67 OFF: 5.14' R		
24	STA: 21+66.63 OFF: 60.01' R		

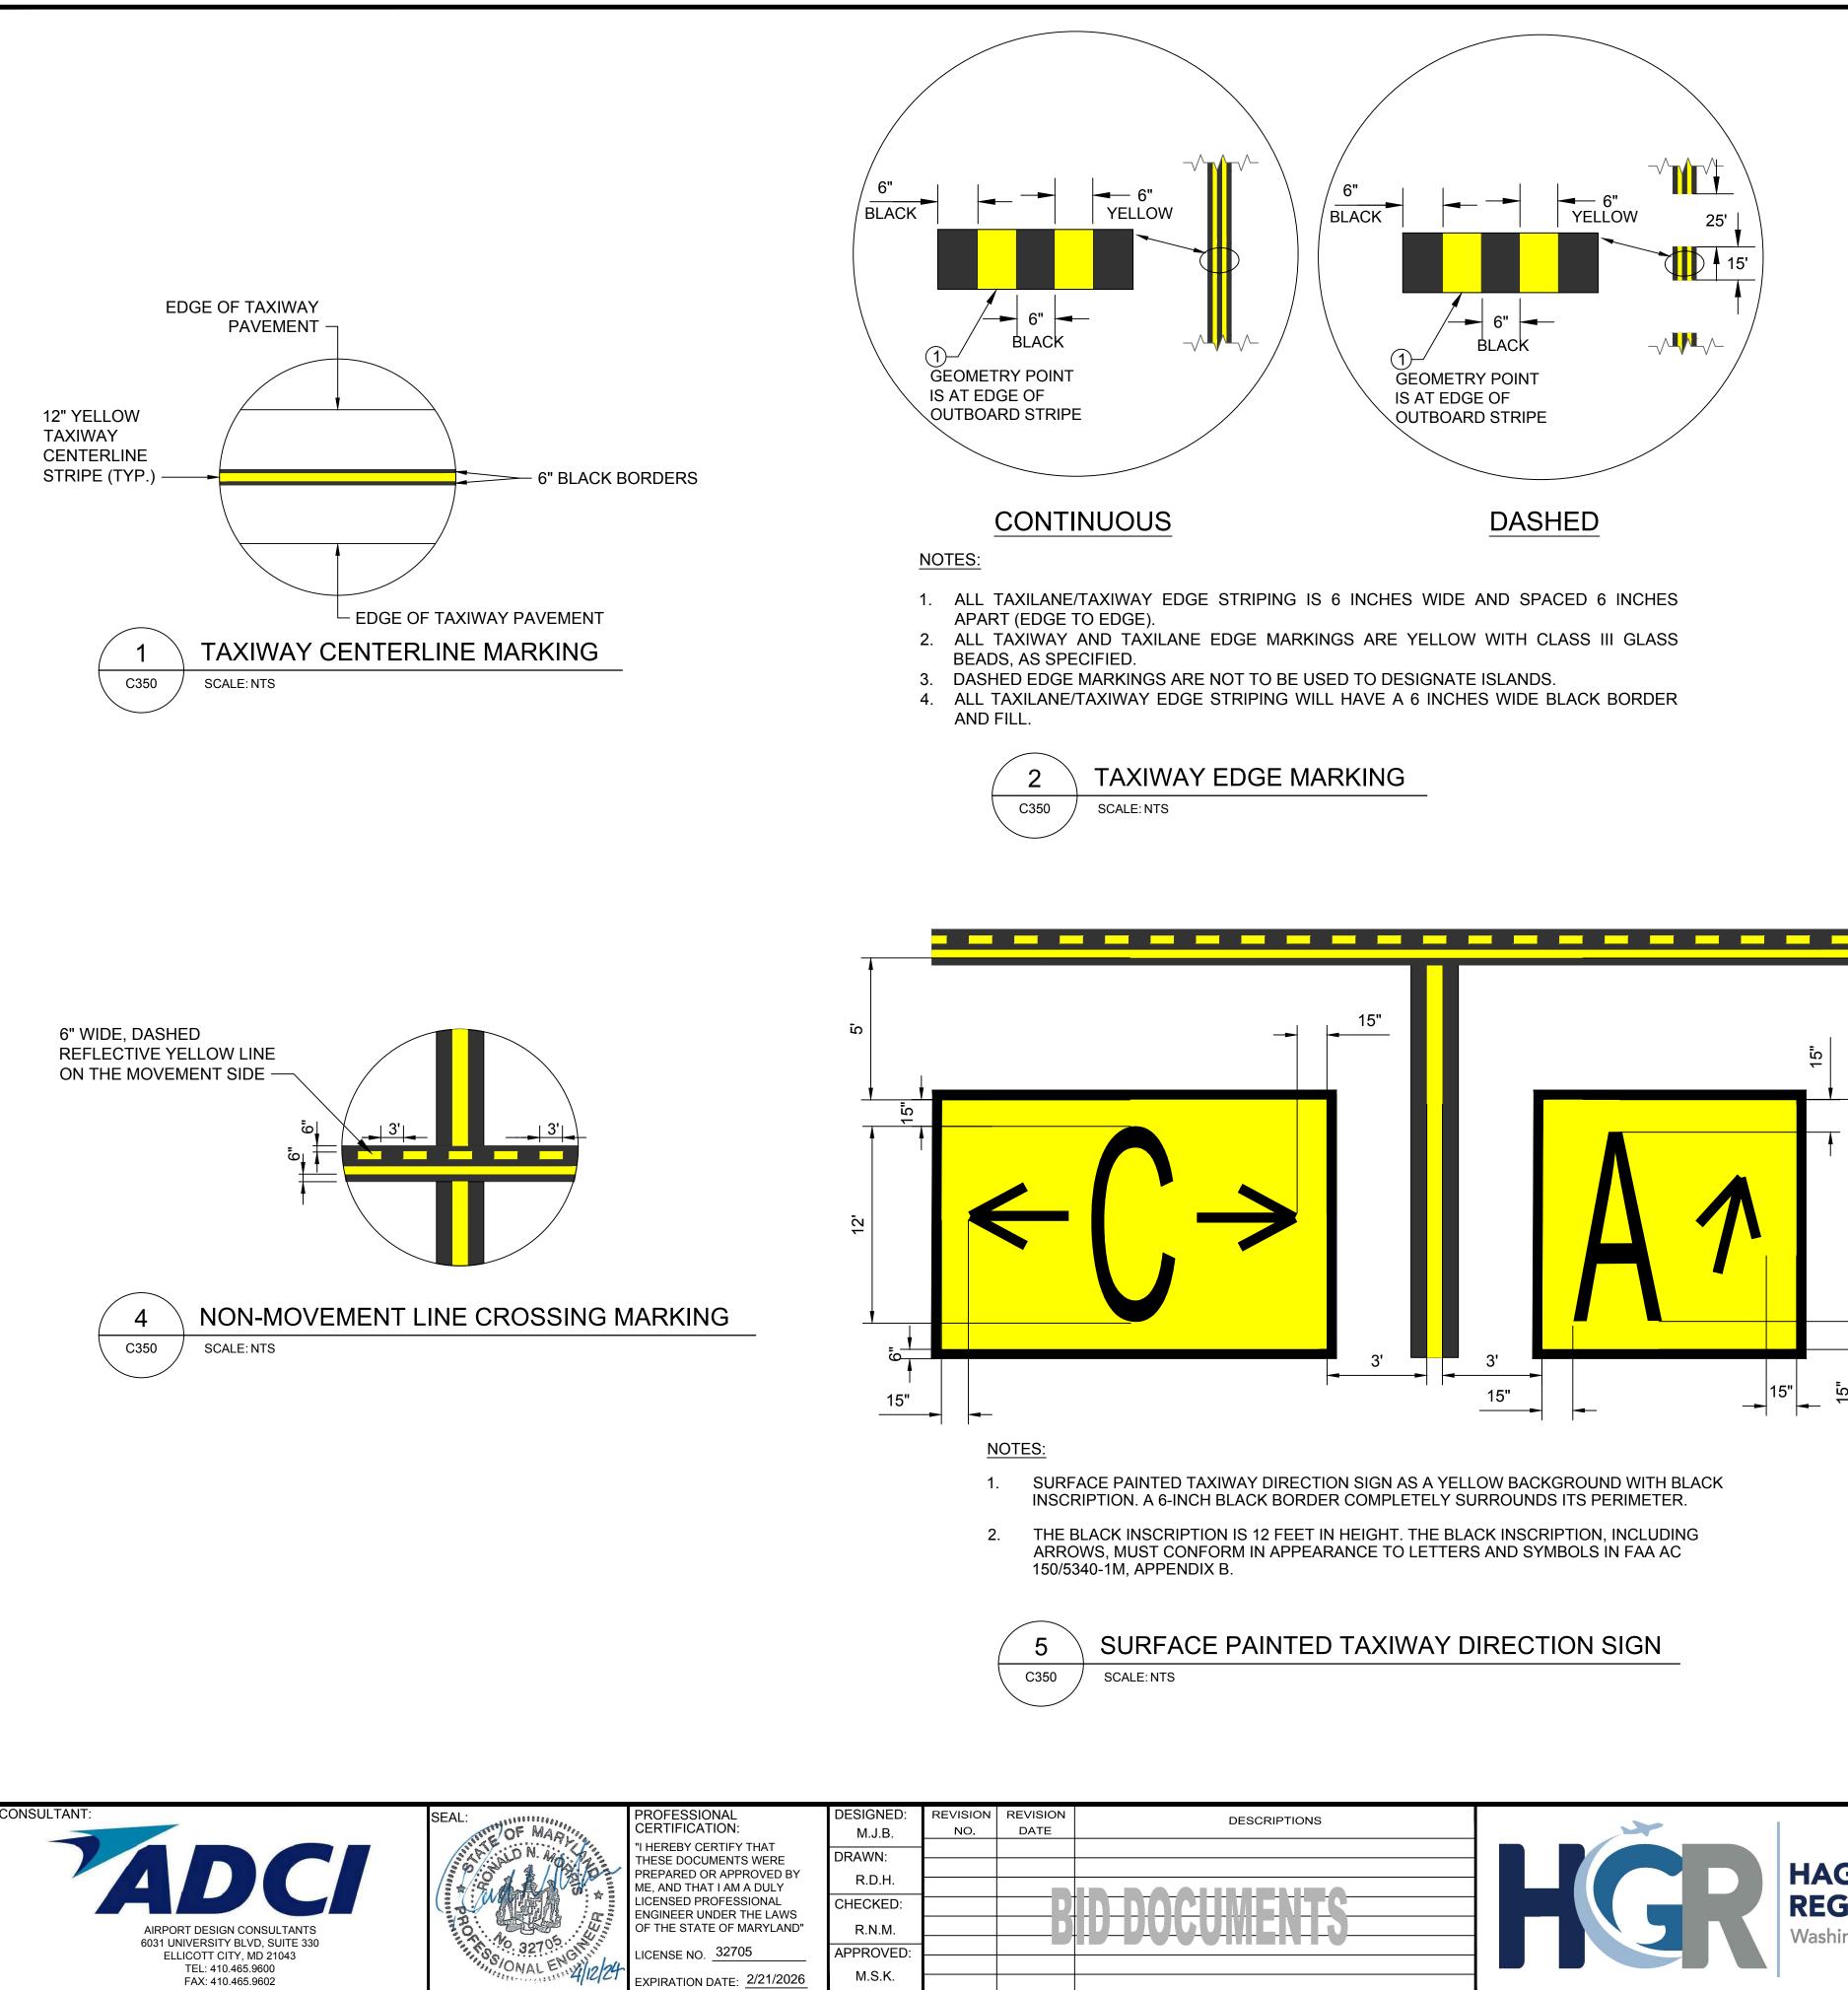

FILE NAME: O:\HGR\Projects\2023-1303 TWC\CAD\SHEETS\0017_C350_MARKING DETAILS.dwg LAYOUT NAME: C350 USER: MBishop PLOTTED: Wednesday, April 03, 2024 - 11:55am




ຸ້ມ

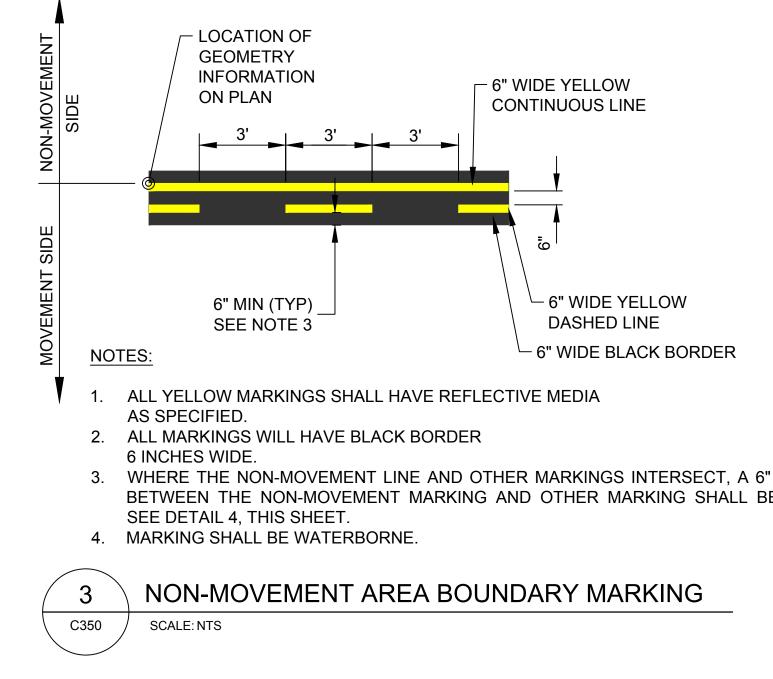




- NOTES:

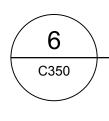

3. WHERE THE NON-MOVEMENT LINE AND OTHER MARKINGS INTERSECT, A 6" MINIMUM GAP BETWEEN THE NON-MOVEMENT MARKING AND OTHER MARKING SHALL BE MAINTAINED.

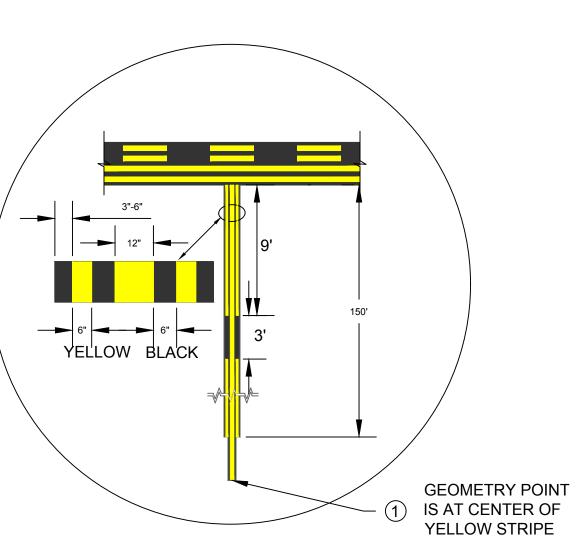

1. THE DISTANCE BETWEEN THE EDGE OF THE YELLOW HOLD LINE AND THE END OF THE YELLOW TAXIWAY CENTERLINE IS 6".

2. THE 9' IS MEASURED ALONG CENTERLINE WITH THE INNER CHORD BEING SLIGHTLY SHORTER AND THE OUTER CHORD BEING SLIGHTLY LONGER.

3. THE NUMBER OF DASHES SHALL ALWAYS BE EQUAL.


4. THERE MUST BE NO PARTIAL DASHED LINES LESS THAN 5' AT THE POINT OF CONVERGENCE. THE FIRST INSIDE DASHED LINE MUST BE ALIGNED WITH THE OUTSIDE DASHED LINE.

5. THE 150' DISTANCE IS MEASURED ALONG THE ENHANCED CENTERLINE.


ENHANCED TAXIWAY CENTERLINE MARKING

SCALE: NTS

TAXIWAY C OFA REHABILITATION		FAA AIG No.: 3-24-0019-070-2024 (DESIGN/CONSTRUCTION) Bid No.: PUR-1674	
MARKING	SHEET NO.: C350		
AS SHOWN	DATE:	APRIL 2024	17 OF 18

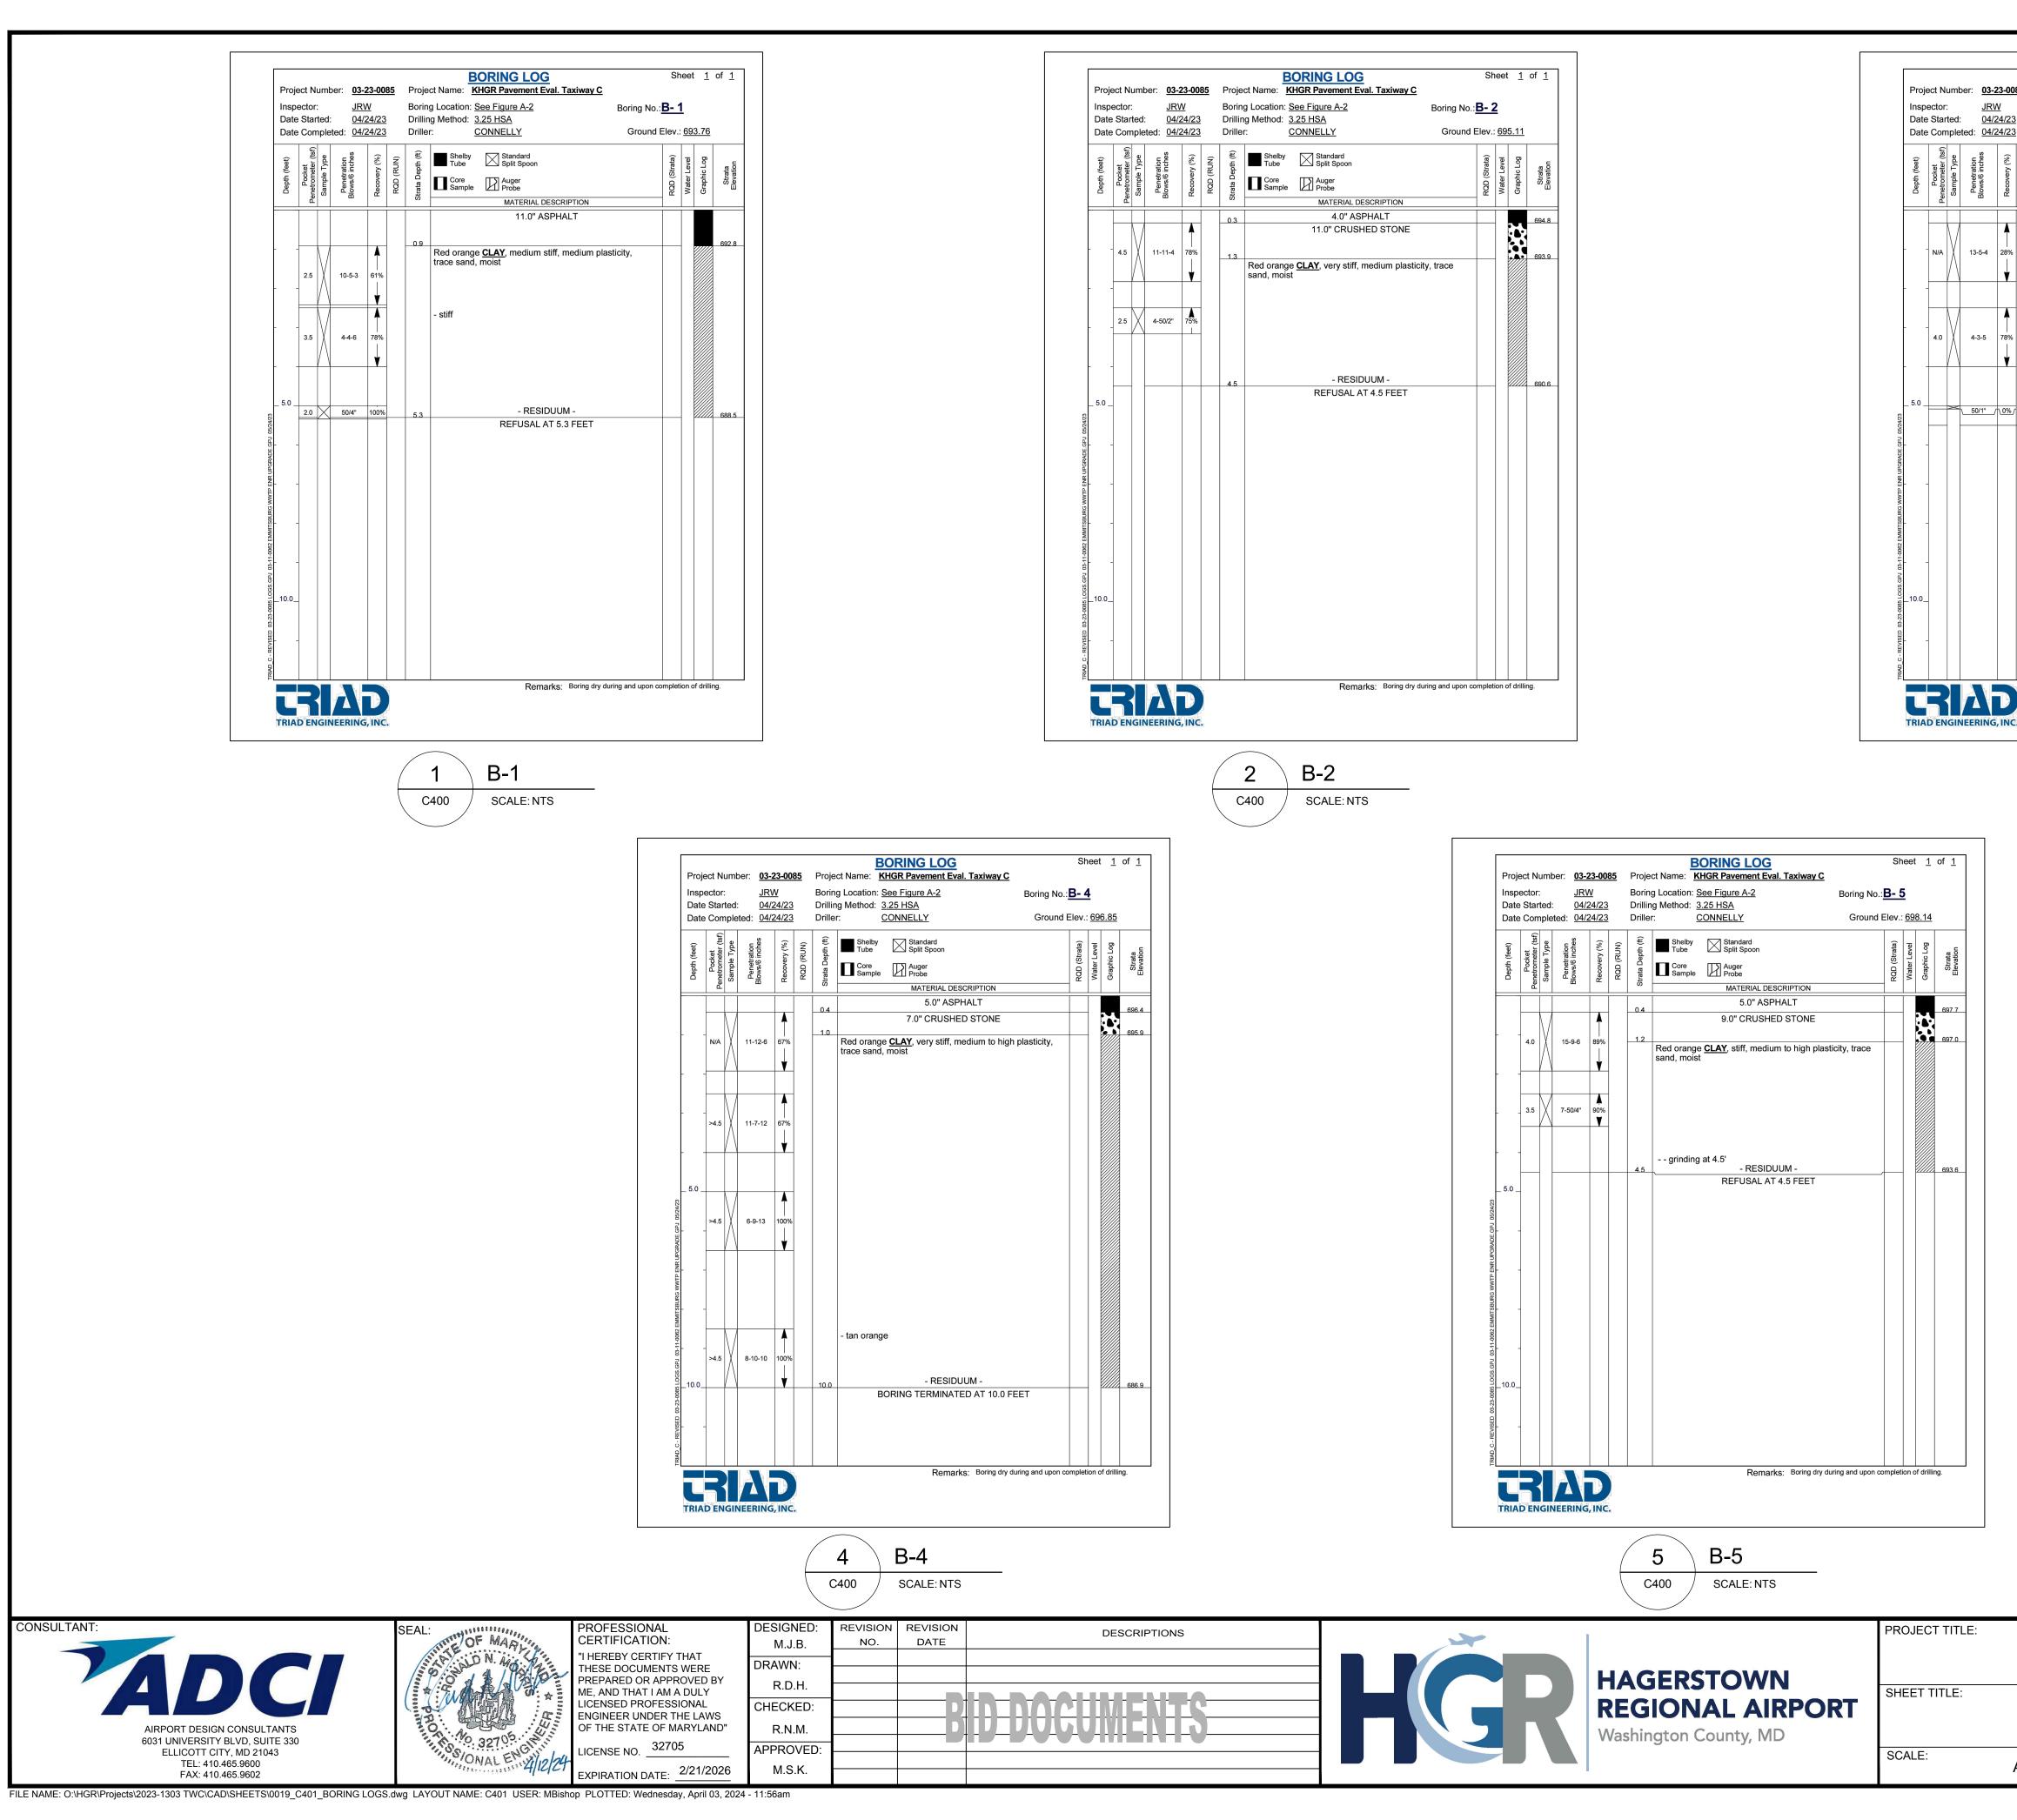

185 3 3	Boring Drillin	Project Name: KHGR Pavement Eval. Taxiway C Boring Location: See Figure A-2 Boring No Drilling Method: 3.25 HSA Ground Driller: CONNELLY Ground			.:: B- 3 I Elev.: <u>695.74</u>				
RQD (RUN)	Strata Depth (ft)	Shelby Standard Tube Split Spoon Core Auger Sample MATERIAL DESCRIPTION	RQD (Strata)	Water Level	Graphic Log	Strata Elevation			
	0.3	3.0" ASPHALT				695.5			
	1.3	12.0" CRUSHED STONE Red orange <u>CLAY</u> , stiff, medium to high plasticity, trace				694.5			
		- medium stiff							
- r		- RESIDUUM -							
-	5.5	REFUSAL AT 5.5 FEET		-		690.2			

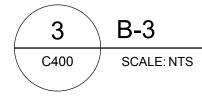

FAA AIG No.: 3-24-0019-070-2024 (DESIGN/CONSTRUCTION) Bid No.: PUR-1674 TAXIWAY C OFA REHABILITATION **BORING LOGS** SHEET NO .: C400 DATE: APRIL 2024 AS SHOWN

18 OF 18