

PROJECT DESCRIPTION AND SCOPE OF WORK (SOW) SUMMARY

THE FOLLOWING IS A SUMMARY OF THE NATURE AND INTENT OF THE WORK, IT INCLUDES BUT IS NOT LIMITED TO THE FOLLOWING:

- 1) REMOVAL OF AN EXISTING ROOF MOUNTED CHILLER/TOWER PACKAGE.
- 2) PROVIDE (FURNISH AND INSTALL) A NEW AIR COOLED CHILLER/PUMP PACKAGE.
- 3) MINOR STRUCTURAL/ROOFING WORK TO ACCOMMODATE THE NEW CHILLER.
- 4) ELECTRICAL WORK ASSOCIATED WITH NEW INSTALLATION OF THE NEW CHILLER.
- 5) COORDINATE WITH OWNER EXISTING BUILDING TEMPERATURE CONTROLS CONTRACTOR TO ACCOMMODATE THE NEW CHILLER.
- 6) MISC. OTHER WORK AS INDICATED ON THE PLANS OR REQUIRED TO PROVIDE A COMPLETE INSTALLATION READY FOR CONTINUOUS USE.


WASHINGTON COUNTY MARYLAND

BOARD OF COUNTY COMMISSIONERS

CIRCUIT COURT - CHILLER REPLACEMENT

24 SUMMIT AVE HAGERSTOWN, MD 21740

PROJECT #PUR-1625

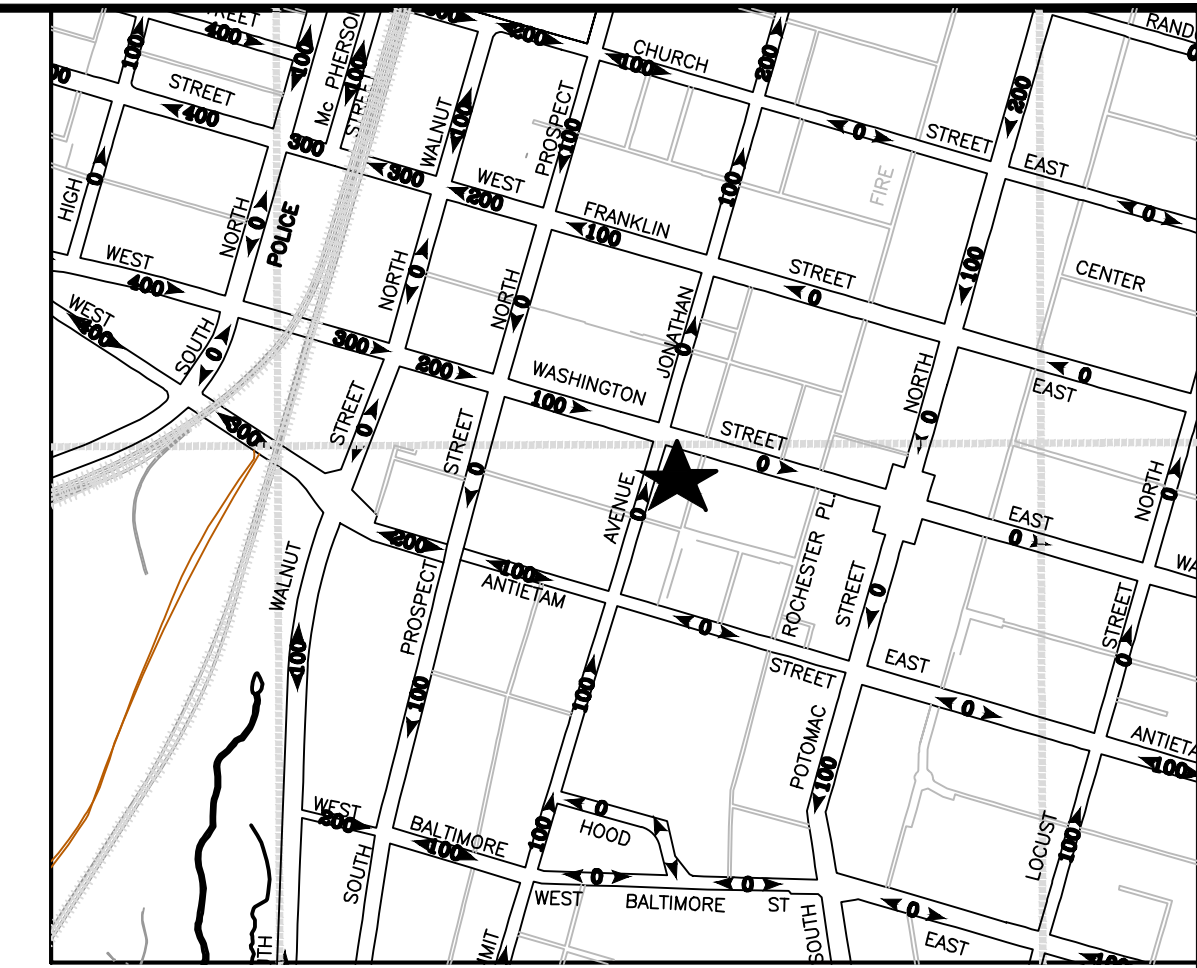

VICINITY MAP
NOT TO SCALE

L.S. GRIM CONSULTING ENGINEERS
PRIME CONSULTANT AND DESIGNER OF RECORD

MATONAK AND ASSOCIATES
STRUCTURAL CONSULTANT



DRAWING LIST	
C-0.0	PROJECT COVER SHEET
M-0.0	MECHANICAL COVER SHEET
M-1.0	MECHANICAL ROOF PLAN
M-1.1	MECHANICAL SCHEDULE
M-2.0	MECHANICAL SCHEDULES AND DETAILS
E-0.0	ELECTRICAL COVER SHEET
E-1.0	ELECTRICAL NEW WORK PLAN
S-1	STRUCTURAL MODIFICATIONS


BOARD OF COUNTY COMMISSIONERS:

JOHN F. BARR, PRESIDENT
JEFFREY A. CLINE, VICE PRESIDENT
WAYNE K. KEEFER
RANDALL E. WAGNER
DEREK J. HARVEY.

JOHN M. MARTIRANO, COUNTY ADMINISTRATOR
ANDREW ESHLEMAN, DIRECTOR OF PUBLIC WORKS
DANIEL HIXON, ASSISTANT DIRECTOR OF PUBLIC WORKS BG+F

21-062

L.S. GRIM, INC.
Consulting Engineers

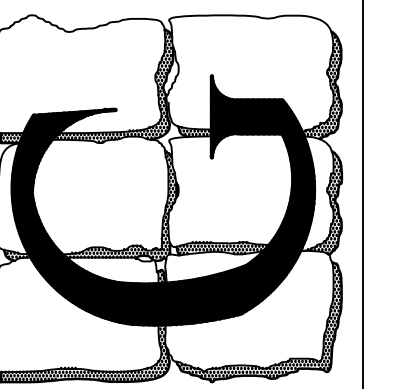

CIRCUIT COURT
CHILLER REPLACEMENT
24 SUMMIT AVE HAGERSTOWN, MD 21740
PROJECT COVER SHEET


Professional Certification
I certify that these documents were prepared or approved by me, and that I am a duly licensed engineer under the laws of the State of Maryland.
License Number: 14401
Expiration Date: 4/21/2025

LESLIE SCOTT GRIM, P.E.
CO. PROF. ENG. NO. PE0050461
DC. PROF. ENG. NO. PE90201
DE. PROF. ENG. NO. 19513
GA. PROF. ENG. NO. PE032682
HI. PROF. ENG. NO. PE13043
MD. PROF. ENG. NO. 14401
NE. PROF. ENG. NO. 033364
NJ. PROF. ENG. NO. 38497
NY. PROF. ENG. NO. 075414
PA. PROF. ENG. NO. PE032636E
VA. PROF. ENG. NO. 023240
WV. PROF. ENG. NO. 10764


REV.	DATE	COMMENT
1	5/11/23	BID/ PERMIT SET

DRAWN BY: LBG
C-0.0
1 OF 8 SHEETS
DATE: MAY 11, 2023

MECHANICAL SYMBOLS

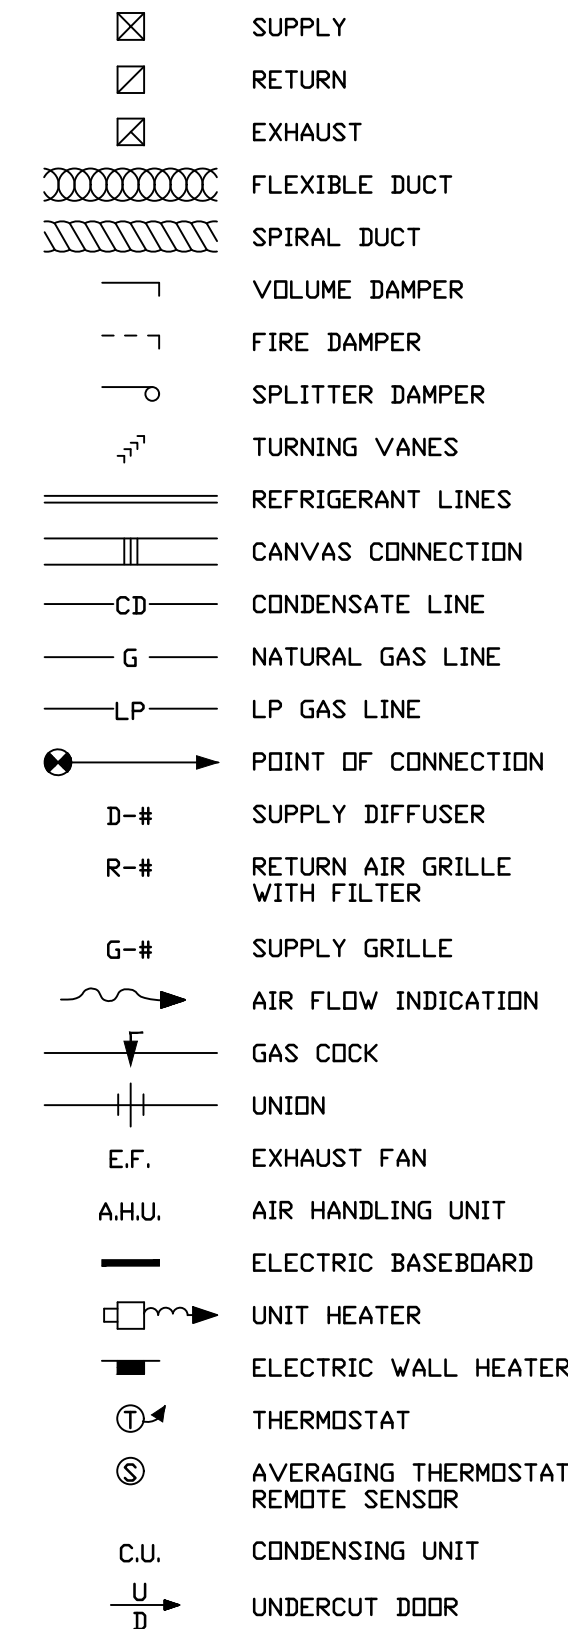

DUCTWORK SYMBOLS

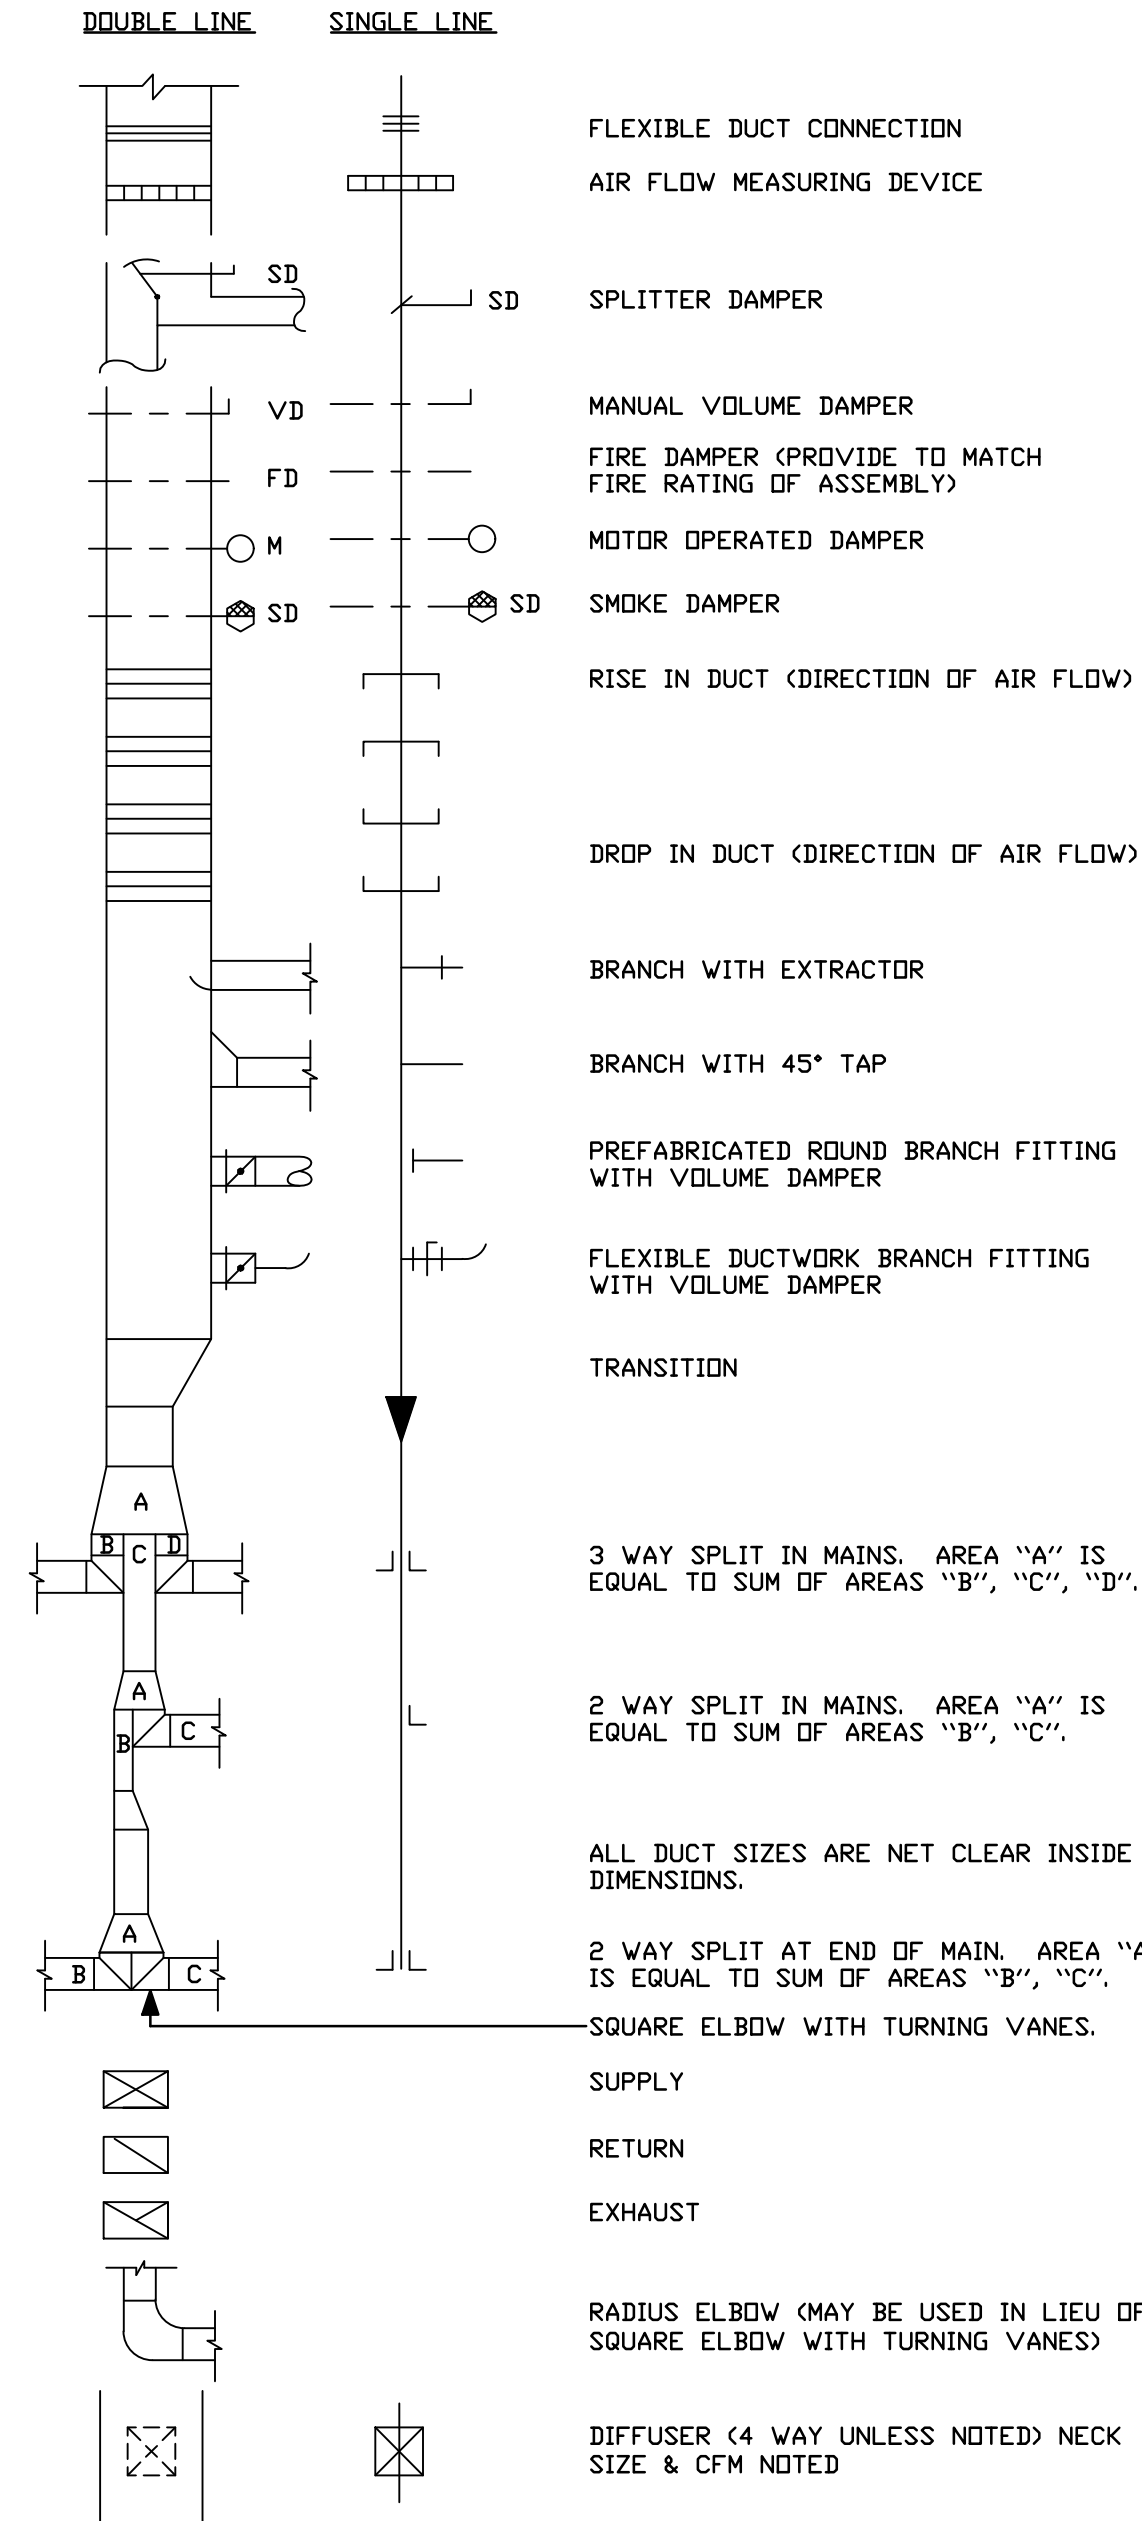

MECHANICAL NOTES AND REQUIREMENTS

- FOR RENOVATION WORK THE MECHANICAL CONTRACTOR SHALL INSPECT ANY EXISTING MECHANICAL ITEMS TO BE REUSED FOR DEFECTS AND REPORT TO THE ARCHITECT/ENGINEER AND THE OWNER ANY DEFICIENCIES PRIOR TO PERFORMING ANY WORK.
- CONTRACTOR SHALL BALANCE THE AIR DISTRIBUTION SYSTEM TO AIR QUANTITIES INDICATED ON THE DRAWINGS AND SUBMIT (3) COPIES OF THE BALANCE REPORT TO THE ENGINEER FOR APPROVAL.
- CONTRACTOR SHALL SPRAY PAINT INSIDE OF DUCT BLACK, BEHIND ALL GRILLES AND REGISTERS.
- ALL PIPING SHALL BE INSTALLED AS INDICATED ON THE DRAWINGS IN A NEAT WORKMANSHIP-LIKE MANNER AND BE SUPPORTED AS REQUIRED BY CODES. PIPING SHALL BE SET UP AND DOWN AND OFFSET AS REQUIRED TO SUIT FIELD CONDITIONS. DIELECTRIC COUPLINGS SHALL BE USED WHERE DISSIMILAR METALS ARE JOINED.
- PIPING HANGERS SHALL BE SPACED SO AS TO PREVENT SAG AND PERMIT PROPER DRAINAGE AND SHALL NOT BE SPACED MORE THAN EIGHT FEET APART UNLESS A GREATER SPACE IS INDICATED ON THE DRAWINGS. A HANGER SHALL BE PLACED WITHIN (1) FOOT OF EACH HORIZONTAL ELBOW.
- ISOLATE AND DRAIN EXISTING PIPING SYSTEM AS REQUIRED TO ACCOMMODATE INSTALLATION OF THE NEW WORK.
- HOT WATER AND CHILLED WATER SUPPLY AND RETURN PIPING SHALL BE BLACK STEEL PIPE, SCHEDULE 40 FOR 2-1/2 INCH AND LARGER, SEAMLESS COPPER TYPE 'L' FOR 2 INCH AND BELOW.
- REFRIGERANT PIPING OTHER THAN PRECHARGED TUBING SETS FURNISHED BY AIR CONDITIONING MANUFACTURER SHALL BE TYPE 'ACR' HARD DRAWN COPPER TUBING WITH WROUGHT COPPER FITTINGS. PIPING SHALL BE INSTALLED IN ACCORDANCE WITH ARI STANDARDS. USE EASY-FLO OR SAFETY SILVER BRAZING ALLOY TO MAKE JOINTS. RUN ALL HORIZONTAL LINES DEAD LEVEL TO ENSURE PROPER GAS RETURN TO COMPRESSOR.
- THE INSTALLATION OF ALL INSULATION SHALL BE PERFORMED BY A EXPERIENCED CRAFTSMAN IN A NEAT WORKMANSHIP-LIKE MANNER AND SHALL BE IN ACCORDANCE WITH THE MANUFACTURER'S WRITTEN PUBLISHED RECOMMENDATIONS FOR SERVICE INTENDED.
- ALL MATERIALS OF INSULATION SHALL BE OF THE TYPE AND QUALITY AS MANUFACTURED BY ARMSTRONG, CERTAINTED, OWENS-CORNING OR MANVILLE. ALL MATERIAL AND EQUIPMENT SPECIFIED TO BE INSULATED SHALL BE THOROUGHLY TESTED AND APPROVED PRIOR TO APPLYING THE INSULATION.
- REFRIGERATION SUCTION AND HOT GAS BY-PASS SHALL BE INSULATED WITH 1 INCH THICK ARMSTRONG 'ARMAFLEX' OR EQUAL. EXTERIOR INSULATION SHALL BE COATED WITH ULTRAVIOLET RESISTANT MATERIAL IN ACCORDANCE WITH THE MANUFACTURER'S RECOMMENDATIONS, OR USE UL RATED PRODUCT. DO NOT INSULATE THE LIQUID LINE.
- ALL EXTERIOR EXPOSED WATER PIPING SHALL BE INSULATED WITH 2 INCH PREFORMED FIBERGLASS INSULATION WITH VAPOR JACKET AND SELFSEALING TAPE EQUAL TO OWENS-CORNING ASJ/SSL-II. COVER INSULATION WITH .016 INCH THICK ALUMINUM JACKET.
- MECHANICAL CONTRACTOR SHALL FURNISH A COMBINATION STARTER SIZED IN ACCORDANCE WITH THE MOTOR RATING OF THE MECHANICAL EQUIPMENT STARTER SHALL BE SUPPLIED WITH FUSES OR CIRCUIT BREAKERS, CONTROL TRANSFORMER, OVERLOADS, ONE N.O. AND ONE N.C. AUXILIARY CONTACT AND H.D.A. SWITCH MOUNTED IN THE COVER. STARTER ENCLOSURE SHALL BE NEMA RATED FOR ITS LOCATION. STARTER SHALL BE INSTALLED AND WIRED BY THE ELECTRICAL CONTRACTOR.
- CONTRACTOR SHALL PROVIDE ALL AIR TEMPERATURE CONTROLS INCLUDING WIRING, TUBING AND THERMOSTATS (WITH LOCKING COVERS) AND ALL MISCELLANEOUS APPURTENANCES TO MEET THE INTENT OF THESE DOCUMENTS.
- EQUIPMENT AND MAINS - SHUT OFF VALVES SHALL BE EQUAL TO NIBCO MODEL S-113 LF SOLDERED JOINT, MODEL T-113 LF THREADED JOINT, BRONZE GATE VALVE NONRISING STEM, 300 PSI W.O.G., 125 PSI S.W.P. CONTRACTOR MAY SWAP AN EQUIVALENT BALL VALVE FOR THE GATE VALVE.
- BALL VALVES SHALL BE EQUAL TO NIBCO, S-585-66-LF, BRONZE, RATED FOR 600 W.O.G.
- VIBRATION ISOLATORS FOR HANGING EQUIPMENT SHALL BE EQUAL TO MASON INDUSTRIES MODEL 30N, COMBINATION SPRING AND DOUBLE DEFLECTION NEOPRENE HANGER, OR DEFLECTION AS RECOMMENDED BY MANUFACTURER.
- VIBRATION ISOLATORS FOR BASE MOUNTED EQUIPMENT SHALL BE EQUAL TO MASON INDUSTRIES MODEL SLF, DEFLECTION AS RECOMMENDED BY MANUFACTURER.
- ALL EQUIPMENT AND MATERIAL FURNISHED SHALL BE FREE FROM DEFECTS IN WORKMANSHIP AND MATERIAL. ALL EQUIPMENT AND MATERIALS SHALL MEET THE REQUIREMENTS OF ALL CODES AND STANDARDS OF LOCAL AND STATE AGENCIES HAVING JURISDICTION.
- WHERE A SUBCONTRACTOR PROPOSES TO USE AN ITEM OR EQUIPMENT OTHER THAN THE SPECIFIED OR DETAILED ITEM ON THE DRAWINGS THAT IS APPROVED BY THE ENGINEER AND THAT REQUIRES REDESIGN OF THE STRUCTURE PARTITIONS, FOUNDATIONS, PIPING, WIRING OR ANY OTHER PART OF THE MECHANICAL, ELECTRICAL, OR ARCHITECTURAL LAYOUT, THEN SUCH REDESIGN, NEW DRAWINGS, AND DETAILING REQUIRED FOR IT SHALL BE PREPARED BY THE SUBCONTRACTOR WITHOUT EXTRA COMPENSATION.
- THE SUBMITTAL WHICH HAS BEEN REVIEWED BY THE ENGINEER, WITH OR WITHOUT COMMENTS, DOES NOT RELIEVE THE CONTRACTOR FROM THE REQUIREMENTS OF COMPLYING WITH THE CONTRACT DOCUMENTS. ONLY SUBMITTALS WHICH EXPLICITLY REQUEST THE ENGINEER TO REVIEW DEVIATIONS WITH THE CONTRACT DOCUMENTS RELIEVE THE CONTRACTOR FROM THE SPECIFIC ITEM OF COMPLIANCE.
- THE LOCATIONS SHOWN ON THE DRAWINGS ARE APPROXIMATE, AND ARE TO SERVE AS GUIDE FOR THE INSTALLATION. THE SHIFTING OF LOCATIONS TO MEET CONDITIONS (BEFORE INSTALLATION) WILL BE EXPECTED, AND THIS SHALL BE DONE AT NO INCREASED COST.
- FOR PURPOSES OF CLEARNESS AND LEGIBILITY, MECHANICAL DRAWINGS ARE ESSENTIALLY DIAGRAMMATIC AND INDICATE ONLY SIZES, CONNECTION POINTS, AND ROUTES. IT IS NOT INTENDED OR IMPLIED THAT ALL OFFSETS, RISES, AND DROPS ARE AS SHOWN.

BUILDING AUTOMATIC TEMPERATURE CONTROLS

- THE OWNER'S ATC CONTRACTOR, CONTROL SYSTEMS INC., IS RESPONSIBLE FOR THE INTERFACE OF THE NEW CHILLER MACHINE WITH THE BUILDING MANAGEMENT/ ATC SYSTEM. THE CHILLER CONTRACTOR SHALL COORDINATE WITH THE OWNER'S ATC CONTRACTOR AND ASSIST WITH THE ATC CONTRACTOR FOR CHILLER START-UP AND COMMISSIONING.

GENERAL MECHANICAL NOTES - WORKMANSHIP/COORDINATION

- ALL WORK SHALL BE PERFORMED IN A CLEAN AND WORKMANLIKE MANNER. CARE SHALL BE EXERCISED TO MINIMIZE ANY INCONVENIENCE OR DISTURBANCE TO OTHER AREAS OF THE BUILDING WHICH ARE TO REMAIN IN OPERATION. ISOLATE WORK AREAS BY MEANS OF TEMPORARY PARTITIONS AND/OR TARPS TO KEEP DUST AND DIRT WITHIN THE CONSTRUCTION AREA.
- NO PIPING, EQUIPMENT, ETC. SHALL BE REMOVED, DISCONNECTED OR SHUT DOWN WITHOUT PRIOR REVIEW WITH THE OWNER AND/OR ENGINEER TO CONFIRM THAT AREAS TO REMAIN IN OPERATION WILL NOT BE AFFECTED. IF ANY AREAS NOT WITHIN THE SCOPE OF WORK ARE AFFECTED BY ANY SHUTDOWN, REMOVAL OR DISCONNECTION, SUFFICIENT ADVANCE NOTICE MUST BE GIVEN TO THE OWNER INDICATING WHICH AREAS WILL BE AFFECTED, WHEN THE PROPOSED SHUTDOWN WILL OCCUR, AND FOR HOW LONG A PERIOD OF TIME.
- ALL ITEMS REMOVED SHALL BECOME PROPERTY OF THE OWNER AND SHALL BE DISPOSED OF AS PER THE OWNER'S INSTRUCTIONS, UNLESS INDICATED OTHERWISE. ALL ITEMS WHICH ARE NOT TO BE STORED ON SITE BY OWNERS SHALL BE REMOVED AND DISPOSED OF BY THE CONTRACTOR.
- THIS CONTRACTOR SHALL FIELD VERIFY ALL DIMENSIONS AND EXISTING CONDITIONS PRIOR TO PROCEEDING WITH ANY WORK. WHERE DISCREPANCIES OCCUR BETWEEN THESE DOCUMENTS AND EXISTING CONDITIONS, THE DISCREPANCY SHALL BE REPORTED TO THE OWNER AND/OR ENGINEER FOR EXPEDITING AND RESOLVE.
- ALL SHUT DOWNS OF EXISTING SYSTEMS SHALL BE SCHEDULED AND APPROVED BY THE OWNER PRIOR TO COMMENCING WITH WORK.
- CLEAN THE JOB SITE DAILY AND REMOVE FROM THE PREMISES ANY DIRT AND DEBRIS CAUSED BY THE PERFORMANCE OF THE WORK INCLUDED IN THIS CONTRACT.
- USE OF THE OWNER'S ELEVATORS AND BUILDING CORRIDORS FOR HANDLING OF THE OWNER AND REMOVED EQUIPMENT AND MATERIALS SHALL BE AT THE DIRECTION OF THE OWNER AND SHALL BE COORDINATED WITH HIS OPERATIONS.
- THE CONTRACTOR SHALL BE RESPONSIBLE FOR THE SAFEKEEPING OF HIS OWN PROPERTY ON THE JOB SITE. OWNER ASSUMES NO RESPONSIBILITY FOR PROTECTION OF PROPERTIES AGAINST FIRE, THEFT AND ENVIRONMENTAL CONDITIONS.
- SUCCESSFULLY PRESSURE TEST ALL PIPING SYSTEMS. TEST SHALL BE PERFORMED AT NORMAL SYSTEM OPERATING PRESSURES. REPAIR AND RETEST AS REQUIRED UNTIL SYSTEMS PROVE TIGHT.
- EXISTING MATERIALS THAT ARE REMOVED SHALL NOT BE REUSED IN NEW SYSTEMS, EXCEPT WHERE INDICATED AS BEING RELOCATED.
- PROVIDE ALL NECESSARY TEMPORARY OR PERMANENT CAPS OR PLUGS FOR PIPING. DO NOT LEAVE PIPING OPEN ENDED.
- WHERE USED, THE TERM 'PROVIDE' SHALL MEAN 'FURNISH AND INSTALL'.
- THIS CONTRACTOR SHALL COORDINATE HIS WORK WITH ALL OTHER TRADES PRIOR TO FABRICATION, PURCHASE AND/OR INSTALLATION OF ALL WORK.
- MECHANICAL CONTRACTOR SHALL COORDINATE ELECTRICAL REQUIREMENT OF ANY EQUIPMENT WITH G.C. AND ELECTRICAL CONTRACTOR PRIOR TO ROUGH-IN.
- THE CONTRACTOR SHALL REFER TO PROJECT SPECIFICATIONS FOR ANY ADDITIONAL PROJECT REQUIREMENTS

FIRE STOPPING NOTES


ALL PIPES, DUCTS, CONDUITS AND CABLES PASSING THROUGH RATED FLOORS/WALLS/CEILINGS SHALL BE FIRE STOPPED WITH 3M FIRE BARRIER CAULK CP 25 OR EQUAL. INSTALL PER MANUFACTURER'S INSTRUCTIONS AND TO SATISFY THE FIRE RATING REQUIREMENTS OF THE ASSEMBLY.

- | | |
|---------------------------|---|
| 1) ELEVATOR MACHINE ROOM | 2 HOUR FIRE RATING FOR WALLS AND CEILING, UNLESS NOTED OTHERWISE ON THE PLANS |
| 2) MECHANICAL ROOM | 1 HOUR FIRE RATING FOR WALLS AND CEILING, UNLESS NOTED OTHERWISE ON THE PLANS |
| 3) STAIR TOWER | 2 HOUR FIRE RATING, UNLESS NOTED OTHERWISE ON THE PLANS |
| 4) OTHER FIRE SEPARATIONS | PROVIDE TO MATCH ASSEMBLY RATING INDICATED ON THE PLANS OR REQUIRED BY CODE. |

MECHANICAL DRAWING LIST

- M-0.0 MECHANICAL COVER SHEET
- M-1.0 MECHANICAL ROOF PLAN
- M-1.1 MECHANICAL SCHEDULES
- M-2.0 MECHANICAL SCHEDULES AND DETAILS

L.S. GRIM, INC.
Consulting Engineers
 MAIN OFFICE: HAGERSTOWN, MD 21742-1387
 PROJECT OFFICE: HAGERSTOWN, MD 21742-1387
 PHONE: 410-326-1100
 PHONE TOLL FREE: 1-888-797-GRIM (4746)
 D.C. METRO OFFICE: 2275 RESEARCH BLVD., SUITE 500, ROCKVILLE, MD 20850
 © 2022 L.S. GRIM, INC. & LESLIE S. GRIM, P.E.

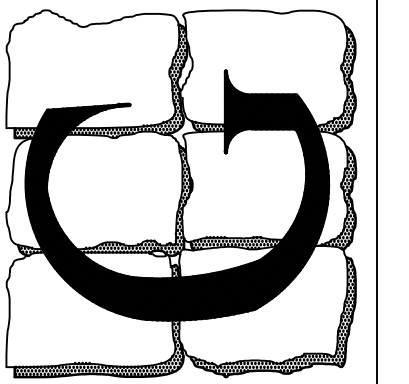

CIRCUIT COURT
CHILLER REPLACEMENT
24 SUMMIT AVE HAGERSTOWN, MD 21740
MECHANICAL COVER SHEET


Professional Certification
 I certify that these documents were prepared or approved by me, and that I am a duly licensed engineer under the laws of the State of Maryland.
 License Number: 14401
 Expiration Date: 4/21/2025

LESLIE SCOTT GRIM, P.E.
 CD PROF. ENG. NO. PE0050461
 DC PROF. ENG. NO. PE90201
 DE PROF. ENG. NO. 19513
 GA PROF. ENG. NO. PE032682
 HI PROF. ENG. NO. PE13043
 MD PROF. ENG. NO. 14401
 NJ PROF. ENG. NO. 033364
 NY PROF. ENG. NO. 38497
 NV PROF. ENG. NO. 075414
 PA PROF. ENG. NO. PE032636E
 VA PROF. ENG. NO. 023240
 WV PROF. ENG. NO. 10764

REV.	DATE	COMMENT
	5/11/23	BID/ PERMIT SET

DRAWN BY: LBG

M-0.0
2 OF 8 SHEETS
 DATE: MAY 11, 2023

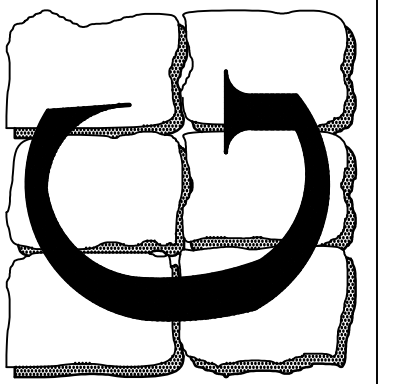


Professional Certification
 I certify that these documents were prepared or approved by me, and that I am a duly licensed engineer under the laws of the State of Maryland.
 License Number: 14401
 Expiration Date: 4/21/2025

LESLIE SCOTT GRIM, P.E.
 CO. PROF. ENG. NO. PE0050461
 DC. PROF. ENG. NO. PE90201
 DE. PROF. ENG. NO. 19513
 GA. PROF. ENG. NO. PE032682
 HI. PROF. ENG. NO. PE13043
 MD. PROF. ENG. NO. 14401
 NY. PROF. ENG. NO. 033364
 NJ. PROF. ENG. NO. 38497
 NV. PROF. ENG. NO. 075414
 PA. PROF. ENG. NO. PE032636E
 VA. PROF. ENG. NO. 022440
 WV. PROF. ENG. NO. 10764


REV.	DATE	COMMENT
	5/11/23	BID/ PERMIT SET

DRAWN BY: **LBO**

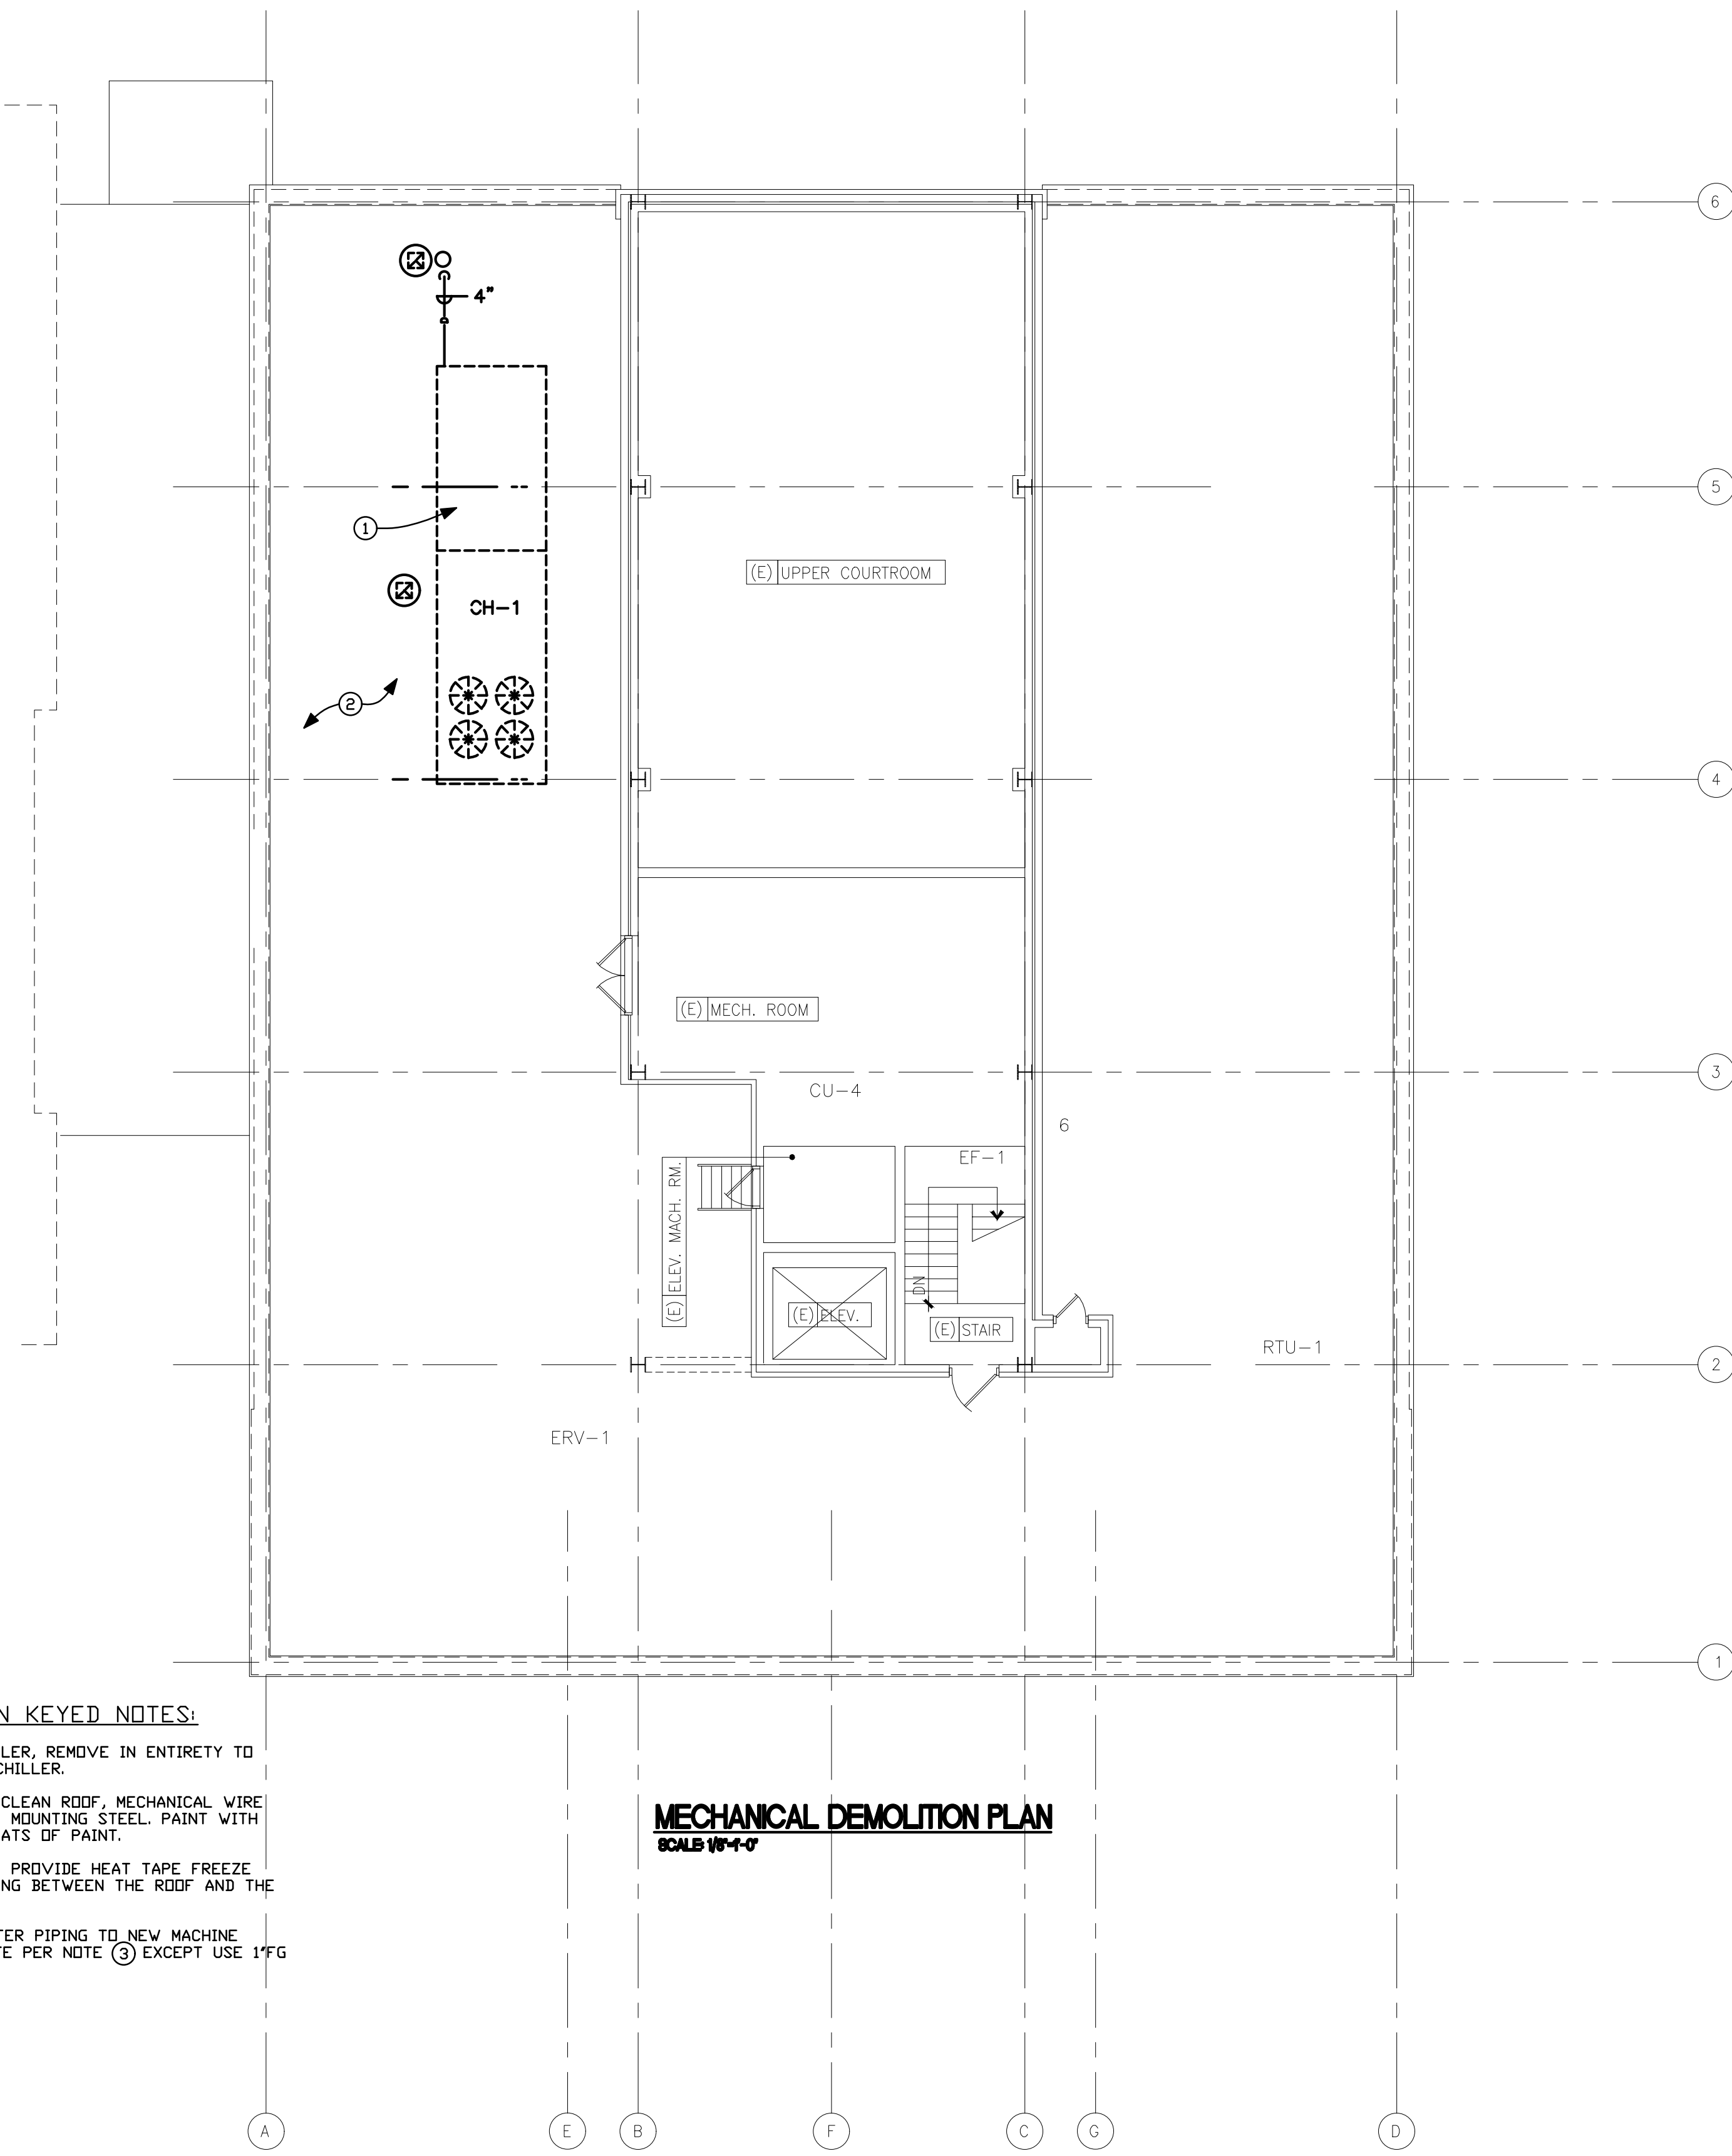


MECHANICAL DEMOLITION PLAN
 SCALE 1/4"=1'-0"

- MECHANICAL PLAN KEYED NOTES:**
- EXISTING A/C CHILLER, REMOVE IN ENTIRETY TO ACCOMMODATE NEW CHILLER.
 - CONTRACTOR SHALL CLEAN ROOF, MECHANICAL WIRE BRUSH AND EXPOSED MOUNTING STEEL. PAINT WITH PRIMER AND TWO COATS OF PAINT.
 - CONTRACTORS SHALL PROVIDE HEAT TAPE FREEZE PROTECTION OF PIPING BETWEEN THE ROOF AND THE CHILLER MACHINE.
 - EXTEND MAKEUP WATER PIPING TO NEW MACHINE PENTHOUSE, INSULATE PER NOTE ③ EXCEPT USE 1"FG INSULATION

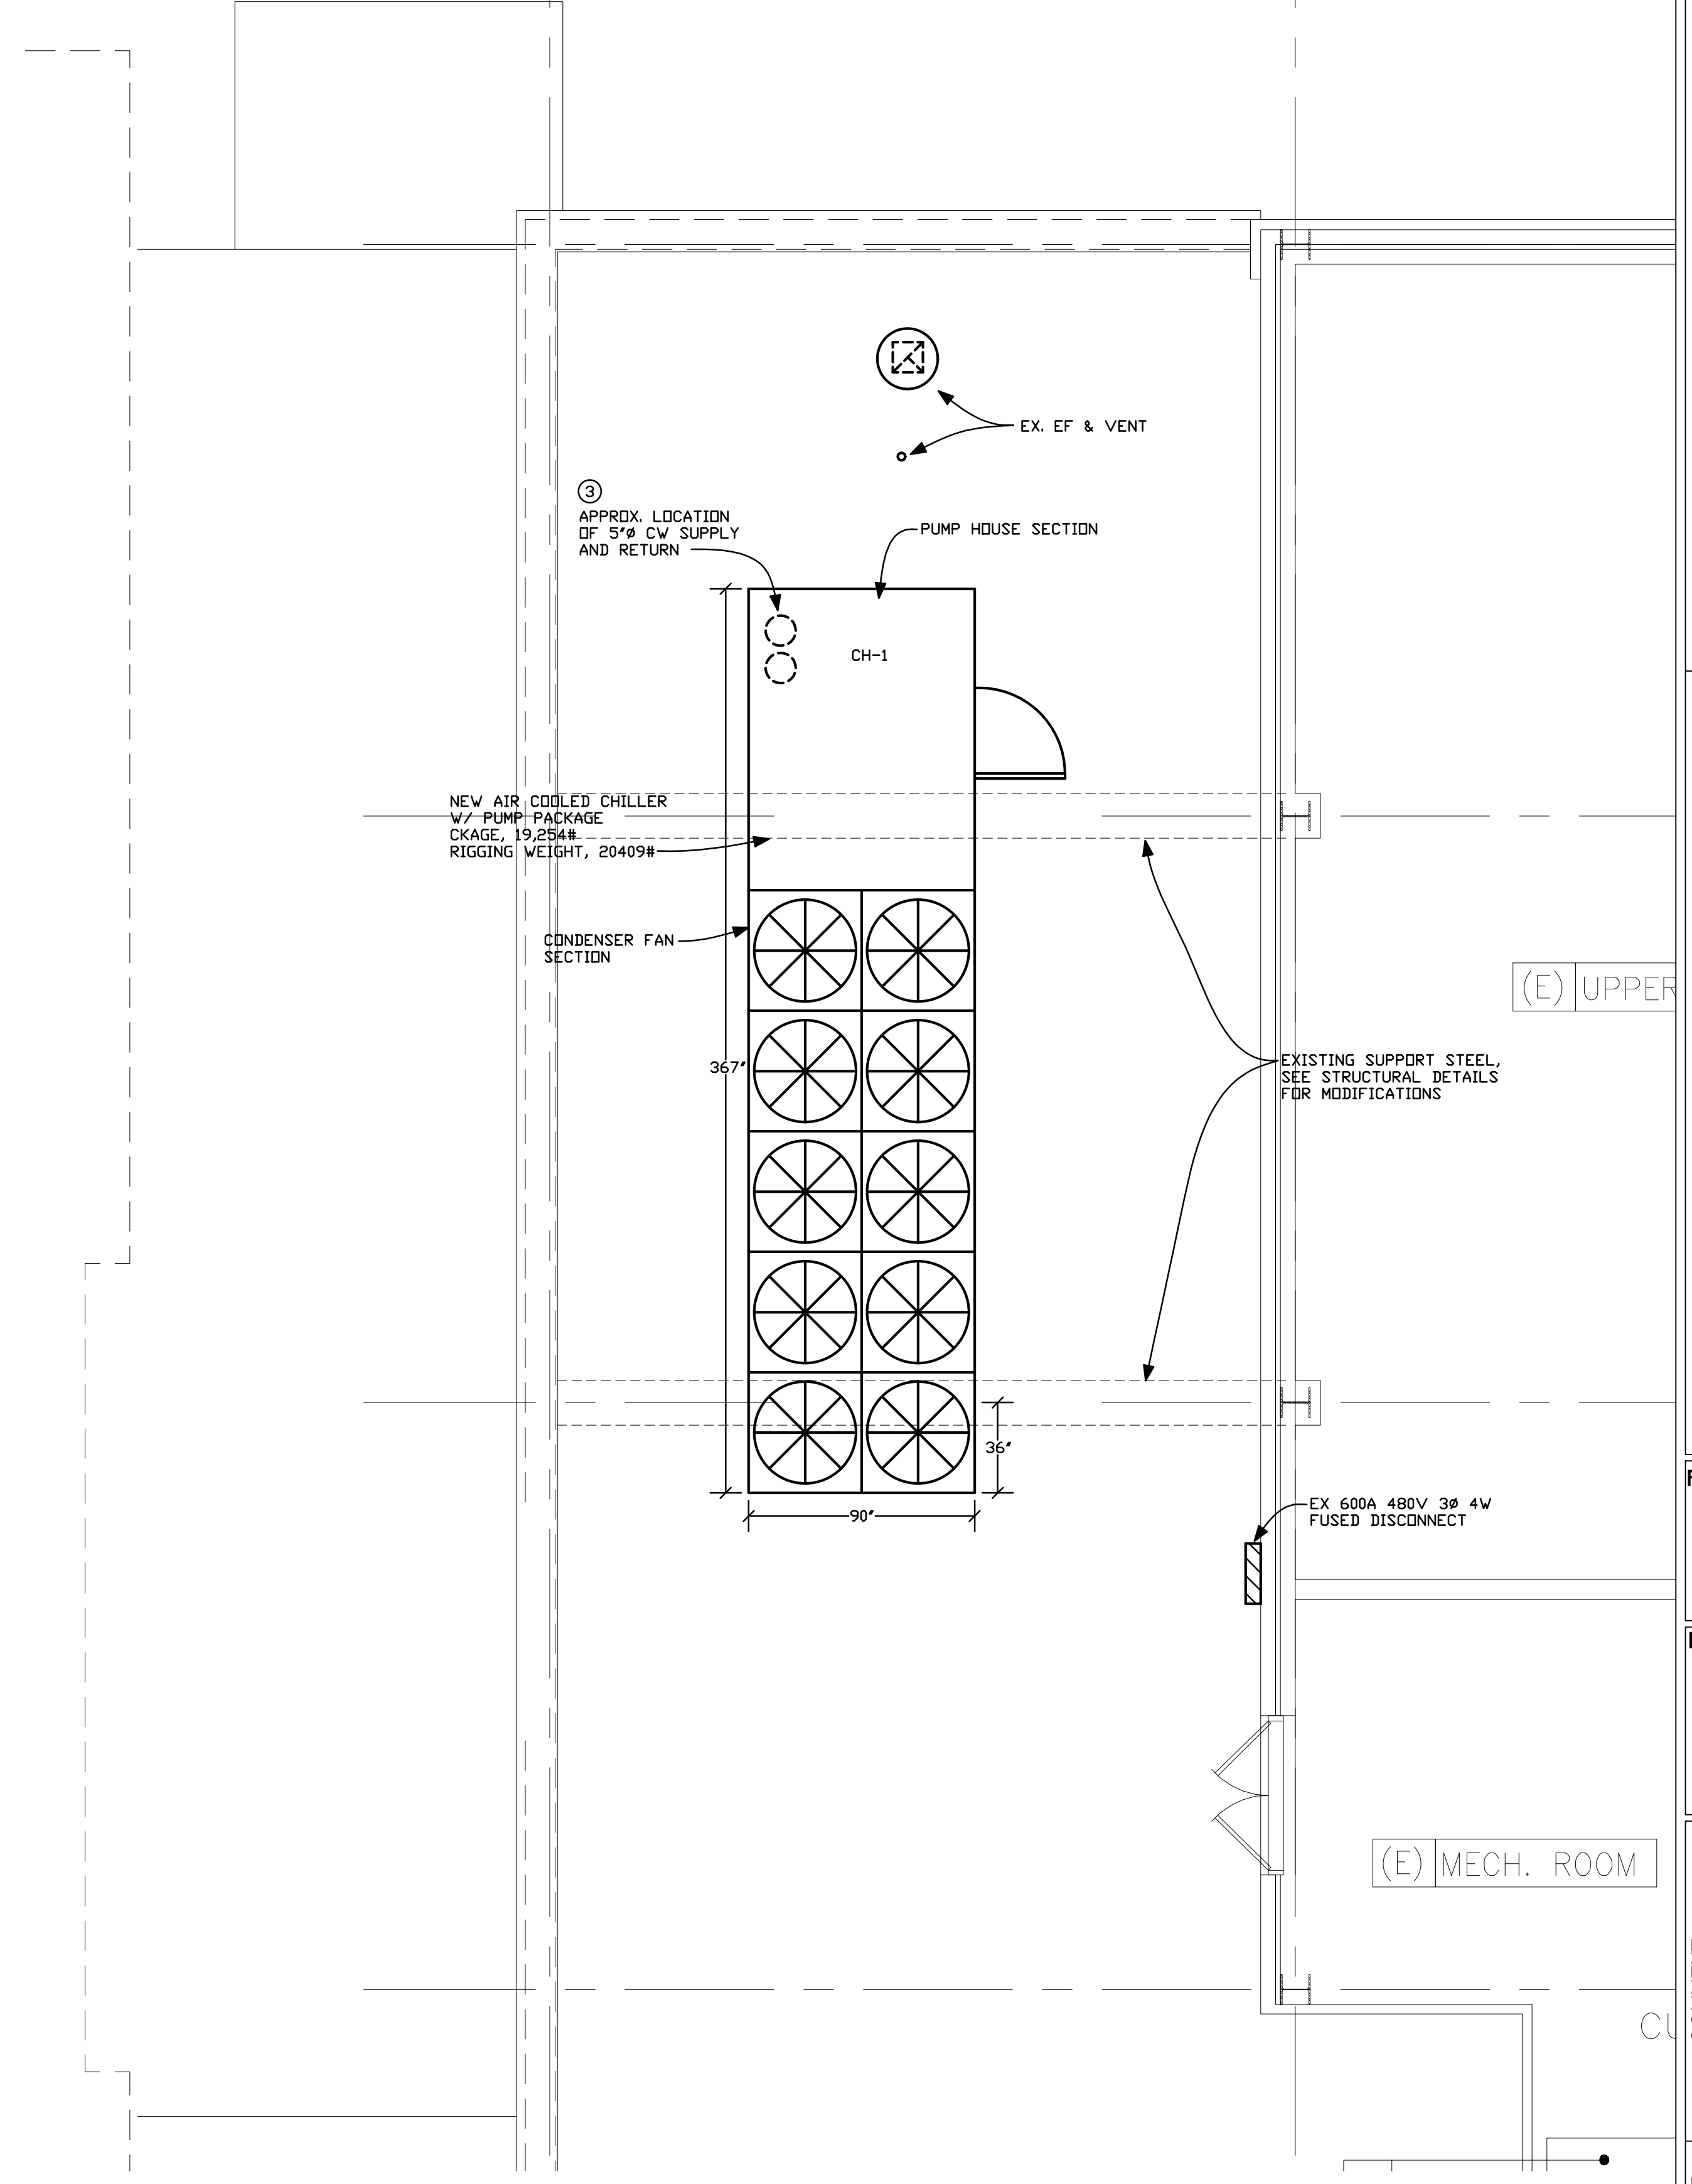

NEW WORK PART PLAN
 SCALE 1/4"=1'-0"

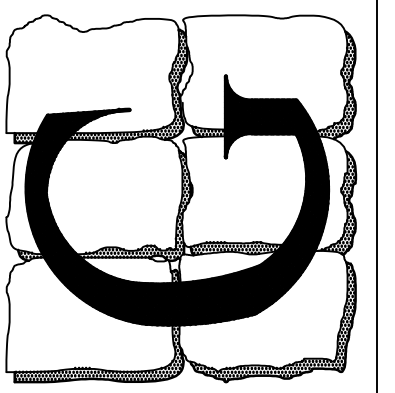

Professional Certification I certify that these documents were prepared or approved by me, and that I am a duly licensed engineer under the laws of the State of Maryland License Number: 14401 Expiration Date: 4/21/2025

LESLIE SCOTT GRIM, P.E. CO. PROF. ENG. NO. PE0050461 DC. PROF. ENG. NO. PE001201 DE. PROF. ENG. NO. 19513 GA. PROF. ENG. NO. PE015682 HI. PROF. ENG. NO. PE13043 MD. PROF. ENG. NO. 14401 NY. PROF. ENG. NO. 033364 NJ. PROF. ENG. NO. 38497 NV. PROF. ENG. NO. 075414 PA. PROF. ENG. NO. PE032636 VA. PROF. ENG. NO. 022240 WV. PROF. ENG. NO. 10764

Table with columns: REV., DATE, COMMENT, BID/ PERMIT SET

YORK fisen YVAA JCI Air Cooled Screw Chiller Date: 5/5/2022 Order No: BODF-01 Page: 1-1 Ver. 1.0

Unit Tag CH-1 Qty 1 Model No. YVAA0183AOV46BHVBXX Capacity (Tons) 185.9 Volts/Ph/Hz 460/3/60 Refrigerant R-513A

Part Load Rating Data table with columns: Load %, Ambient (°F), Capacity (Tons), Total kW, Unit Efficiency

Estimated Sound Pressure Levels at 30 Feet table with columns: Load %, Ambient (°F), 63, 125, 250, 500, 1K, 2K, 4K, 8K, LpA

Piping Package Fluid Volume (gal) 95.3 Combined Fluid Volume (gal) 143.4 Piping Package Pressure Drop (ft) 4.6 Combined Fluid Pressure Drop(ft) 17.0

Electrical Data table with columns: Circuit, 1, 2, 3, 4

Single Point Connection table with columns: Circuit, #1, #2, #3, #4

YORK fisen YVAA JCI Air Cooled Screw Chiller Date: 5/5/2022 Order No: BODF-01 Page: 1-2 Ver. 1.0

Hydro Kit Data table with columns: Flow, Total Head, Fluid, Water, Impeller Diameter

Standard in accordance with the AHRI Air-Cooled Water-Chilling Packages Certification Program, which is based on AHRI Standard 550/590 (L-P) and AHRI Standard 551/591 (S).

Minimum and maximum evaporator flow information are for full load ratings with Propylene Glycol. Evaporator Passes: 2, Condenser Type: M, Fan Type: V

ASHRAE Standard 90.1-2010 and ASHRAE Standard 90.1-2013 & 2016 Compliant. IECC 2012 and IECC 2015/2018 Compliant.

* Use Copper Conductors only **Weight is +/- 10% (1) Pump power excluded from total kW

YORK fisen YVAA JCI Air Cooled Screw Chiller Date: 5/5/2022 Order No: BODF-01 Page: 1-3 Ver. 1.0

Part Load Rating Data table with columns: Load %, Ambient (°F), Capacity (Tons), Total kW, Unit Efficiency

Estimated Sound Pressure Levels at 30 Feet table with columns: Load %, Ambient (°F), 63, 125, 250, 500, 1K, 2K, 4K, 8K, LpA


** Chiller is assumed to be a point source on a reflecting surface (hemispherical radiation) ** Sound Data does not reflect final finisher options. Note: Unit is equipped with Low Sound Kit (Level 1 Reduction) with Variable Speed Control.

Performance at AHRI Conditions table with columns: Evaporator Data, Condenser Data, Performance Data

Note: Unit rated at design condition capacity.

YORK fisen YVAA JCI Air Cooled Screw Chiller Date: 5/5/2022 Order No: BODF-01 Page: 1-4 Ver. 1.0

Hydro Kit Data table with columns: Flow, Total Head, Fluid, Water, Impeller Diameter

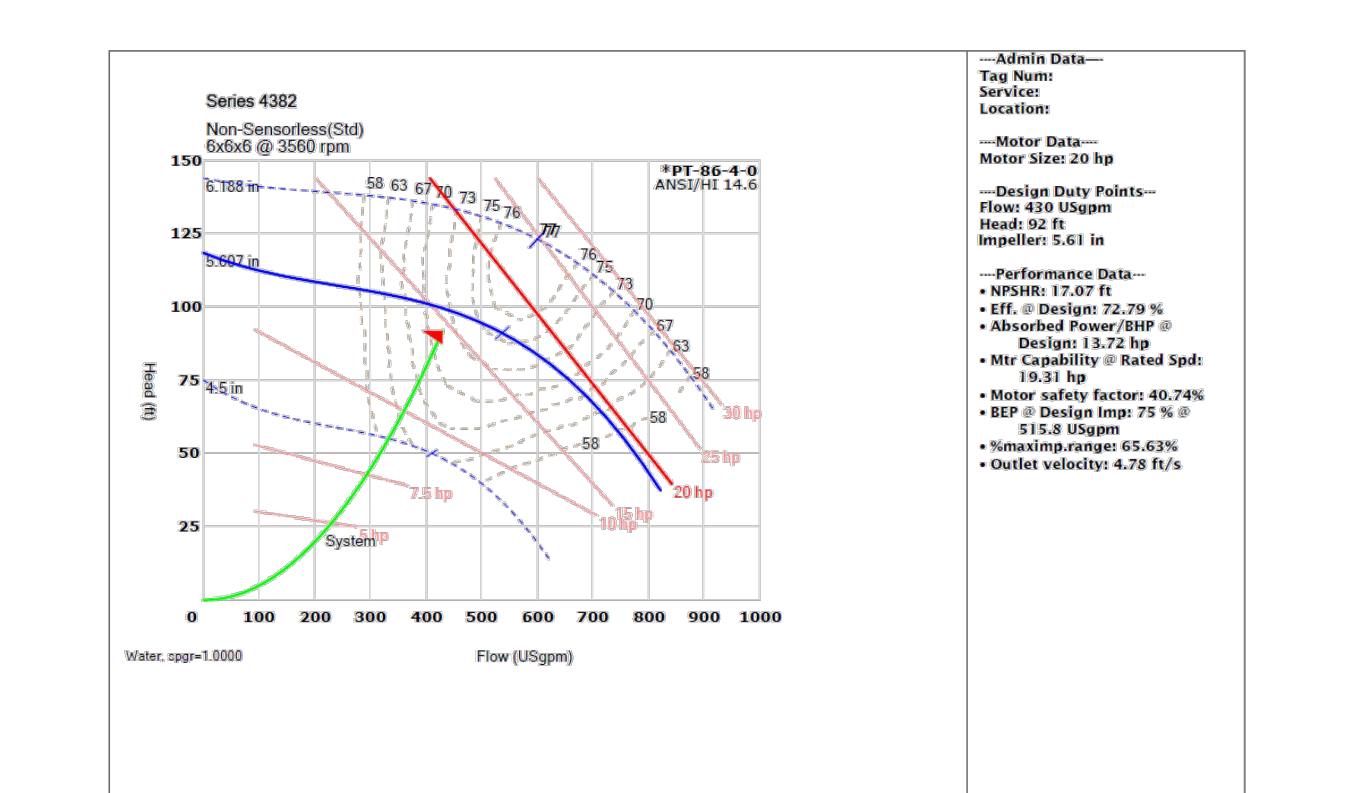

YORK fisen YVAA JCI Air Cooled Screw Chiller Date: 5/5/2022 Order No: BODF-01 Page: 1-5 Ver. 1.0


Factory Installed Options R513a SP Circuit Breaker w/Lockable Handle Connected Services Ready - BACnet/Modbus/N2 High Pressure Cut-off Switch (High Ambient) Actuated Suction Service Valves Optimized Part Load (IPLV) Efficiency

YORK fisen YVAA JCI Air Cooled Screw Chiller Date: 5/5/2022 Order No: BODF-01 Page: 1-6 Ver. 1.0

Fisen Installed Options (Refer to Construction Details for Additional Information) Enclosed Extension Solution Air Handling Unit Enclosure XTO Enclosure Construction Floor Drain Outdoor Air Intake Louver Exhaust Fan Ventilation Package

YORK fisen YVAA JCI Air Cooled Screw Chiller Date: 5/5/2022 Order No: BODF-01 Page: 1-7 Ver. 1.0

Field Installed Accessories Only items marked ** are provided by Fisen One Differential Pressure Switch per Chiller Vibration Isolation Must be sized for revised weights.

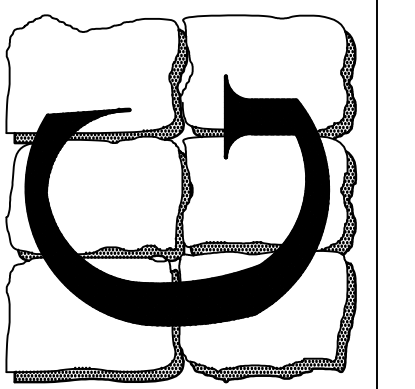


Professional Certification
 I certify that these documents were prepared or approved by me, and that I am a duly licensed engineer under the laws of the State of Maryland.
 License Number: 14401
 Expiration Date: 4/21/2025

LESLIE SCOTT GRIM, P.E.
 CO. PROF. ENG. NO. PE0050461
 DC. PROF. ENG. NO. PE901201
 DE. PROF. ENG. NO. 19513
 GA. PROF. ENG. NO. PE013062
 HI. PROF. ENG. NO. PE13043
 MD. PROF. ENG. NO. 14401
 NJ. PROF. ENG. NO. 033364
 NY. PROF. ENG. NO. 39497
 VA. PROF. ENG. NO. 075414
 PA. PROF. ENG. NO. PE032636E
 WV. PROF. ENG. NO. 023240
 WV. PROF. ENG. NO. 10764

REV.	DATE	COMMENT
	5/11/23	BID/ PERMIT SET

DRAWN BY: LBG

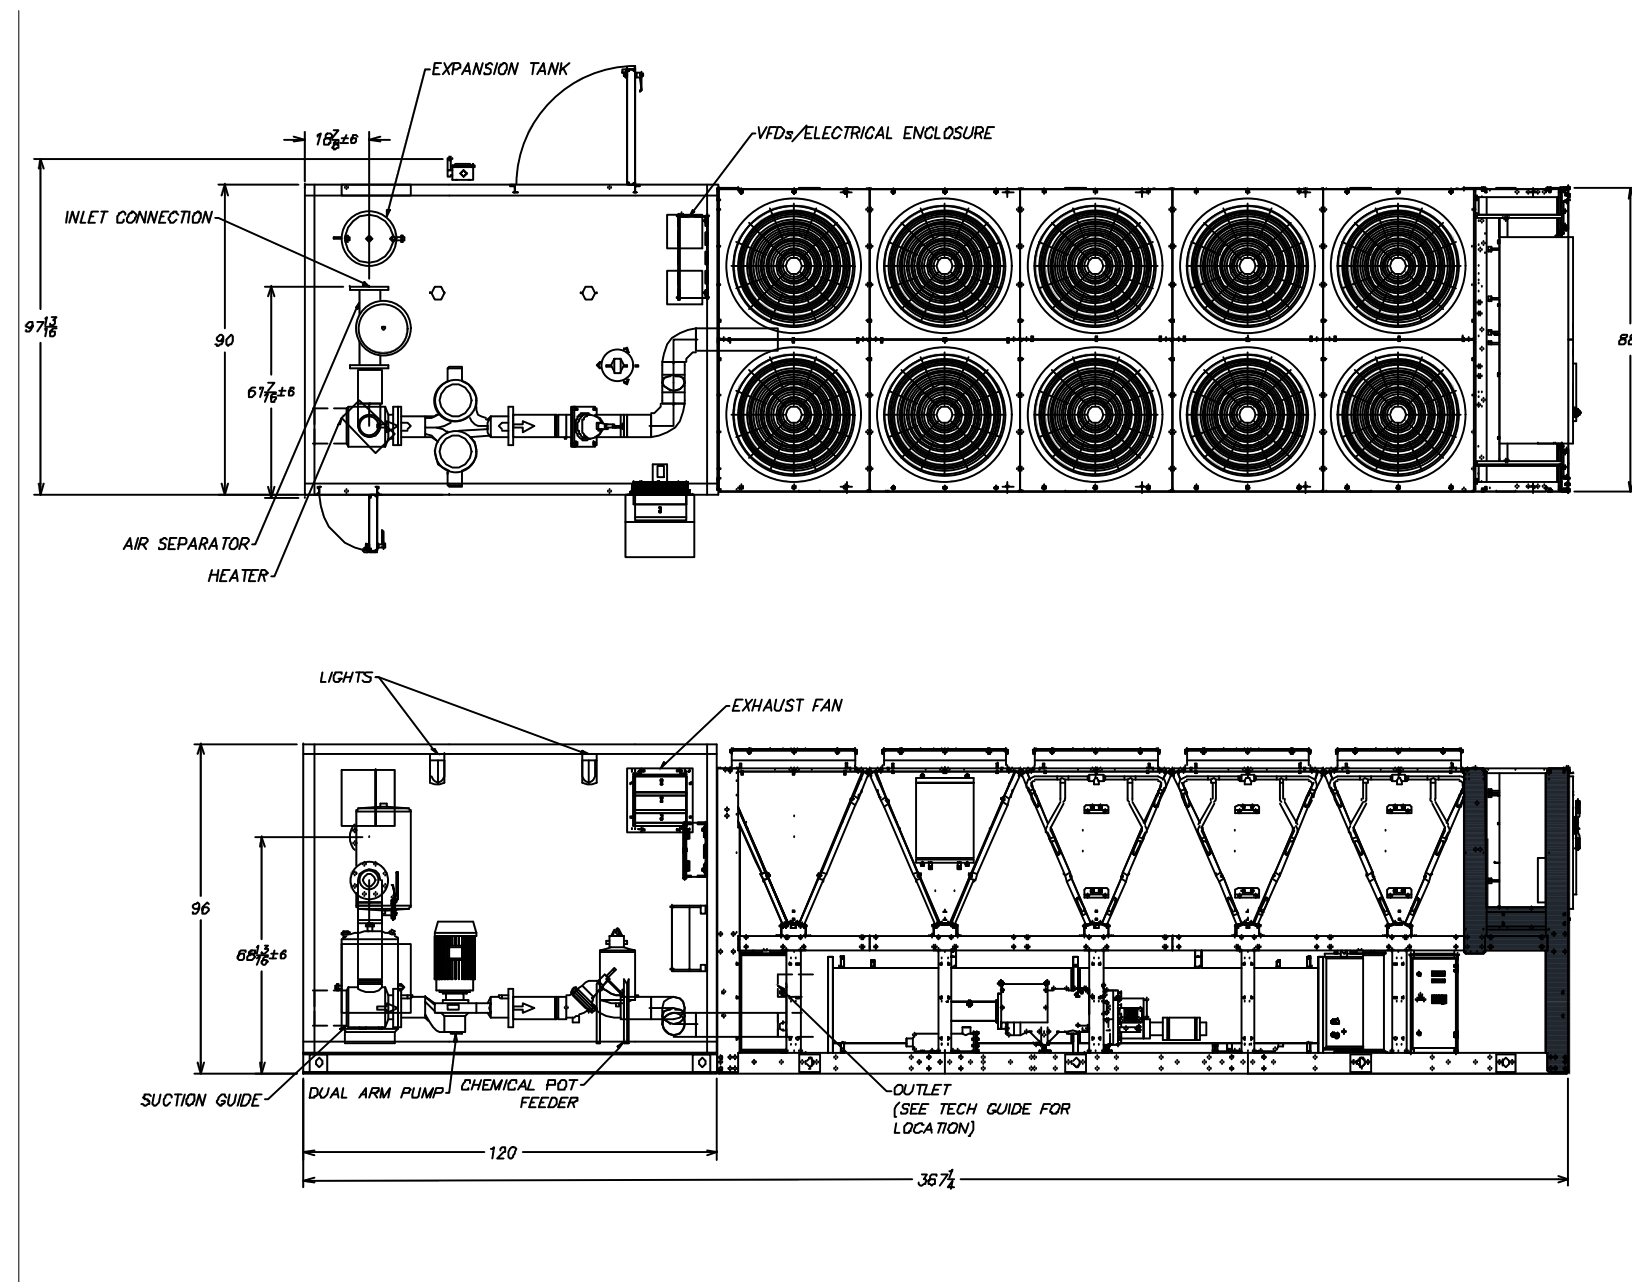

YORK fisen **YVAA** Date: 5/5/2022 Page: 1-10
 JCI Air Cooled Screw Chiller Order No: BODF-01 Ver. 1.0
 Project Name: Washington County Courthouse Model No: YVAA0183AOV46BHVBXX
 Quantity: 1 Tag #: CH-1

Sequence of Operation

Chilled Water Pump and Variable Frequency Drive
 The pump and variable frequency drive are provided without controls or programming. All controls and programming required for proper operation of the pump shall be provided by others.

Enclosure Heater
 An electric heater installed in the enclosure will turn on when the temperature falls below adjustable setpoint from wall mounted thermostat. When temperature rises above setpoint, the heater shall be disabled.

Enclosure Exhaust Fan
 An exhaust fan mounted in the enclosure shall enable if enclosure temperature rises above setpoint. When temperature falls below setpoint, the exhaust fan shall be disabled. Backdraft damper on the outdoor air louver shall open when fan is on.

YORK fisen **YVAA** Date: 5/5/2022 Page: 1-11
 JCI Air Cooled Screw Chiller Order No: BODF-01 Ver. 1.0
 Project Name: Washington County Courthouse Model No: YVAA0183AOV46BHVBXX
 Quantity: 1 Tag #: CH-1

Valve Schedule¹

Valve Tag	Style	Size ²	Configuration	Notes
BV1	Full Port Ball Valve	1"	NC	Lever Operated
BV2	Full Port Ball Valve	1"	NO	Lever Operated
BV3	Full Port Ball Valve	3/4"	NC	Lever Operated
BV4	Full Port Ball Valve	3/4"	NC	Lever Operated
BV5	Full Port Ball Valve	3/4"	NC	Lever Operated
BV6	Full Port Ball Valve	3/4"	NC	Lever Operated
TDV1	Discharge Combination Valve	6"	Field Set	Tool Operated
PRV1	Pressure Reducing Valve	1/2"	NO	Dial-Up Pressure Setting
HB	Hose Bibb	1/2"	NC	

Notes:
 1. Schedule only indicates valves typically added by Fisen. Additional items may and do exist as provided by JCI and Fisen.
 2. Sizing is typical and will be validated at time of fabrication. Refer to IOM, As Built drawings, and/or hydronic prints for final sizing data.
 3. Provided by JCI on some units. Installed by Fisen on others. May not be installed on all units.

YORK fisen **YVAA** Date: 5/5/2022 Page: 1-12
 JCI Air Cooled Screw Chiller Order No: BODF-01 Ver. 1.0
 Project Name: Washington County Courthouse Model No: YVAA0183AOV46BHVBXX
 Quantity: 1 Tag #: CH-1


Hydronic Specialty Schedule¹

Item Tag	Style/Description	Size ²	Configuration	Notes
DAP1	Close-Coupled Vertical In-Line DualArm Pump	20 hp	6"x6"x6"	
XT1	Expansion Tank	25 Gal		
AS1	Air Separator	6"		
CPF	Chemical Pot Feeder	5 Gal		

Notes:
 1. Schedule only indicates hydronic specialties typically added by Fisen. Additional items may and do exist as provided by JCI and Fisen.
 2. Sizing is typical and will be validated at time of fabrication. Refer to IOM, As Built drawings, and/or hydronic prints for final sizing data.
 3. Provided by JCI on some units. Installed by Fisen on others. May not be installed on all units.

YORK fisen **YVAA** Date: 5/5/2022 Page: 1-13
 JCI Air Cooled Screw Chiller Order No: BODF-01 Ver. 1.0
 Project Name: Washington County Courthouse Model No: YVAA0183AOV46BHVBXX
 Quantity: 1 Tag #: CH-1

Hydronic Flow Diagram

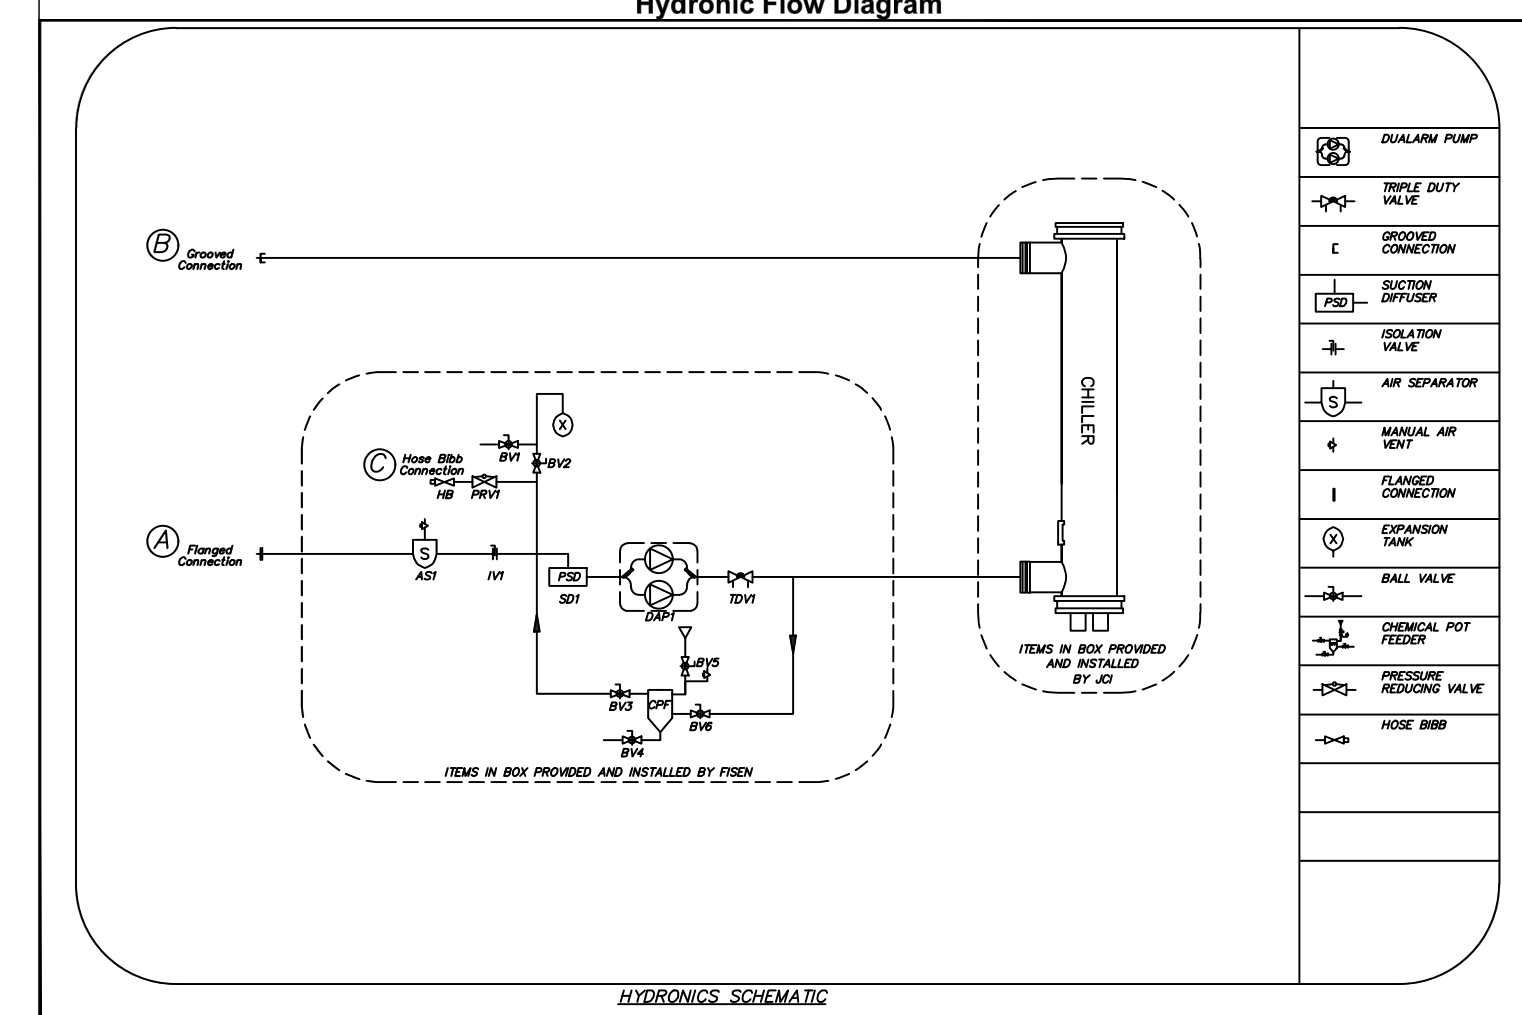


Piping Connections


Connection	Designation	Size
Inlet	A	6"
Outlet	B	6"

YORK fisen **YVAA** Date: 5/5/2022 Page: 1-17
 JCI Air Cooled Screw Chiller Order No: BODF-01 Ver. 1.0
 Project Name: Washington County Courthouse Model No: YVAA0183AOV46BHVBXX
 Quantity: 1 Tag #: CH-1

Rigging and Weight Distribution

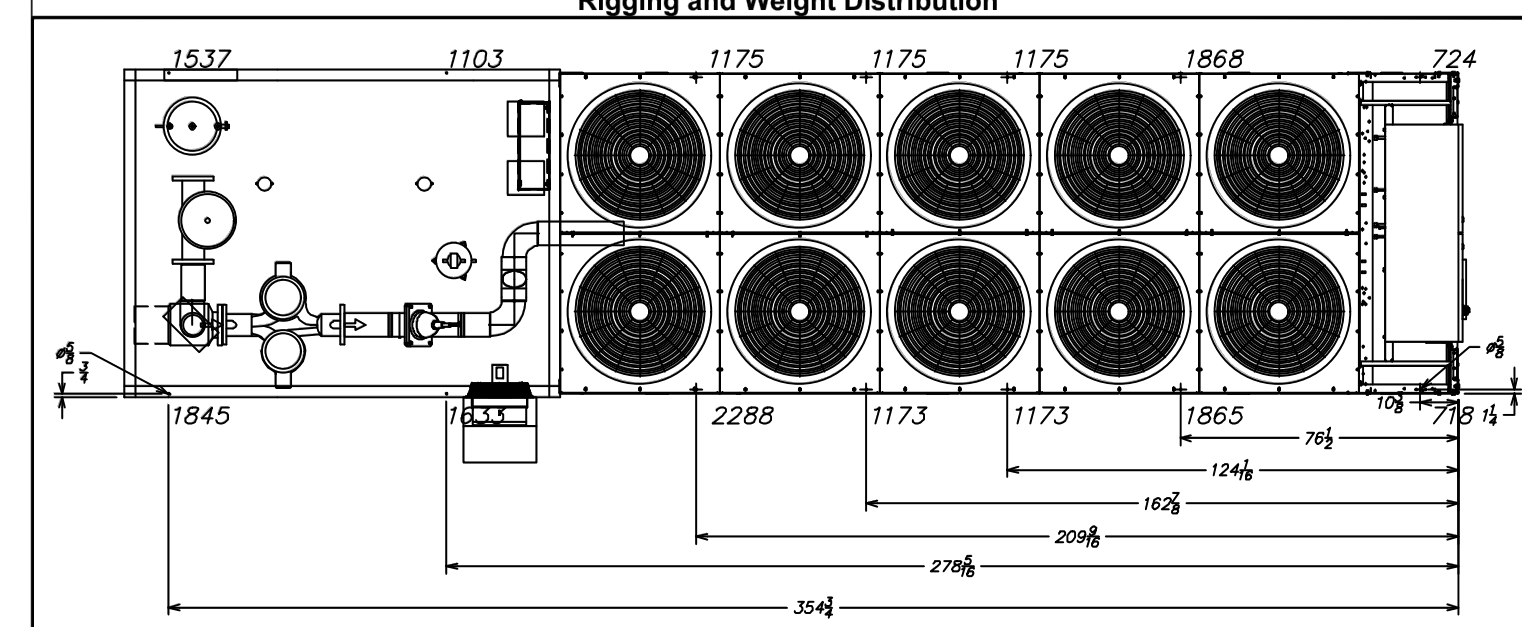

Rigging Locations

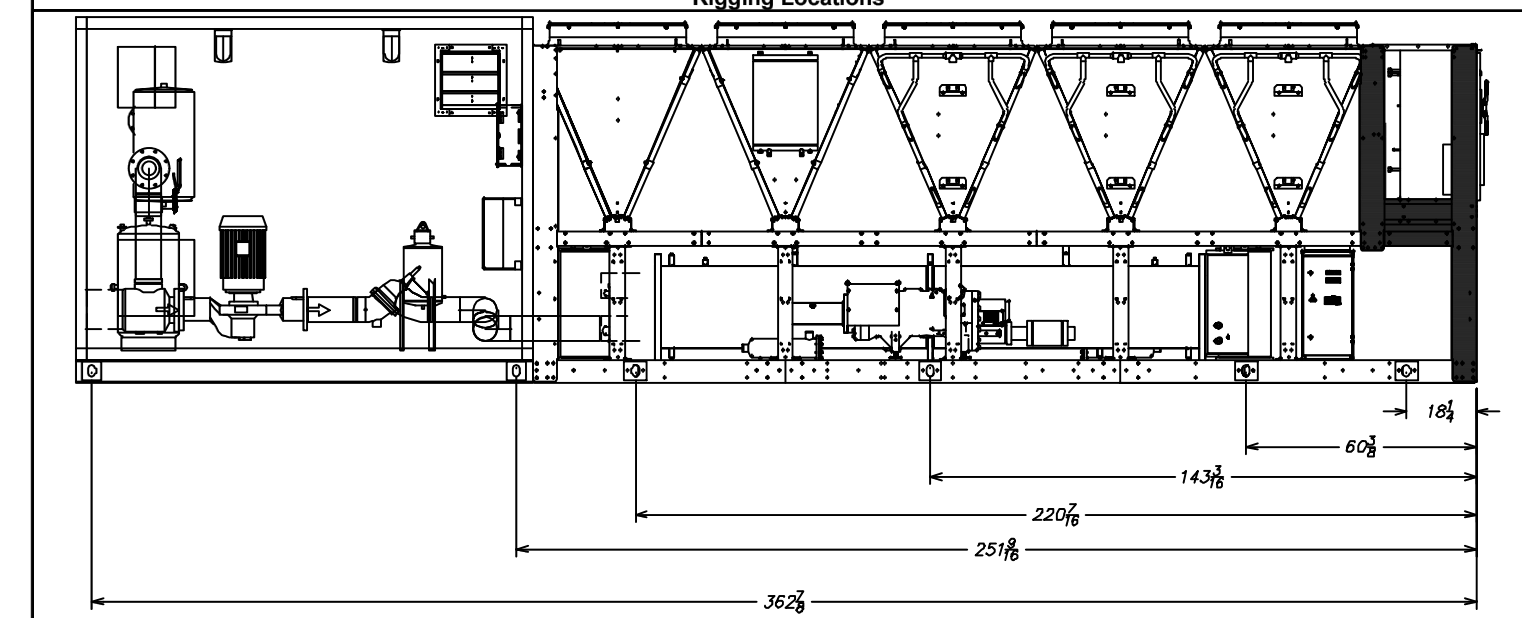

GENERAL ELECTRICAL NOTES

- MATERIALS, EQUIPMENT, AND SYSTEMS SHALL MEET ALL PERTINENT REQUIREMENTS OF THE AMERICAN SOCIETY FOR TESTING MATERIALS (ASTM), 2017-NATIONAL-ELECTRIC-CODE (N.E.C.), THE UNDERWRITERS LABORATORY (UL), THE NATIONAL ELECTRIC MANUFACTURER'S ASSOCIATION (NEMA), NATIONAL FIRE PROTECTION ASSOCIATION (NFPA), AMERICAN NATIONAL STANDARDS INSTITUTE (ANSI), AND OTHER NATIONALLY RECOGNIZED AGENCIES AS WELL AS APPLICABLE LOCAL CODES.
- ANYTHING DRAWN OR SPECIFIED SHALL NOT BE CONSTRUED TO CONFLICT WITH ANY LOCAL, MUNICIPAL OR STATE LAW, REGULATION OR ORDINANCE WHICH GOVERNS THE INSTALLATION OF ANY ELECTRICAL OR RELATED WORK. ITEMS SHALL NOT BE INSTALLED IN CONFLICT WITH THE N.E.C. RESOLVE ANY AND ALL CONFLICTS BEFORE INSTALLATION AT NO ADDITIONAL EXPENSE TO THE OWNER.
- ALL ELECTRICAL EQUIPMENT SHALL BE LISTED AND LABELED FOR THE QUALIFIED USE. VERIFY CIRCUIT BREAKER INTERRUPT CAPACITY NEEDED FOR EACH PANEL WITH LOCAL UTILITY. FOR BID PURPOSES, ASSUME 65,000 AIC FOR SERVICE ENTRANCE EQUIPMENT, AND 25,000 AIC ELSEWHERE. BALANCE THE POWER EQUALLY (+/- 10%) ON ALL PHASES.
- THE SYSTEMS SHOWN ON DRAWINGS SHALL BE PROVIDED TO SERVE ALL FIXTURES, EQUIPMENT, AND AREAS WITHIN THE CONTRACT LIMIT LINES AS SET FORTH BY THE ARCHITECTURAL SOLUTION FOR THE PROJECT. THE BIDDING AND CONTRACT REQUIREMENTS, GENERAL REQUIREMENTS, AND GENERAL PROVISIONS SHALL APPLY TO THIS SECTION. SYSTEMS SHALL INCLUDE ALL EQUIPMENT, APPURTENANCES, SAFETY DEVICES, AND CONTROLS NECESSARY FOR THE INTENDED SERVICE.
- ALL PERMITS AND FEES REQUIRED FOR THE WORK SHALL BE SECURED AND PAID FOR BY THE ELECTRICAL CONTRACTOR AND INCLUDED IN BID PRICE.
- WHERE JOB CONDITIONS REQUIRE CHANGES FROM THE CONTRACT DOCUMENTS THAT DO NOT CHANGE THE SCOPE OF INSTALLATION OR NATURE OF WORK REQUIRED, THE CONTRACTOR SHALL MAKE SUCH CHANGES WITHOUT ADDITIONAL COST TO THE OWNER. NO OTHER CHANGES MAY BE MADE WITHOUT WRITTEN PERMISSION OF THE OWNER.
- BIDDERS SHALL BE LICENSED CONTRACTORS IN ACCORDANCE WITH LOCAL AND STATE LAWS.
- ALL EQUIPMENT SHALL BE NEW AND UNUSED. ALL EQUIPMENT SHALL BE INSTALLED IN STRICT CONFORMANCE TO MANUFACTURER'S RECOMMENDATIONS, EXCEPT WHERE THESE SPECIFICATIONS REQUIRE A HIGHER QUALITY INSTALLATION THAN RECOMMENDED BY THE MANUFACTURER.
- ALL INSTALLED SYSTEMS, DEVICES AND RELATED ITEMS SHALL BE TESTED IN PLACE ON SITE. REPLACE ANY AND ALL CONTRACTOR-SUPPLIED DEFECTIVE DEVICES, ITEMS OR SYSTEMS AT CONTRACTOR'S OWN EXPENSE BEFORE COMPLETION OF THE PROJECT.
- CONTRACTOR SHALL GUARANTEE ALL WORK FOR WHICH MATERIALS ARE FURNISHED, FABRICATED OR FIELD ERRECTED, ALL FACTORY ASSEMBLED EQUIPMENT FOR WHICH NO SPECIFIC MANUFACTURER'S GUARANTEE IS FURNISHED, AND ALL WORK IN CONNECTION WITH INSTALLING MANUFACTURER'S GUARANTEED EQUIPMENT. THIS CONTRACTOR'S GUARANTEE SHALL EXIST FOR A PERIOD OF ONE (1) YEAR FROM THE DATE OF FINAL OWNER ACCEPTANCE OF THE WORK AND SHALL APPLY TO DEFECTS IN MATERIAL AND TO DEFECTIVE WORKMANSHIP OF ANY KIND.
- VERIFY FINAL LOCATIONS FOR ROUGH-INS WITH FIELD MEASUREMENTS AND WITH THE REQUIREMENTS OF THE ACTUAL EQUIPMENT TO BE CONNECTED. VERIFY ALL DIMENSIONS BY FIELD MEASUREMENTS.
- SEQUENCE, COORDINATE, AND INTEGRATE INSTALLATIONS OF ELECTRICAL MATERIALS AND EQUIPMENT FOR EFFICIENT FLOW OF THE WORK. GIVE PARTICULAR ATTENTION TO LARGE EQUIPMENT REQUIRING POSITIONING PRIOR TO CLOSING-IN THE BUILDING. COORDINATE THE CUTTING AND PATCHING OF BUILDING COMPONENTS TO ACCOMMODATE INSTALLATION OF ELECTRICAL EQUIPMENT AND MATERIALS.
- COORDINATE THE INSTALLATION OF ELECTRICAL MATERIALS AND EQUIPMENT ABOVE CEILINGS WITH SUSPENSION SYSTEM, MECHANICAL EQUIPMENT AND SYSTEMS, AND STRUCTURAL COMPONENTS. COORDINATE ELECTRICAL EQUIPMENT AND MATERIALS INSTALLATION WITH OTHER BUILDING COMPONENTS.
- WHERE MOUNTING HEIGHTS ARE NOT DETAILED OR DIMENSIONED, INSTALL ELECTRICAL SERVICES AND OVERHEAD EQUIPMENT TO PROVIDE THE MAXIMUM HEADROOM POSSIBLE. INSTALL ELECTRICAL EQUIPMENT TO FACILITATE MAINTENANCE AND REPAIR OR REPLACEMENT OF EQUIPMENT COMPONENTS. AS MUCH AS PRACTICAL, CONNECT EQUIPMENT FOR EASE OF DISCONNECTING, WITH MINIMUM OF INTERFERENCE WITH OTHER INSTALLATIONS.
- COORDINATE CONNECTION OF ELECTRICAL SYSTEMS WITH EXTERIOR UNDERGROUND AND OVERHEAD UTILITIES AND SERVICES. COMPLY WITH REQUIREMENTS OF GOVERNING REGULATIONS, FRANCHISED SERVICE COMPANIES, AND CONTROLLING AGENCIES. PROVIDE REQUIRED CONNECTION FOR EACH SERVICE.
- DO NOT ENDANGER OR DAMAGE INSTALLED WORK THROUGH PROCEDURES AND PROCESSES OF CUTTING AND PATCHING. ARRANGE FOR REPAIRS REQUIRED TO RESTORE OTHER WORK, BECAUSE OF DAMAGE CAUSED AS A RESULT OF ELECTRICAL INSTALLATIONS.
- BIDDERS SHALL THOROUGHLY ACQUAINT THEMSELVES WITH THE CONDITIONS UNDER WHICH THE WORK IS TO BE PERFORMED. THEY SHALL EXAMINE ALL SERVICES, EQUIPMENT, SURFACES, ETC., WHICH THIS WORK IS IN ANY WAY DEPENDENT UPON, AND BRING ANY DISCREPANCIES DETERMINED OR OMISSIONS FOUND IN THE DRAWINGS TO THE OWNER'S ATTENTION BEFORE SUBMITTING BID.
- VERIFY MECHANICAL EQUIPMENT SWITCH AND CONNECTION REQUIREMENTS, ITEM BY ITEM, WITH THE MECHANICAL CONTRACTOR, BEFORE WIRING EQUIPMENT. RESOLVE ALL DISCREPANCIES WITHOUT FURTHER COST TO OWNER.
- ALL WIRING SHALL BE IN MC CABLE OR CONDUIT, 1/2" EMT MINIMUM WITH SET SCREW FITTINGS SUPPORTED AT 10'-0" INTERVALS.
- ALL WIRING SHALL BE THIN/THWN COPPER (NO. 12 AWG MINIMUM) UNLESS OTHERWISE NOTED. WIRE AND CONDUIT SIZES ARE SHOWN ON THE PANEL SCHEDULE.
- ALL LIGHTS SHALL BE SUPPORTED AND SECURED IN ACCORDANCE WITH MANUFACTURER'S RECOMMENDATIONS. THE SUPPORT SHALL BE FROM A BUILDING SUPPORT MEMBER AND NOT THE FIRE PROTECTION SYSTEM OR OTHER PIPES.
- ALL PANELS, CONTROL DEVICES AND MISCELLANEOUS ELECTRICAL APPARATUS SHALL BE CLEARLY MARKED FOR EASY IDENTIFICATION AND SAFETY. USE BLACK PLASTIC OR BAKELITE NAME PLATE ENGRAVED WITH WHITE LETTERS 1/4" HIGH. PUNCHED TAPE IS NOT ACCEPTABLE.
- PANELS SHALL BE PROVIDED WITH A TYPEWRITTEN DIRECTORY AFFIXED TO INSIDE OF PANEL DOOR WITH A CLEAR PLASTIC SLEEVE.
- THE ELECTRICAL DRAWINGS ARE DIAGRAMMATIC AND ARE FOR CIRCUIT ALLOCATION ONLY. DO NOT SCALE DRAWINGS.
- ELECTRICAL CONTRACTOR SHALL FURNISH RECORD SET OF DRAWINGS WITH ANY DEVIATIONS MARKED IN RED INK.

FIRE STOPPING NOTES

ALL PIPES, DUCTS, CONDUITS AND CABLES PASSING THROUGH RATED FLOORS/WALLS/CEILINGS SHALL BE FIRE STOPPED WITH 3M FIRE BARRIER CAULK CP 25 OR EQUAL. INSTALL PER MANUFACTURER'S INSTRUCTIONS AND TO SATISFY THE FIRE RATING REQUIREMENTS OF THE ASSEMBLY.

- | | |
|---------------------------|--|
| 1) ELEVATOR MACHINE ROOM | 2 HOUR FIRE RATING FOR WALLS AND CEILING - UNLESS NOTED OTHERWISE ON THE PLANS |
| 2) MECHANICAL ROOM | 1 HOUR FIRE RATING FOR WALLS AND CEILING - UNLESS NOTED OTHERWISE ON THE PLANS |
| 3) STAIR TOWER | 2 HOUR FIRE RATING - UNLESS NOTED OTHERWISE ON THE PLANS |
| 4) OTHER FIRE SEPARATIONS | PROVIDE TO MATCH ASSEMBLY RATING INDICATED ON THE PLANS OR REQUIRED BY CODE. |

ELECTRICAL NOTES:

1. SCOPE OF WORK:

- CONTRACTOR SHALL VISIT SITE PRIOR TO BIDDING. BIDS SHALL SERVE AS EVIDENCE OF KNOWLEDGE OF EXISTING CONDITIONS TO THE EXTENT POSSIBLE, CONCEALED CONDITIONS EXCLUDED. FIELD VERIFY ALL ELECTRICAL EQUIPMENT.
- FURNISH ALL LABOR, MATERIALS, EQUIPMENT AND TOOLS TO PERFORM ELECTRICAL WORK SHOWN, NOTED OR SCHEDULED FOR A COMPLETE AND FINISHED INSTALLATION.
 - MATERIALS, PRODUCTS AND EQUIPMENT, INCLUDING ALL COMPONENTS THEREOF, SHALL BE NEW AND SUCH AS APPEAR ON THE UNDERWRITERS LABORATORIES LIST OF APPROVED ITEMS AND SHALL BE SIZED IN CONFORMITY WITH REQUIREMENTS OF THE NATIONAL ELECTRICAL CODE AND OTHER APPLICABLE CODES, WHICHEVER ARE MORE STRINGENT.
- ALL WORK TO BE IN ACCORDANCE WITH NATIONAL ELECTRICAL CODE (2015) AND THE UNIFORM CONSTRUCTION CODE (LATEST EDITION).
- ALL ELECTRICAL EQUIPMENT SHALL BE INSTALLED IN STRICT COMPLIANCE WITH THE MANUFACTURER'S INSTALLATION PROCEDURES.
- THE ELECTRICAL CONTRACTOR SHALL PROVIDE ALL LABOR AND MATERIALS NECESSARY FOR A COMPLETE ELECTRICAL SYSTEM, WHETHER SPECIFIED OR IMPLIED.

2. PERMITS:

- SECURE AND PAY FOR ALL REQUIRED PERMITS AND INSPECTION CERTIFICATES.

3. SHOP DRAWINGS:

- SUBMIT MATERIAL LIST AND SHOP DRAWINGS FOR MAJOR EQUIPMENT TO THE ARCHITECT FOR APPROVAL. SUBMITTALS SHALL BE IN ACCORDANCE WITH GENERAL CONDITIONS AND SHALL BEAR STAMP OF THE GENERAL CONTRACTOR SHOWING THAT HE HAS REVIEWED AND APPROVED THEM. LACK OF SUCH CONTRACTOR'S APPROVAL WILL BE CAUSE FOR REJECTION WITHOUT REVIEW BY THE ARCHITECT OR ENGINEER.
- SUBMIT SIX(6) SETS OF SHOP DRAWINGS.

4. CONDUITS:

- THE TYPE OF CONDUIT SHALL BE AS FOLLOWS FOR ALL FEEDERS AND DISTRIBUTION CIRCUITS, UNLESS OTHERWISE SPECIFIED:

APPLICATION	TYPE OF CONDUIT
BURIED IN CONCRETE	PVC - SCHEDULE 40
IN MASONRY	EMT OR IMC
EXPOSED ABOVE GRADE	ARC
UNDERGROUND	PVC - SCHEDULE 40
SUPPLY TO DISTRIBUTION PANELS	EMT
INTERIOR BRANCH CIRCUITS (CONCEALED)	MC
INTERIOR BRANCH CIRCUITS (EXPOSED)	EMT

5. WIRE:

- WIRE SHALL BE SINGLE CONDUCTOR COPPER WITH 600 VOLT INSULATION. #10 AND SMALLER SHALL BE SOLID. #8 AND LARGER SHALL BE STRANDED. MINIMUM WIRE SIZE SHALL BE #12 EXCEPT #14 MAY BE USED FOR CONTROL. ALL WIRE AND CABLE SHALL BE NEW AND SHALL BE BROUGHT TO THE SITE IN UNBROKEN PACKAGES. ALL WIRING OF ANY TYPE SHALL BE IN CONDUIT.
 - GENERAL WIRING SHALL BE THW OR THWN (ALUMINUM CONDUCTORS ARE NOT PERMITTED).
- WIRE CONNECTORS SHALL BE EQUAL TO SCOTCHLOCK FOR #6 AND SMALLER AND T & B 'LOCK-LITE' FOR #8 AND LARGER.

6. LIGHTING:

- LIGHTING FIXTURES AND LAMPS (UNLESS NOTED OTHERWISE) SHALL BE FURNISHED BY THE ELECTRICAL CONTRACTOR. ELECTRICAL CONTRACTOR SHALL INSTALL ALL FIXTURES AND LAMPS.

7. WIRE DEVICES:

- RECEPTACLES SHALL BE 20 AMP, 3-WIRE GROUNDING TYPE EQUAL TO HUBBELL 5362 (MOUNTING @ 18" A.F.F.).
- SWITCHES SHALL BE STANDARD GRADE RATED 20 AMP AT 120 VOLT (MOUNTING @ 18" A.F.F.).
- SPECIAL DEVICES SHALL BE A SPECIFICATION GRADE.

8. SAFETY SWITCHES:

- PROVIDE SAFETY AND DISCONNECT SWITCHES, FUSED OR NONFUSED, AS CALLED FOR ON DRAWINGS AND AS REQUIRED BY CODE. SWITCHES SHALL BE HEAVY DUTY, LOAD AND HORSEPOWER RATED AS MANUFACTURED BY SQUARE D, GUILD, ITE OR EQUAL.
- MANUAL MOTOR STARTERS WITH OVERLOAD PROTECTION MAY BE USED FOR FRACTIONAL HORSEPOWER MOTORS. SINGLE PHASE STARTERS SHALL BE SQUARE D OR EQUAL. THREE PHASE STARTERS SHALL BE PROVIDED WITH OVERLOAD DEVICES IN EACH PHASE. MAGNETIC MOTOR STARTERS SHALL BE USED FOR INTEGRAL HORSEPOWER MOTORS, COMBINATION STARTERS, WHEN USED, SHALL CONTAIN FUSIBLE SWITCHES.

9. BOXES:

- OUTLET BOXES AND COVERS SHALL BE GALVANIZED, ONE-PIECE PRESSED STEEL KNOCKOUT.
- JUNCTION, PULL BOXES AND COVERS SHALL BE GALVANIZED STEEL, CODE GAUGE SIZE.

10. SERVICES:

- PROVIDE ELECTRICAL SERVICE AS SHOWN ON THE DRAWINGS. ALL WORK NOT SPECIFICALLY NOTED AS BEING BY THE OWNER OR POWER COMPANY SHALL BE PROVIDED BY THE ELECTRICAL CONTRACTOR. CLOSELY COORDINATE ENTIRE INSTALLATION WITH OWNER AND POWER COMPANY AS REQUIRED.

11. INSTALLATION:

- ALL ELECTRICAL WORK SHALL BE INSTALLED SO AS TO BE READILY ACCESSIBLE FOR OPERATING, SERVICING, MAINTAINING AND REPAIRING. HANGERS SHALL INCLUDE ALL MISCELLANEOUS STEEL SUCH AS CHANNELS, RODS, ETC., NECESSARY FOR THE INSTALLATION OF WORK AND SHALL BE FASTENED TO STEEL, CONCRETE OR WOOD, BUT NOT TO PIPING. ALL CONDUIT SHALL BE CONCEALED WHEREVER POSSIBLE. EXPOSED CONDUIT SHALL BE IN STRAIGHT LINES PARALLEL WITH OR AT RIGHT ANGLES TO COLUMN LINES OR BEAMS AND SEPARATED AT LEAST 3 INCHES FROM WATER LINES WHEREVER THEY RUN ALONG SIDE OR ACROSS SUCH LINES. CONDUITS SHALL BE IN CONDUIT, DUCTS OR APPROVED RACEWAYS.
- THE CONTRACTOR SHALL DO ALL CUTTING, CHASING OR CHANNELING AND PATCHING REQUIRED FOR ANY WORK UNDER THIS DIVISION. ANY CUTTING SHALL HAVE PRIOR APPROVAL OF OWNER. SLEEVES SHALL EXTEND AT LEAST TWO (2)" INCHES ABOVE FINISHED FLOOR AND ALL SLEEVES, OPENINGS, ETC., THROUGH FIRE RATED WALLS AND FLOORS SHALL BE SEALED AFTER CONDUIT INSTALLATION TO REMAIN THEIR FIRE RATING.
- THE FOLLOWING EQUIPMENT SHALL BE IDENTIFIED WITH ENGRAVED BAKELITE NAMEPLATES AS TO NAME AND/OR FUNCTION: DISTRIBUTION PANEL, LIGHTING PANELS, MOTOR STARTERS, TIME CLOCKS, AND DISCONNECT SWITCHES.
- THE LOCATION OF OUTLETS AND EQUIPMENT SHOWN ON THE DRAWINGS ARE APPROXIMATE AND THE ARCHITECT SHALL HAVE THE RIGHT TO RELOCATE ANY OUTLETS OR FIXTURES BEFORE THEY ARE INSTALLED WITHOUT ADDITIONAL COST.
- ELECTRICAL CONTRACTOR SHALL RECORD ALL FIELD CHANGES IN HIS WORK AS THE JOB PROGRESSES.

12. GUARANTEE:

- MATERIALS, EQUIPMENT AND INSTALLATION SHALL BE GUARANTEED FOR A PERIOD OF ONE (1) YEAR FROM DATE OF ACCEPTANCE. DEFECTS WHICH APPEAR DURING THAT PERIOD SHALL BE CORRECTED AT THIS CONTRACTOR'S EXPENSE.
- FOR THE SAME PERIOD, THE ELECTRICAL CONTRACTOR SHALL BE RESPONSIBLE FOR ANY DAMAGE TO PREMISES CAUSED BY DEFECTS IN WORKMANSHIP OR IN THE WORK OR EQUIPMENT FURNISHED AND/OR INSTALLED BY HIM.

13. FINALLY:

- IT IS THE INTENT THAT THE FOREGOING WORK SHALL BE COMPLETE IN EVERY RESPECT AND THAT ANY MATERIAL OR WORK NOT SPECIFICALLY MENTIONED OR SHOWN ON THE DRAWINGS, BUT NECESSARY TO FULLY COMPLETE THE WORK SHALL BE FURNISHED.

ELECTRICAL POWER SYMBOLS

	POWER WIRING LEG
	HOME RUN TO PANEL/CKT, NUMBER OF TICK MARKS = NUMBER OF CONDUCTORS EXCLUDING GROUND, PROVIDE 'GREEN' GROUND WIRE FOR ALL CIRCUITS, NUMBER OF ARROW HEADS = NUMBER OF HOME RUNS
	DUPLEX GROUNDED RECEPTACLE
	DUPLEX RECEPTACLE WITH GROUND FAULT INTERRUPTER
	QUAD DUPLEX GROUNDED RECEPTACLE
	SPECIAL PURPOSE OUTLET, CONFIRM OUTLET CONFIGURATION (TYPE) WITH EQUIPMENT TO BE SERVED PRIOR TO INSTALLATION
	DISCONNECT SWITCH
	JUNCTION BOX
	EXHAUST FAN
	MOTOR OR MISCELLANEOUS LOAD
	TELEPHONE/DATA/TV BOX
	CEILING MOUNTED MOTION SENSOR
	WALL MOUNTED MOTION SENSOR
	RADIO POWER SAVER WIRELESS DAYLIGHT SENSOR
	LUTRON POWPAK DIMMING MODULE WITH 0-10V DIMMING
	SINGLE POLE SWITCH
	DOUBLE SWITCH
	THREE WAY SWITCH
	FOUR WAY SWITCH
	DIMMER SWITCH
	KEYED SWITCH
	JAMB SWITCH
	TIMER SWITCH
	MOTION SWITCH
	DIMMING MOTION SWITCH
	TOUCHLESS WAVE LIGHT SWITCH
	LED EMERGENCY EXIT LIGHT
	LED COMBINATION EXIT/EMERGENCY LIGHT
	LED EMERGENCY LIGHT

ELECTRICAL DRAWING LIST

E-0.0 ELECTRICAL COVER SHEET
E-1.0 ELECTRICAL NEW WORK POWER PLAN


NAME PLATES

'EQUIPMENT NO.'	← INSERT ACTUAL EQUIPMENT NO.
'FED FROM'	
'PANEL NO.'	← INSERT SOURCE PANEL NO.

21-062

L.S. GRIM, INC.
Consulting Engineers

MAIN OFFICE
1992 W. JEFFERSON BLVD., HAGERSTOWN, MD 21742-4367
PHONE: (410) 391-7400 FAX: (410) 391-7401
PHONE TOLL FREE: 1-888-797-GRIM (4746)
D.C. METRO OFFICE
2275 RESEARCH BLVD., SUITE 500, ROCKVILLE, MD 20850
© 2022 L.S. GRIM, INC. & LESLIE S. GRIM, P.E.

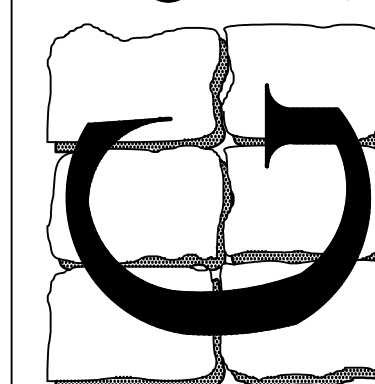

CIRCUIT COURT
CHILLER REPLACEMENT
24 SUMMIT AVE HAGERSTOWN, MD 21740

ELECTRICAL COVER SHEET

Professional Certification


I certify that these documents were prepared or approved by me, and that I am a duly licensed engineer under the laws of the State of Maryland. License Number: 14401 Expiration Date: 4/21/2025

LESLIE SCOTT GRIM, P.E.
CD PROF. ENG. NO. PE0050461
DC PROF. ENG. NO. PE90201
DE PROF. ENG. NO. 19513
GA PROF. ENG. NO. PE032682
HI PROF. ENG. NO. PE13043
MD PROF. ENG. NO. 14401
NC PROF. ENG. NO. 033364
NJ PROF. ENG. NO. 38497
NY PROF. ENG. NO. 075414
PA PROF. ENG. NO. PE032636E
VA PROF. ENG. NO. 023240
WV PROF. ENG. NO. 10764


REV.	DATE	COMMENT
	5/11/23	BID / PERMIT SET

DRAWN BY: TMH

E-0.0
6 OF 8 SHEETS
DATE: MAY 11, 2023

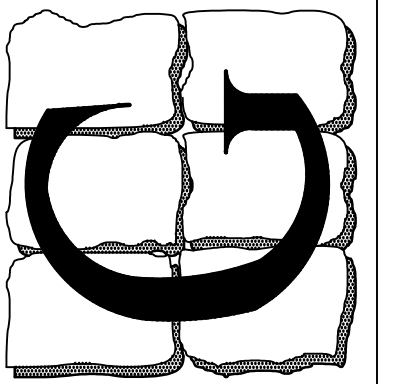

**CIRCUIT COURT
 CHILLER REPLACEMENT
 24 SUMMIT AVE HAGERSTOWN, MD 21740
 ELECTRICAL NEW WORK ROOF PLAN**

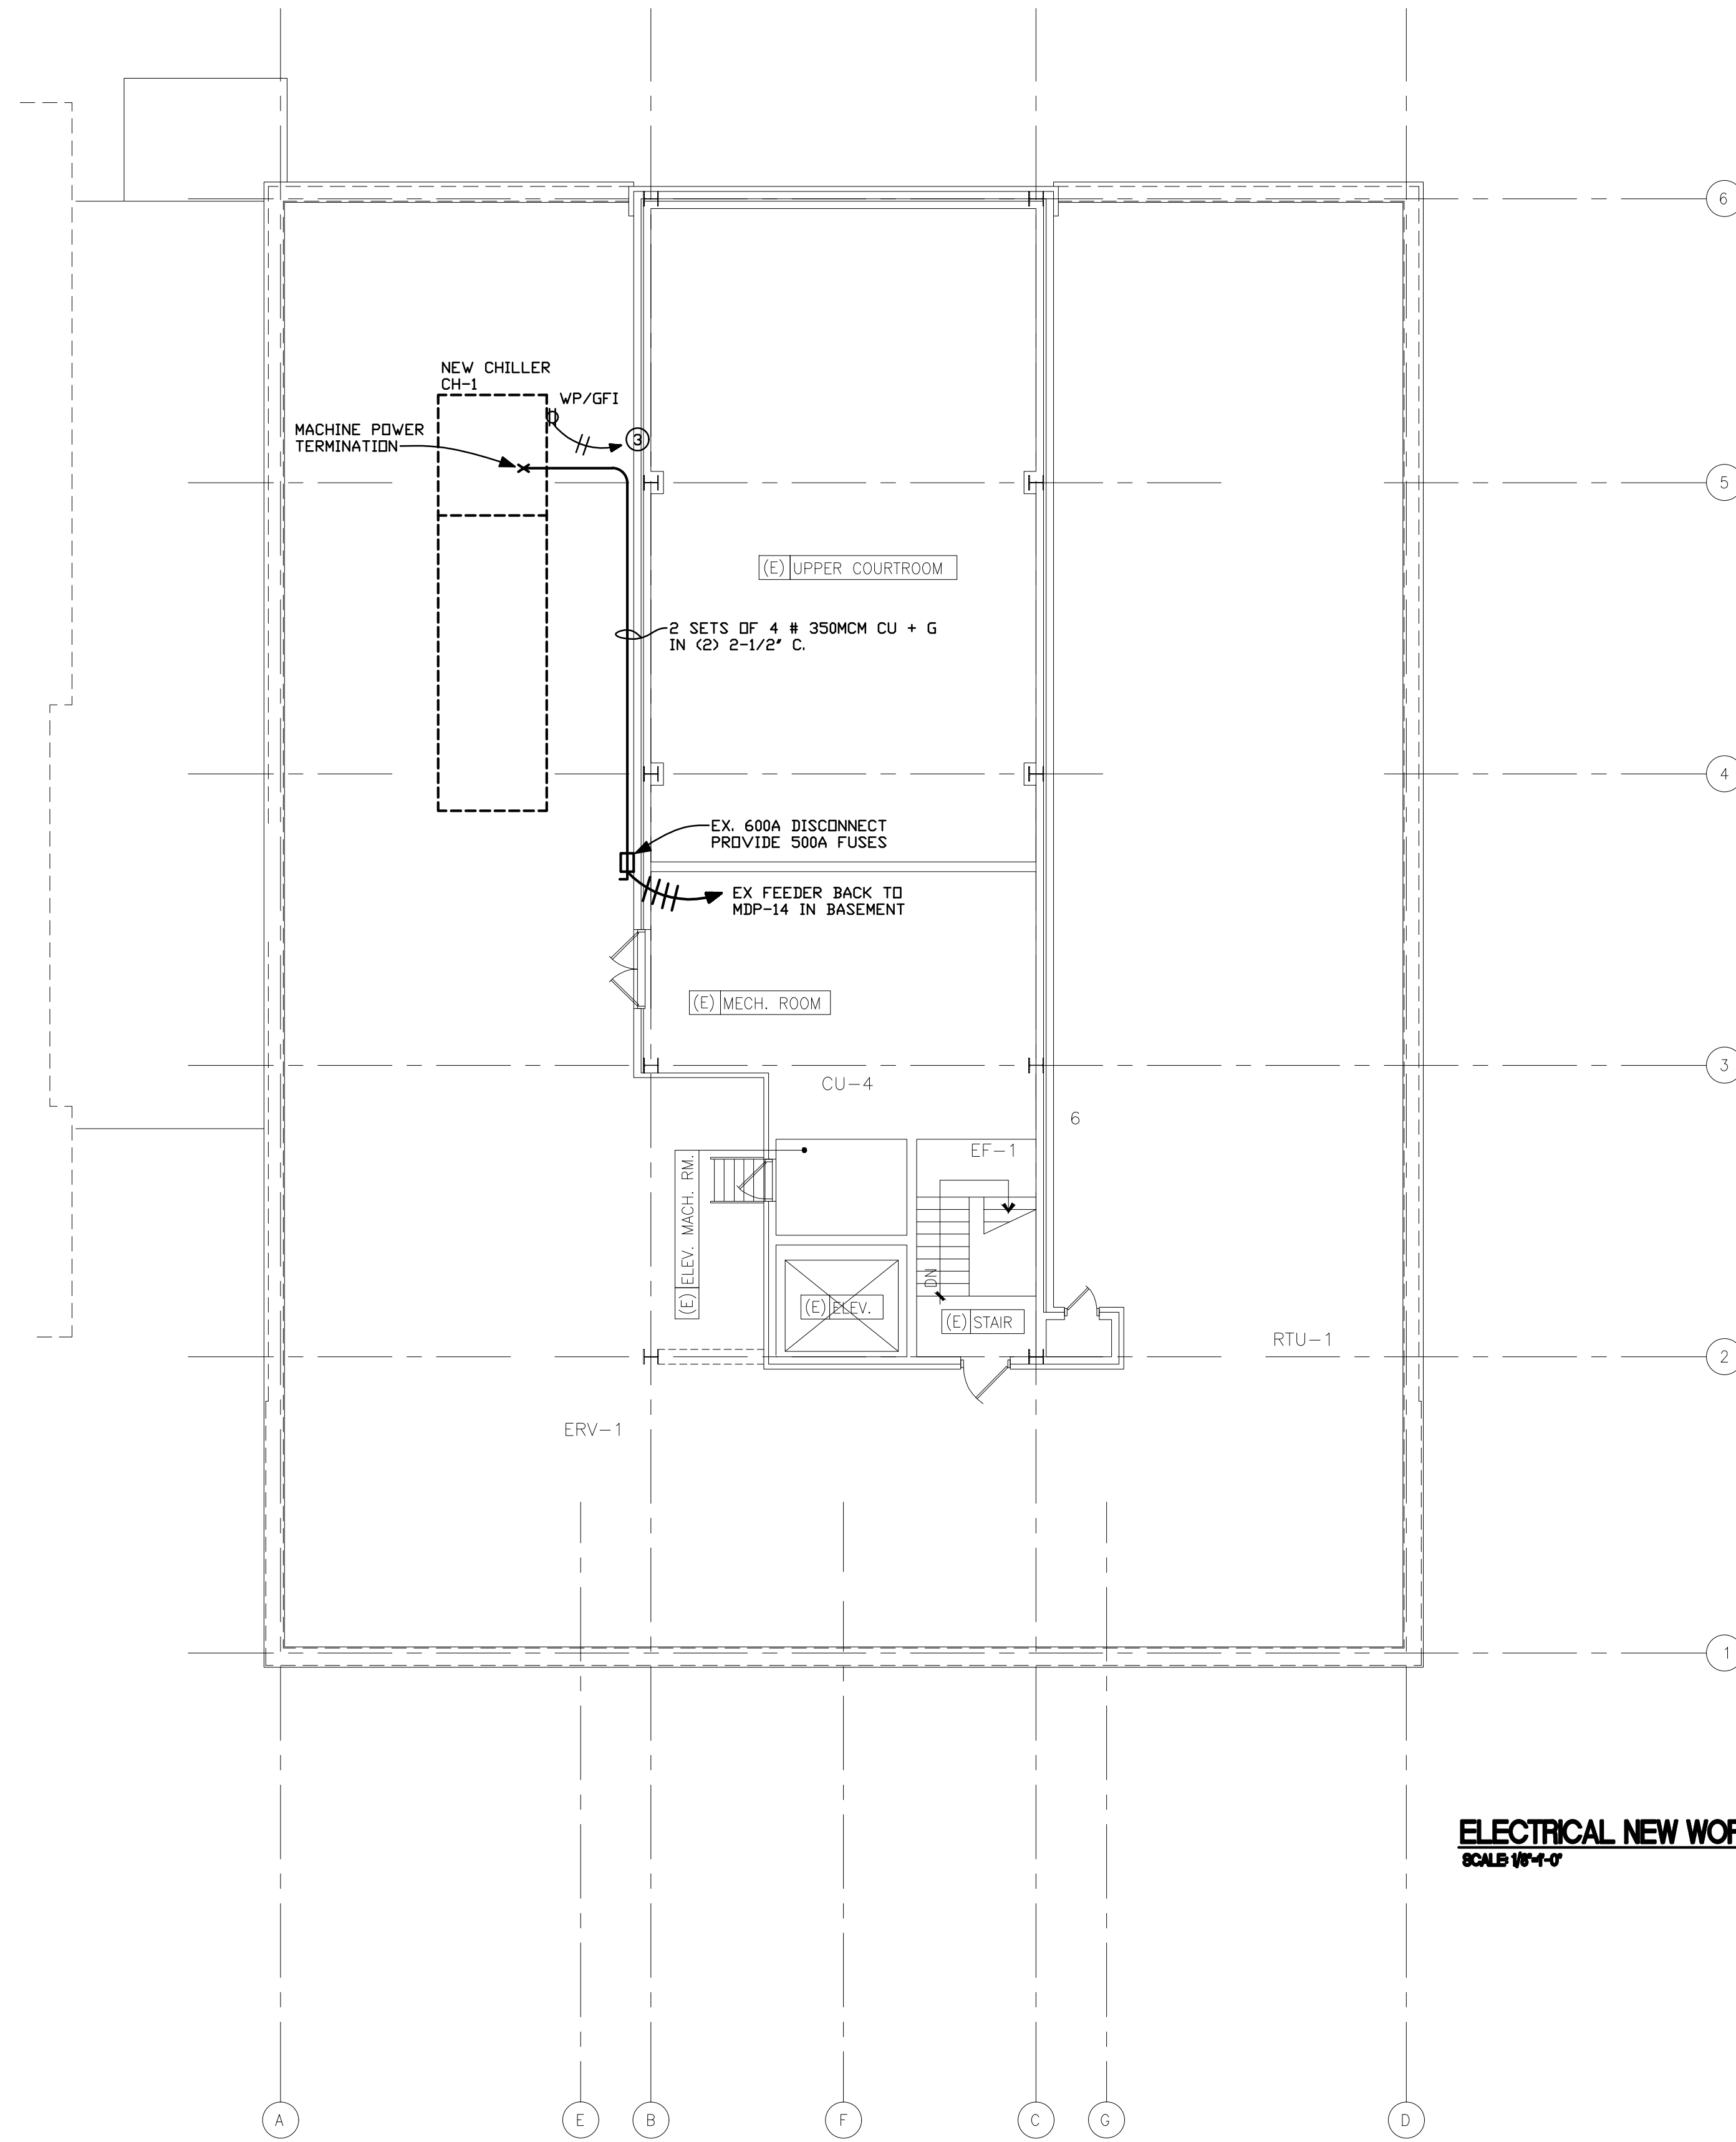

- ELECTRICAL PLAN KEYED NOTES:**
- EX 600A W/P FUSED DISCONNECT, CLEAN, SERVICE AND REFUSE AT 500 AMPS
 - CONTRACTOR SHALL REUSE EXISTING CHILLER IN ENTIRETY AND MAKE SAFE.
 - PROVIDE 20A 120V HOME RUN BACK TO NEAREST POWER PANEL, PROVIDE 20A 1 POLE DEVICE. PROVIDE VP/GFT OUTLET TO ACCOMMODATE HEAT TAPE FOR PIPING FREEZE PROTECTION.


ELECTRICAL NEW WORK ROOF PLAN
 SCALE 1/8"=1'-0"

Professional Certification
 I certify that these documents were prepared or approved by me, and that I am a duly licensed engineer under the laws of the State of Maryland
 License Number: 14401
 Expiration Date: 4/21/2025

LESLIE SCOTT GRIM, P.E.
 CO. PROF. ENG. NO. PE0050461
 DC. PROF. ENG. NO. PE001201
 DE. PROF. ENG. NO. 19513
 GA. PROF. ENG. NO. PE032682
 HI. PROF. ENG. NO. PE13043
 MD. PROF. ENG. NO. 14401
 NJ. PROF. ENG. NO. 33364
 NY. PROF. ENG. NO. 39497
 PA. PROF. ENG. NO. PE032636E
 VA. PROF. ENG. NO. 023240
 WV. PROF. ENG. NO. 10764

REV.	DATE	COMMENT
	5/11/23	BID/ PERMIT SET

DRAWN BY: **LBO**

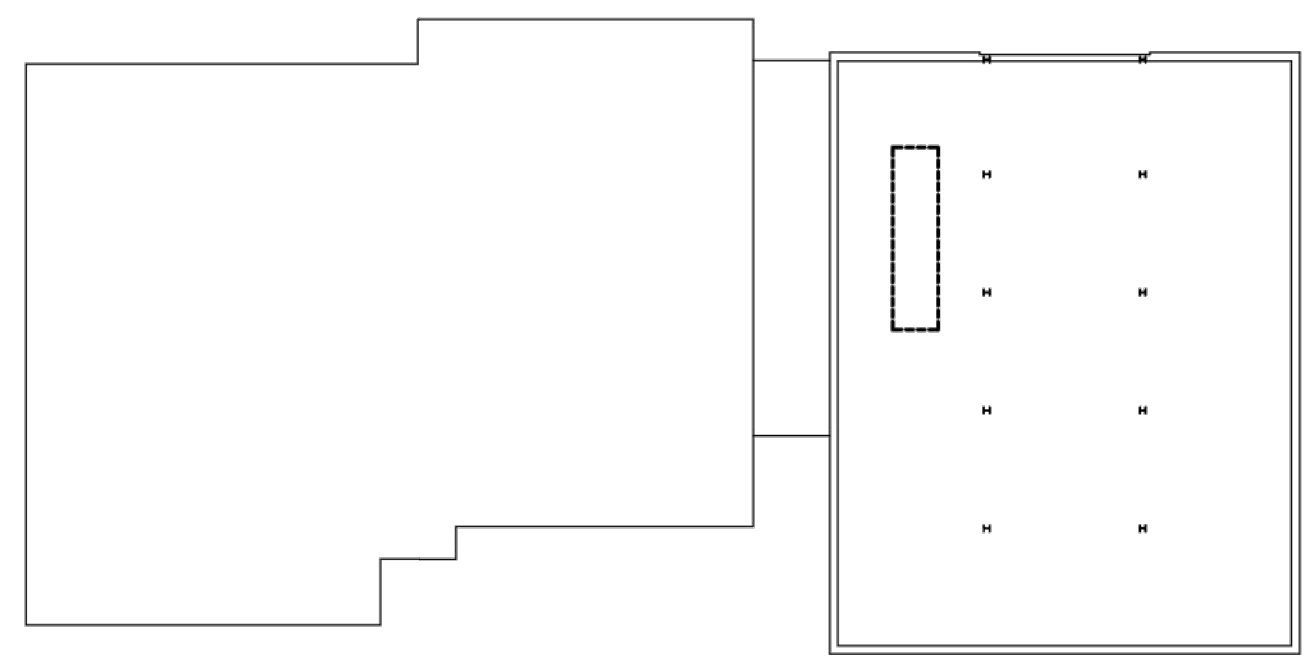

KEY PLAN
N.T.S.


STRUCTURAL NOTES

GENERAL


- 1) THE CONTRACTOR SHALL VERIFY ALL DIMENSIONS PRIOR TO STARTING CONSTRUCTION. THE ARCHITECT SHALL BE NOTIFIED OF ANY DISCREPANCIES OR INCONSISTENCIES.
- 2) NOTES AND DIMENSIONS ON DRAWINGS SHALL TAKE PRECEDENCE OVER SCALES SHOWN ON DRAWINGS.
- 3) ALL WORK SHALL BE IN ACCORDANCE WITH THE MORE STRINGENT REQUIREMENTS OF THE MINIMUM STANDARDS LISTED IN THE GOVERNING CODE OR AS INDICATED HEREON. GOVERNING CODE SHALL BE I.B.C. 2018.
- 4) COORDINATE THESE DRAWINGS WITH THE ARCHITECTURAL, MECHANICAL, AND ELECTRICAL DRAWINGS WITH REGARD TO DIMENSIONS, OPENINGS, LOCATION OF EQUIPMENT, ETC.
- 5) THE STRUCTURAL DRAWINGS AND SPECIFICATIONS REPRESENT THE FINISHED STRUCTURE. THEY DO NOT INDICATE THE METHOD OF CONSTRUCTION. THE CONTRACTOR SHALL PROVIDE ALL MEASURES NECESSARY TO PROTECT THE STRUCTURE DURING CONSTRUCTION, INCLUDING ALL BRACING AND SHORING REQUIRED TO RESIST THE ACTUAL CONSTRUCTION LOADS.
- 6) ASTM SPECIFICATIONS LISTED SHALL BE THE LATEST EDITION.
- 7) DESIGN LIVE LOADS:

STRUCTURAL STEEL


- 1) STRUCTURAL STEEL SHALL BE DETAILED, FABRICATED, AND ERECTED IN ACCORDANCE WITH THE AISC SPECIFICATION FOR THE DESIGN, FABRICATION, AND ERECTION OF STRUCTURAL STEEL FOR BUILDINGS (LATEST EDITION).
- 2) ALL STRUCTURAL STEEL SHALL CONFORM TO THE REQUIREMENTS OF ASTM DESIGNATION A-992, GRADE 50 FOR W SHAPES AND ASTM A-36 FOR MISC. STRUCTURAL SHAPES UNLESS OTHERWISE NOTED.
- 3) PIPE COLUMNS SHALL CONFORM TO ASTM DESIGNATION A-53 GRADE "B". ALL STEEL TUBES SHALL CONFORM TO ASTM DESIGNATION A-500 GRADE "B" COLD FORMED TUBES WITH $F_y = 46$ KSI.
- 4) BEAM CONNECTIONS SHALL BE LONGEST PERMITTED BY BEAM WEB DEPTH. ALL BOLTS SHALL BE A325-N EXCEPT AS NOTED. ALL WELDS SHALL BE MADE WITH 70KSI ELECTRODES. ALL WELDS SHALL BE SHOP PAINTED, FIELD WELDS SHALL BE PAINTED TO MATCH.
- 5) THE CONTRACTOR SHALL PROVIDE ALL NECESSARY TEMPORARY BRACING FOR NEW AND EXISTING STRUCTURAL STEEL. THE FABRICATOR SHALL FURNISH SHOP DRAWINGS TO THE ENGINEER FOR REVIEW PRIOR TO FABRICATION.
- 6) BOLT HOLES SHALL BE 1/16 INCH LARGER DIAMETER THAN NOMINAL SIZE OF BOLT USED, UNLESS OTHERWISE NOTED.
- 7) ALL STRUCTURAL STEEL SURFACES THAT ARE ENCASED IN CONCRETE OR ARE ENCASED BY BUILDING FINISH, SHALL BE LEFT UNPAINTED. PRIMER SHALL BE USED ELSEWHERE, SEE SPECIFICATIONS.
- 8) ALL WELDS SHALL BE IN CONFORMANCE WITH THE STRUCTURAL WELDING CODE (AWS D1.1) OF THE AMERICAN WELDING SOCIETY.
- 9) ALL BOLTED CONNECTIONS ARE DESIGNED FOR THE BEARING-TYPE CONDITION WITH THREADS INCLUDED IN THE SHEAR PLANE. BOLTS SHALL BE TIGHTENED TO THE SNUG-TIGHT CONDITION.

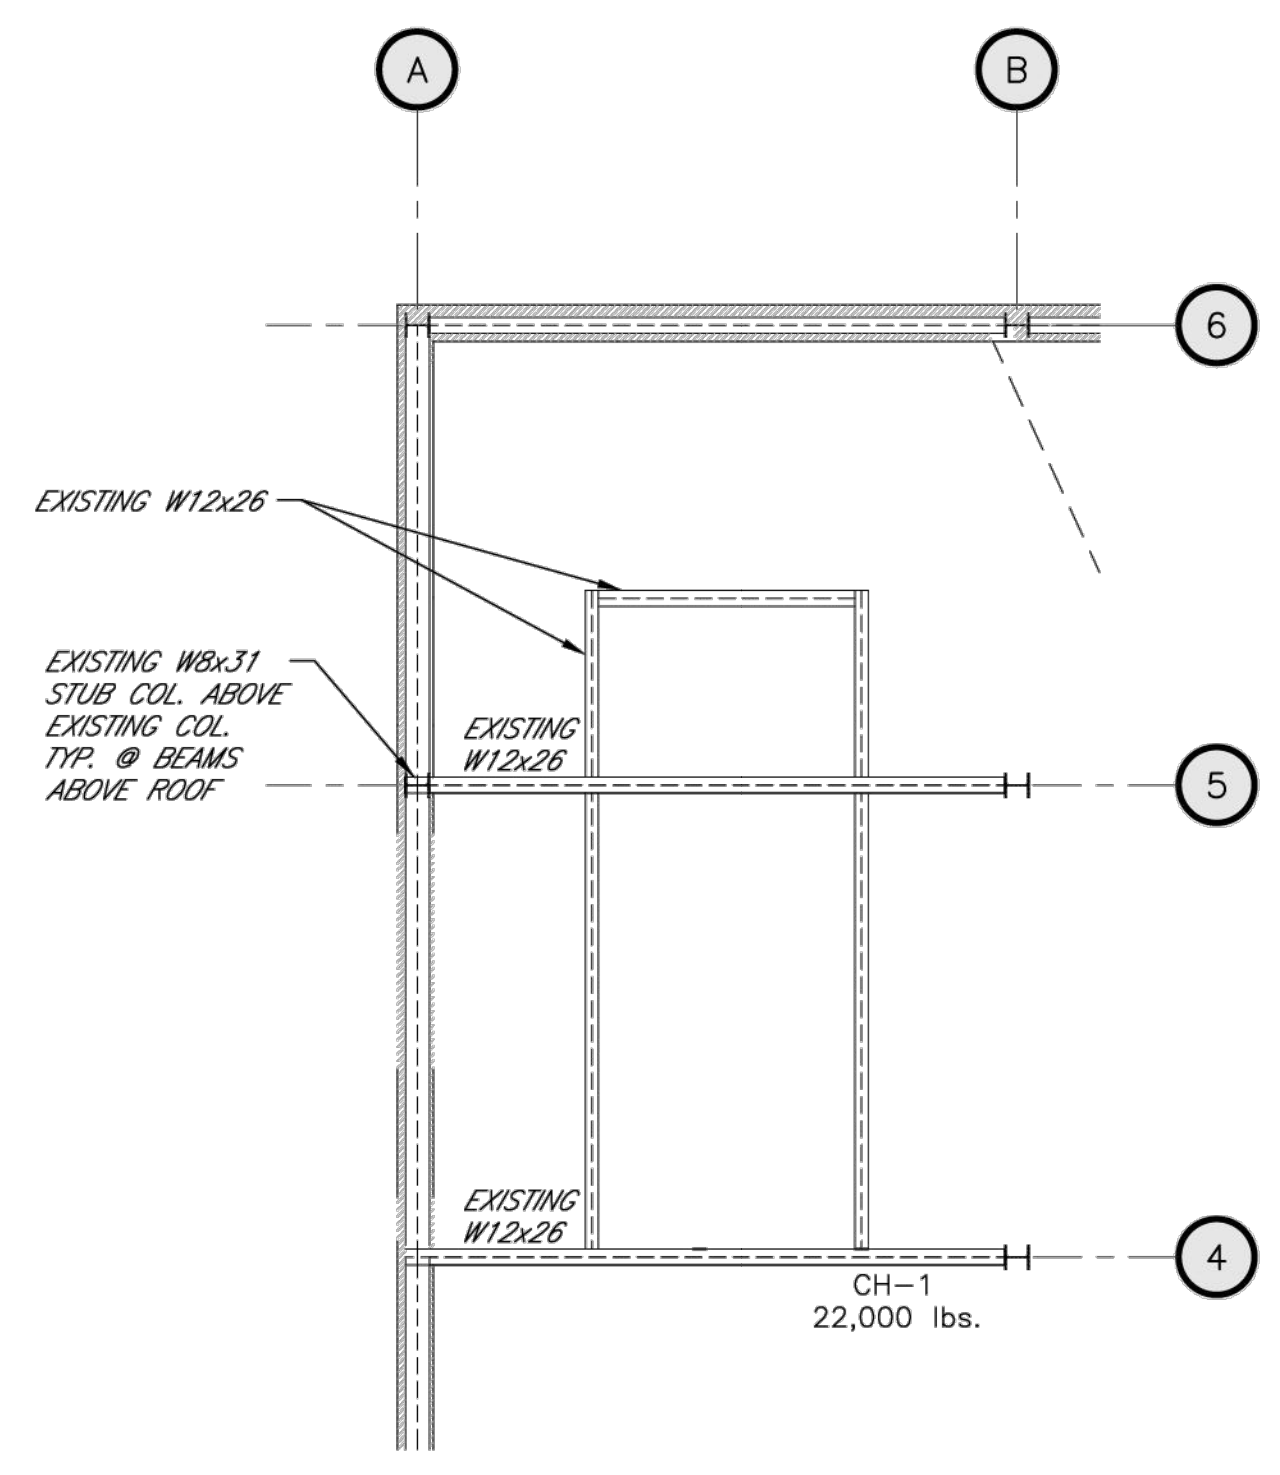


EXISTING RTU FRAMING PLAN
1/8"=1'-0"

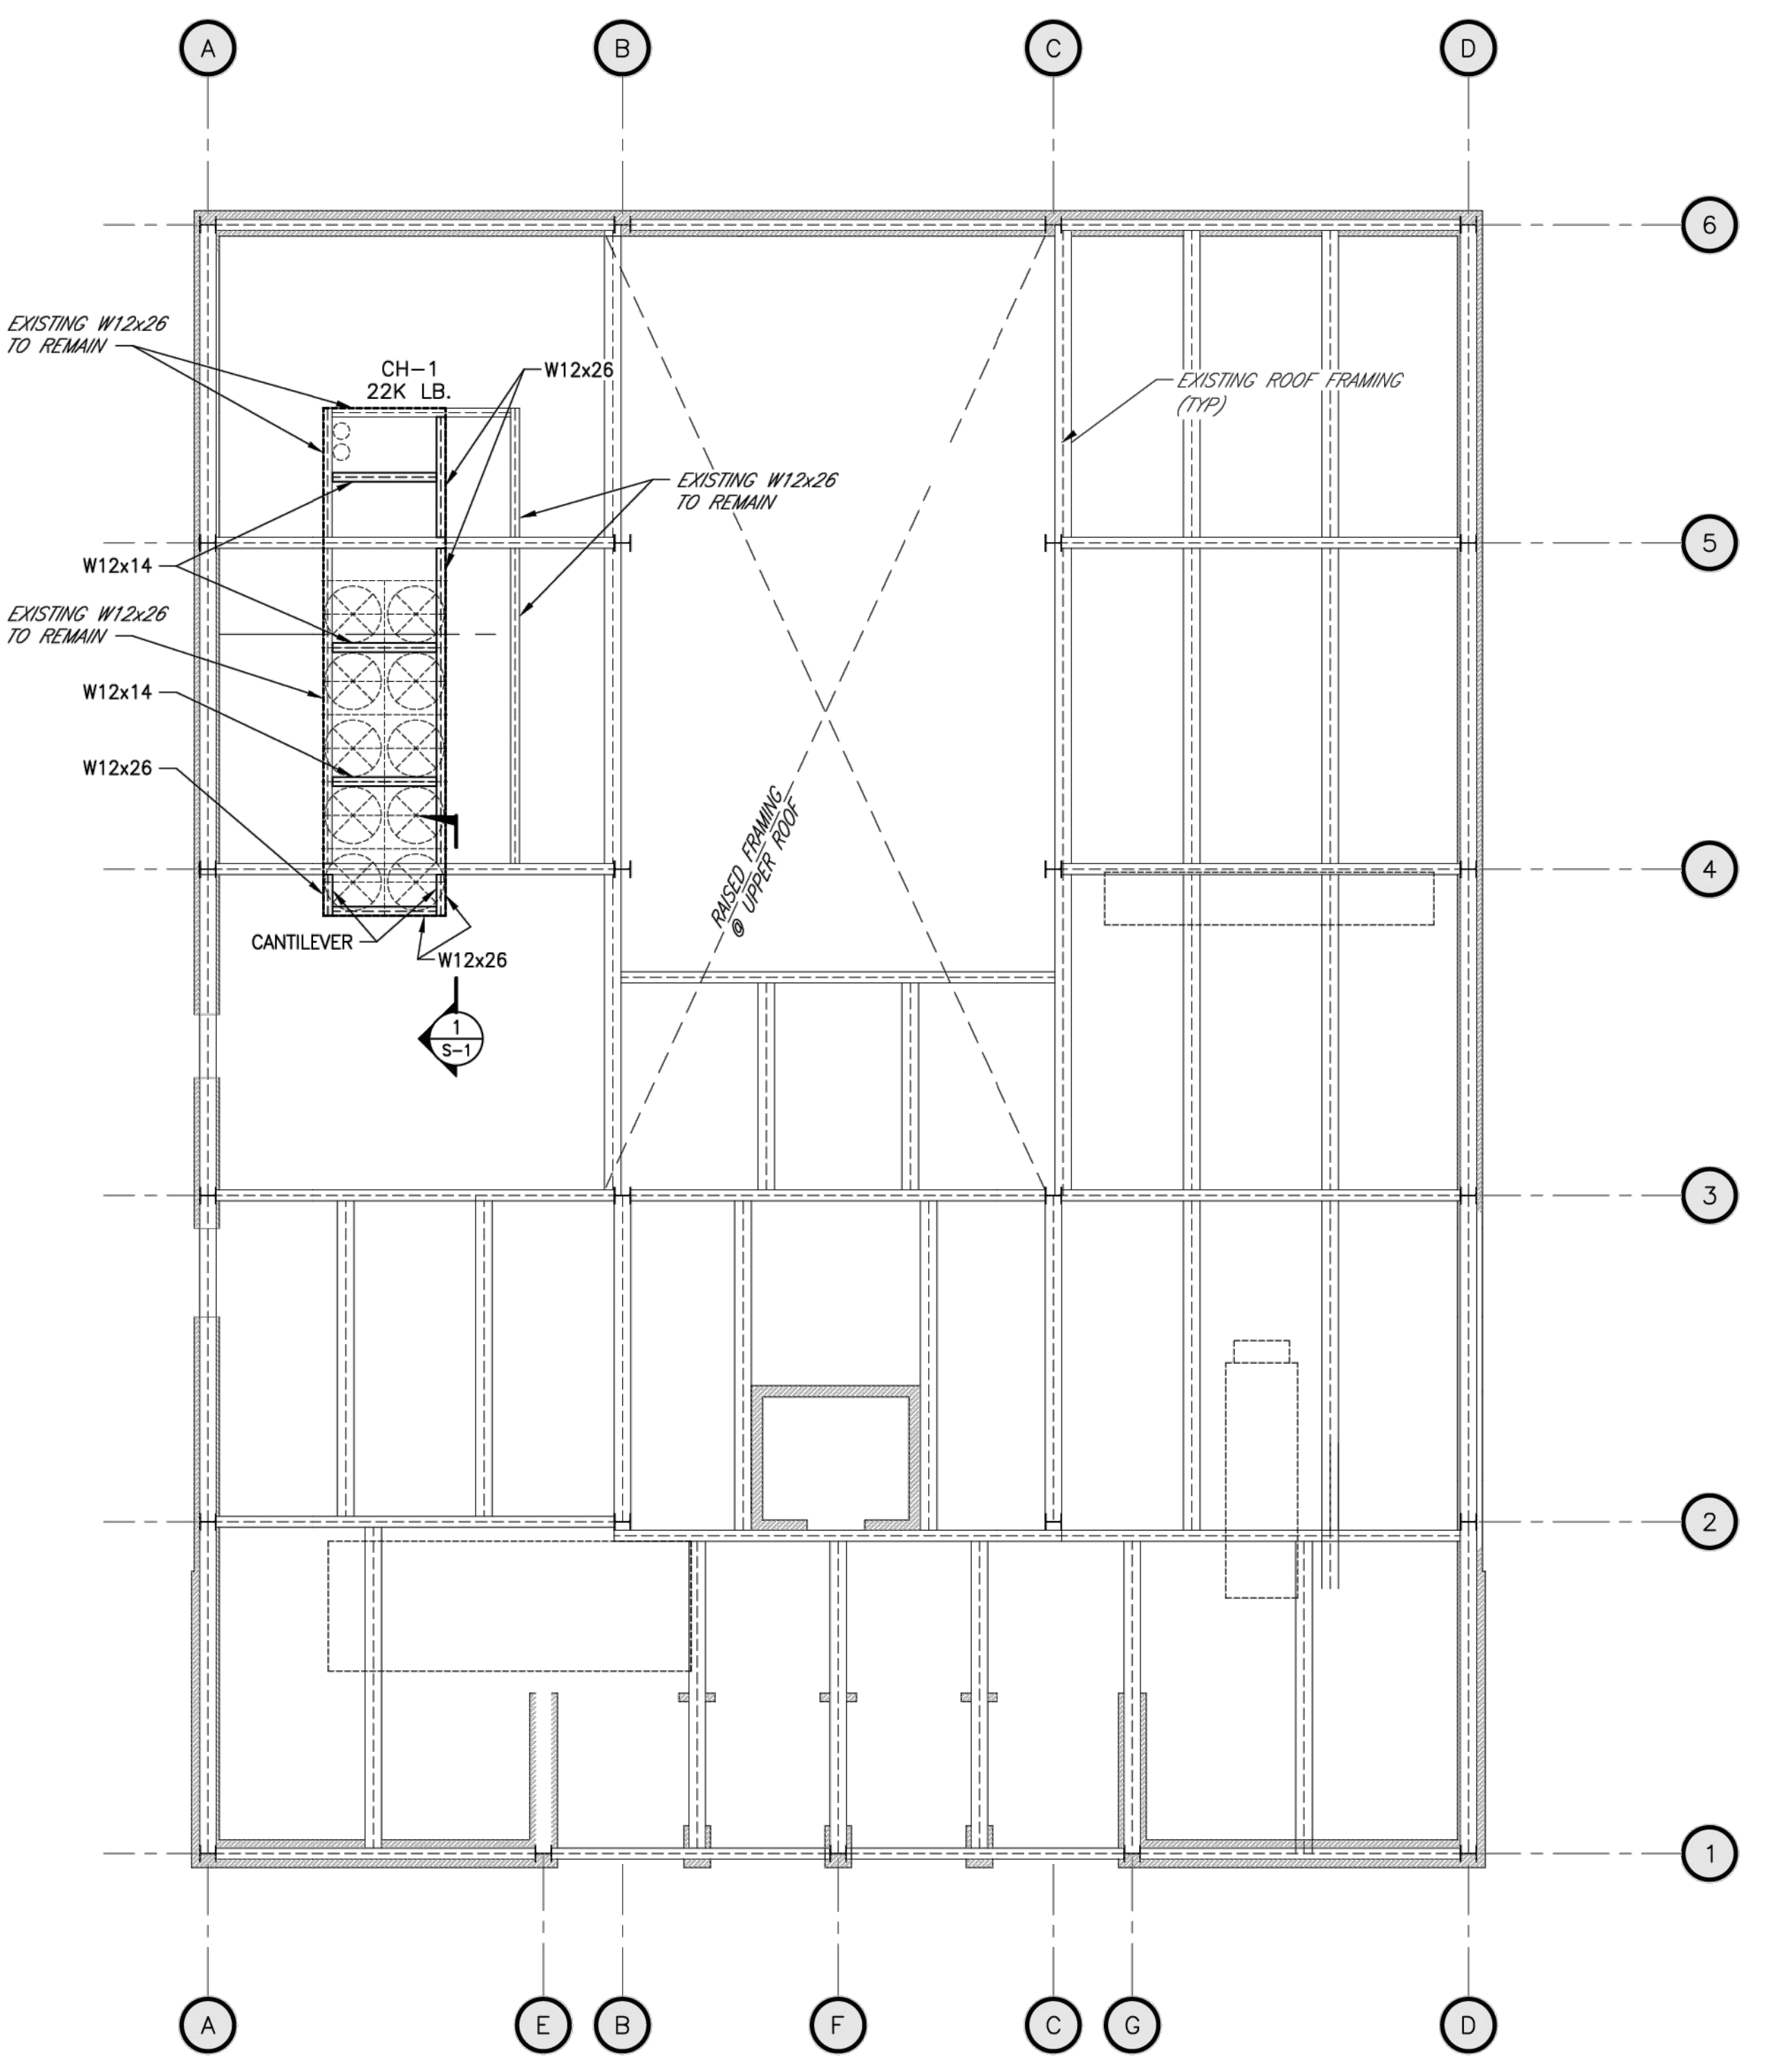


RTU FRAMING PLAN
1/8"=1'-0"

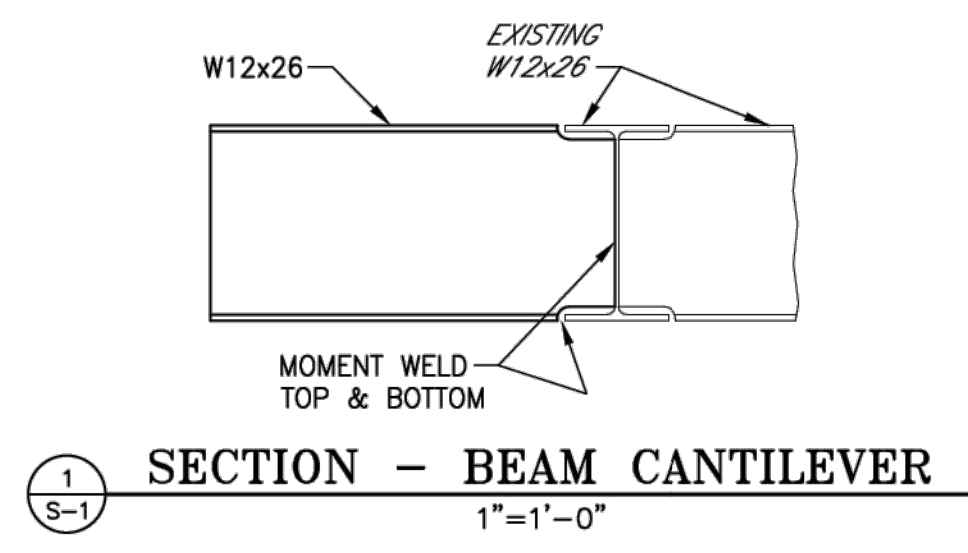

SECTION - BEAM CANTILEVER
1"=1'-0"

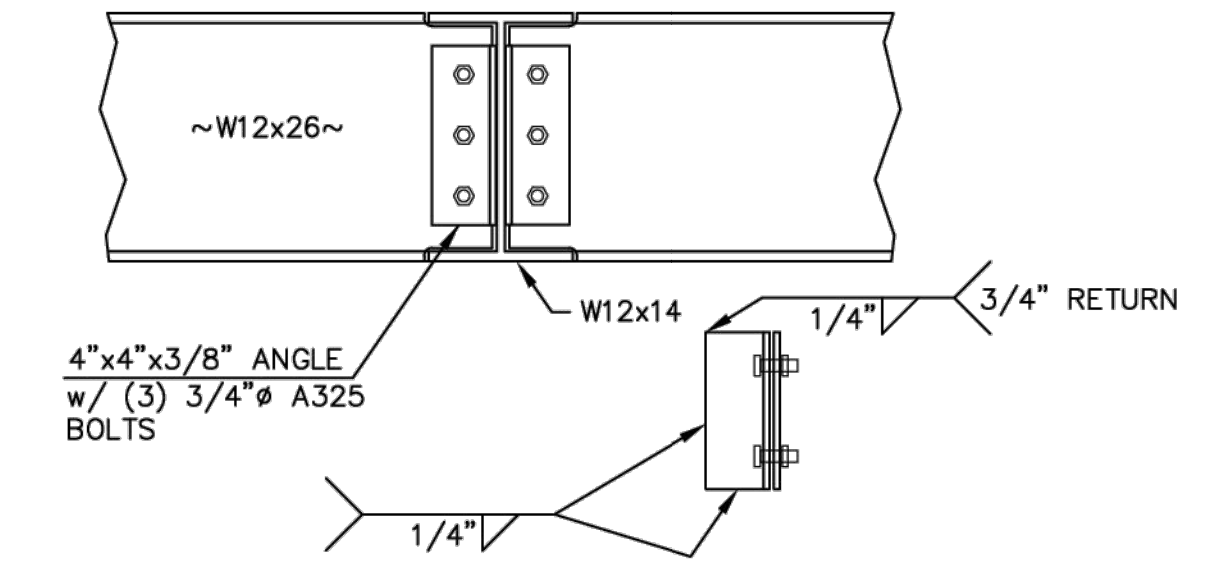

SECTION - BEAM TO BEAM CONN.
N.T.S.

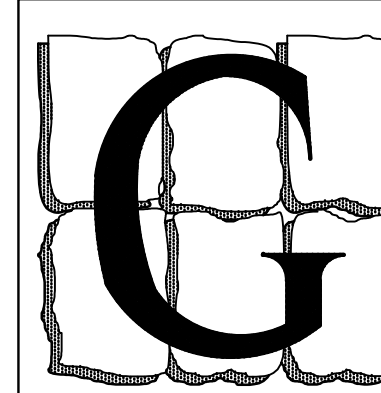

L.S. GRIM, INC.
Consulting Engineers

MAIN OFFICE
19922 JEFFERSON BLVD., HAGERSTOWN, MD 21742-4367
PHONE: 301.797.1702, FAX: 301.797.4831
PHONE TOLL FREE: 1-888-797-GRIM (4746)
DC METRO OFFICE
2275 RESEARCH BLVD., SUITE 500, ROCKVILLE, MD 20850
© 2022 L.S. GRIM, INC. & LESLIE S. GRIM, P.E.

21-062

Professional Certification
I certify that these documents
were prepared or approved by
me, and that I am a duly
licensed engineer under the
laws of the State of Maryland
License Number: 14401
Expiration Date: 4/21/2023