

WASHINGTON COUNTY PUMP STATION UPGRADES

100% DESIGN WASHINGTON COUNTY, MARYLAND

SITE PLAN SP-21-025 ESD CONCEPT PLAN SWCP-21-020

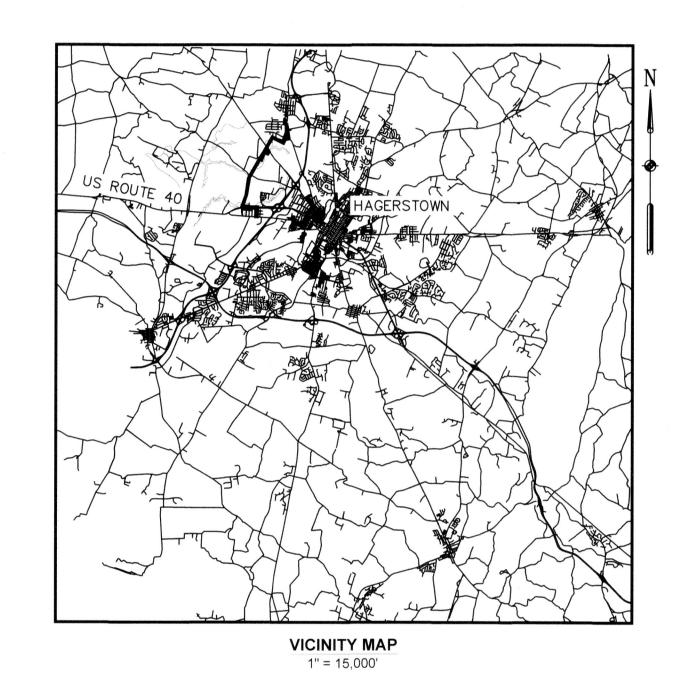

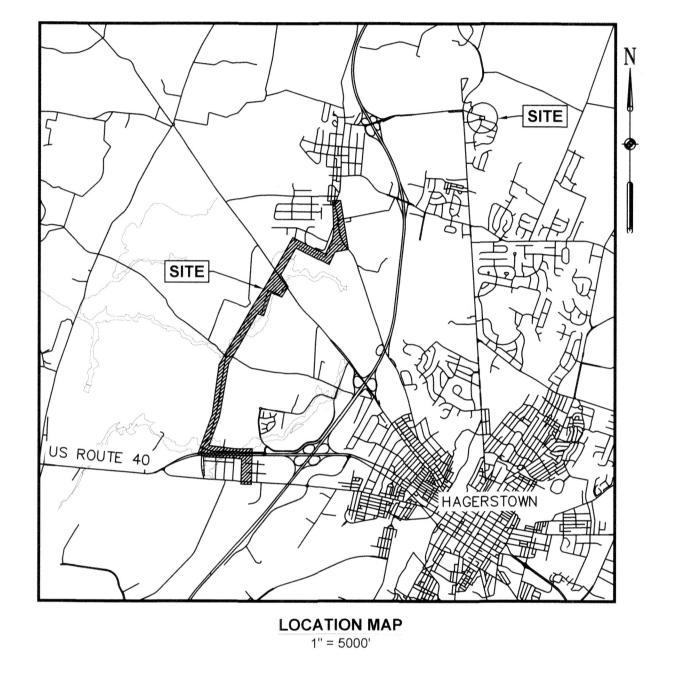



OWNER/DEVELOPER'S CERTIFICATION Mark D Bradshaw OWNER/DEVELOPER'S CERTIFICATION WE CERTIFY THAT ALL/ANY RESPONSIBLE PARTIES FOR CLEARING. GRADING Mark Bradshaw ENGINEER CERTIFICATION - EROSION CONTROL BEEN DESIGNED IN ACCORDANCE WITH LOCAL ORDINANCES, COMAR 26.17.01.07 SITE LOCATIONS:

DEPUTY DIRECTOR OF ENGINEERING SERVICES FOR WASHINGTON COUNTY, MD

APPROVED FOR CONSTRUCTION

FARM LANE PUMP STATION 14135 PENNSYLVANIA AVENUE HAGERSTOWN, MD 21742 **ZONING: AG - AGRICULTURE**

ELECTION DISTRICT: 27 TAX MAP: 0024, GRID: 0005 PARCEL NO.: 0571 WATERSHED: 02140502 ANTIETAM CREEK

MAUGANSVILLE ROAD PUMP STATION

13635 MAUGANSVILLE ROAD, HAGERSTOWN, MD 21740 ZONING: HI - HIGHWAY INTERCHANGE **ELECTION DISTRICT: 13** TAX MAP: 0024, GRID: 0015 PARCEL NO.: 00439 WATERSHED: 02140504 CONOCOCHEAGUE CREEK

MAUGANS MEADOWS PUMP STATION

13500 ELAINE'S WAY HAGERSTOWN, MD 21740 ZONING: RT - RESIDENTIAL TRANSITIONAL **ELECTION DISTRICT: 13** TAX MAP: 0024, GRID: 0014

PARCEL NO.: 0520 WATERSHED: 02140504 CONOCOCHEAGUE CREEK

NEW REGIONAL PUMP STATION 13240 CEARFOSS PIKE, HAGERSTOWN, MD 21740 **ZONING: RT - RESIDENTIAL TRANSITIONAL** ELECTION DISTRICT: 13 TAX MAP: 0037, GRID: 0002 PARCEL NO.: 0102 WATERSHED: 02140504 CONOCOCHEAGUE CREEK

OWNER/DEVELOPER:

BOARD OF COUNTY COMMISSIONERS FOR WASHINGTON COUNTY, MD AGENT: MARK BRADSHAW, P.E. 16232 ELLIOTT PARKWAY WILLIAMSPORT, MD 21795 TELEPHONE: 240-313-2615 FAX NO.:240-313-2601

ENGINEER:

EA ENGINEERING, SCIENCE, & TECHNOLOGY, INC., PBC CONTACT: REGINA CAGLE IRR, P.E. 225 SCHILLING CIRCLE, SUITE 400 HUNT VALLEY, MARYLAND 21031 TELEPHONE: (410) 584-7000

EA Engineering, Science,

and Technology, Inc., PBC **Hunt Valley Center** 225 Schilling Circle, Suite 400 Hunt Valley, Maryland 21031 (410) 584-7000

DATE: APRIL 2022 PROJECT NUMBER: 1556701

SWM SHEET 1 OF 2

G-001 SHEET: 1 OF 76

SHEET LIST

FARM LANE PUMP STATION EXISTING CONDITIONS / PROPOSED

MAUGANSVILLE ROAD PUMP STATION EXISTING CONDITIONS

MAUGANSVILLE ROAD PUMP STATION PROPOSED SITE PLAN

MAUGANSVILLE ROAD FORCEMAIN ROUTING TO MAUGANS

MAUGANS MEADOWS GRAVITY MAIN ROUTING TO NEW

MAUGANS MEADOWS GRAVITY MAIN ROUTING TO NEW

MAUGANS MEADOWS GRAVITY MAIN ROUTING TO NEW

NEW REGIONAL PUMP STATION ACCESS DRIVEWAY PLAN

NEW REGIONAL PUMP STATION SITE PLAN AND DRIVEWAY PLAN

NEW REGIONAL PROPOSED FORCEMAIN ROUTING STA. 0+00 TO

NEW REGIONAL PROPOSED FORCEMAIN ROUTING STA. 12+50

NEW REGIONAL PROPOSED FORCEMAIN ROUTING STA. 26+00

MAUGANS MEADOWS PUMP STATION EXISTING CONDITIONS /

TITLE SHEET AND LOCATION MAP

GENERAL NOTES AND LEGEND

MEADOWS STA. 0+00 TO 15+00

MEADOWS STA. 15+00 TO 26+00

MEADOWS STA. 38+00 TO 47+00

MEADOWS STA. 47+00 TO 55+12

REGIONAL STA. 27+50 TO 41+90

REGIONAL STA. 12+50 TO 27+50

REGIONAL STA. 0+00 TO 12+50

DRAWING NO. SHEET DRAWING TITLE

G-002

G-003

C-105

C-112

C-137

C-138

C-505

C-506

C-507

DRAWING NO. SHEET DRAWING TITLE NEW REGIONAL PROPOSED FORCEMAIN ROUTING STA. 38+00 NEW REGIONAL PROPOSED FORCEMAIN ROUTING STA. 51+00 C-119 NEW REGIONAL PROPOSED FORCEMAIN ROUTING STA. 65+50 C-120 NEW REGIONAL PROPOSED FORCEMAIN ROUTING STA. 77+50 C-121 NEW REGIONAL PROPOSED FORCEMAIN ROUTING STA. 86+00 C-122 NEW REGIONAL PROPOSED FORCEMAIN ROUTING STA. 100+00 C-123 NEW REGIONAL PROPOSED GRAVITY MAIN ROUTING STA. 0+00 C-124 28 FARM LANE PUMP STATION DETAILS I C-125 C-126 29 FARM LANE PUMP STATION DETAILS II C-127 MAUGANSVILLE ROAD PUMP STATION DETAILS I C-128 MAUGANSVILLE ROAD PUMP STATION DETAILS II C-129 NEW REGIONAL PUMP STATION DETAILS I C-130 NEW REGIONAL PUMP STATION DETAILS II C-131 E&S CONTROL KEY MAP C-132 E&S CONTROL PLAN I C-133 E&S CONTROL PLAN II E&S CONTROL PLAN III C-135 38 E&S CONTROL PLAN IV C-136

E&S CONTROL PLAN V

E&S CONTROL PLAN VII

SEWER MAIN CONNECTION DETAILS I

SEWER MAIN CONNECTION DETAILS II

SEWER MAIN CONNECTION DETAILS III

40 E&S CONTROL PLAN VI

SHEET LIST

SHEET LIST

DRAWING NO. SHEET DRAWING TITLE 45 E&S STANDARD NOTES AND DETAILS I 46 E&S STANDARD NOTES AND DETAILS II 47 E&S STANDARD NOTES AND DETAILS III 48 STORMWATER MANAGEMENT PLAN & DETAILS FARM LANE PUMP STATION ARCHITECTURAL DEMOLITION AND A-101 50 STRUCTURAL NOTES S-001 S-002 51 STRUCTURAL DETAILS FARM LANE PUMP STATION STRUCTURAL DEMOLITION PLANS S-101 FARM LANE VALVE VAULT STRUCTURAL PLANS SECTION &

53 FARM LANE PUMP STATION STRUCTURAL PLAN AND SECTION II MAUGANSVILLE ROAD/NEW REGIONAL PUMP STATION STRUCTURAL PLAN AND SECTION 56 FARM LANE PUMP STATION HVAC DEMOLITION AND NEW PLANS MAUGANSVILLE ROAD PUMP STATION HVAC DEMOLITION AND 58 ELECTRICAL GENERAL NOTES, LEGENDS, AND ABBREVIATIONS

E-001

FARM LANE PUMP STATION ELECTRICAL SITE PLAN DEMOLITION 60 MAUGANSVILLE ROAD PUMP STATION ELECTRICAL SITE PLAN NEW REGIONAL PUMP STATION ELECTRICAL SITE PLAN - I

NEW REGIONAL PUMP STATION ACCESS DRIVEWAY ELECTRICAL SITE PLAN - II 63 FARM LANE PUMP STATION ELECTRICAL DEMOLITION PLAN - I 64 FARM LANE PUMP STATION ELECTRICAL DEMOLITION PLAN - II FARM LANE PUMP STATION ELECTRICAL NEW WORK PLAN -

FARM LANE PUMP STATION UNDERGROUND VAULT NEW WORK

MAUGANSVILLE ROAD PUMP STATION ELECTRICAL DEMOLITION

DETERMINED TO BE APPROXIMATELY 12.8 ± ACRES AND THE TOTAL

APPROXIMATELY 38,600 CU. YDS. OF FILL.

A COMPLETE SET OF APPROVED PLANS AND A COPY OF THE GRADING PERMIT MUST BE ON SITE AND AVAILABLE FOR USE BY THE INSPECTOR, OR OTHER REPRESENTATIVE OF WASHINGTON COUNTY DIVISION OF PUBLIC

SHEET LIST

MAUGANSVILLE ROAD PUMP STATION ELECTRICAL NEW WORK PLAN - CONTROL ROOM FARM LANE PUMP STATION ELECTRICAL ONE LINE DIAGRAM FARM LANE PUMP STATION ELECTRICAL SCHEDULES MAUGANSVILLE PUMP STATION ELECTRICAL ONE LINE DIAGRAM MAUGANSVILLE PUMP STATION ELECTRICAL SCHEDULES AND

E-604 NEW REGIONAL PUMP STATION ELECTRICAL ONE LINE DIAGRAM NEW REGIONAL PUMP STATION ELECTRICAL SCHEDULES AND

75 ELECTRICAL DETAILS I

ELECTRICAL DETAILS II

DISTURBED AREA QUANTITY

THE TOTAL AREA TO BE DISTURBED SHOWN ON THESE PLANS HAS BEEN AMOUNT OF EXCAVATION AND FILL SHOWN ON THESE PLANS HAS BEEN DETERMINED TO BE APPROXIMATELY 47,500 CU. YDS. OF EXCAVATION AND

GENERAL NOTES

- 1. THE INTENT OF THE DRAWINGS AND SPECIFICATIONS IS THAT THE CONTRACTOR SHALL FURNISH ALL LABOR, MATERIALS, TOOLS, EQUIPMENT, AND TRANSPORTATION NECESSARY FOR THE PROPER EXECUTION OF THE WORK IN ACCORDANCE WITH THE STANDARD SPECIFICATIONS AND ALL INCIDENTAL WORK NECESSARY TO COMPLETE THE PROJECT IN AN ACCEPTABLE MANNER, READY FOR USE, OCCUPANCY OR OPERATION BY THE WASHINGTON COUNTY DEPARTMENT OF WATER QUALITY (DEPARTMENT). THE WORK SHALL INCLUDE, BUT IS NOT LIMITED TO, PUMP STATION UPGRADES AT THE FARM LANE AND MAUGANSVILLE ROAD PUMP STATIONS, CONSTRUCTION OF NEW REGIONAL PUMP STATION, AND INSTALLATION OF FORCEMAIN AND GRAVITY MAIN AS NOTED THROUGH THE CONTRACT DRAWINGS.
- 2. PRIOR TO CONSTRUCTION ON A PROJECT, A COMPLETE LIST OF MATERIALS MUST BE SUBMITTED TO THE DEPARTMENT FOR APPROVAL. ONLY THOSE APPROVED MATERIALS SHALL BE UTILIZED ON THE PROJECT. NO SUBSTITUTIONS SHALL BE MADE DURING CONSTRUCTION.
- 3. IN ORDER TO PROPERLY COORDINATE THE INSPECTION SERVICES PROVIDED BY THE DEPARTMENT WITH THE SCHEDULE OF CONSTRUCTION ACTIVITIES, THE DEPARTMENT REQUIRES NOTIFICATION 72 HOURS PRIOR TO CONSTRUCTION. SHOULD THE CONTRACTOR DELAY OPERATING FOR A PERIOD OF TIME, THE DEPARTMENT SHALL REQUIRE NOTIFICATION 72 HOURS PRIOR TO CONTINUING OPERATIONS.
- 4. WASHINGTON COUNTY OBSERVES THE FOLLOWING LEGAL HOLIDAYS: NEW YEAR'S DAY, MARTIN LUTHER KING'S BIRTHDAY, PRESIDENT'S DAY, GOOD FRIDAY, MEMORIAL DAY, JUNETEENTH DAY, INDEPENDENCE DAY, LABOR DAY, VETERAN'S DAY, THANKSGIVING DAY, FRIDAY AFTER THANKSGIVING, CHRISTMAS EVE, CHRISTMAS DAY, AND NEW YEAR'S EVE. THE CONTRACTOR SHALL BE PERMITTED TO WORK ON THESE HOLIDAYS ONLY IN EMERGENCY SITUATIONS. SHOULD INSPECTION BY THE DEPARTMENT BE REQUIRED ON ANY OF THESE HOLIDAYS, INSPECTION SERVICES SHALL BE INVOICED AT TWO TIMES THE HOURLY RATE.
- 5. THE 40-HOUR WORK WEEK SHALL BE MONDAY THROUGH FRIDAY. THE CONTRACTOR MUST SUBMIT TO THE DEPARTMENT IN WRITING, AND WITH 48 HOURS ADVANCE NOTICE, ANY REQUEST FOR ADDITIONAL WORK HOURS ABOVE AND BEYOND THE NORMAL 40-HOUR WORK WEEK. SHOULD INSPECTION BY THE DEPARTMENT BE APPROVED IN EXCESS OF THE NORMAL WORK HOURS, INSPECTION SERVICES SHALL BE INVOICED AT ONE TIMES THE HOURLY RATE.
- 6. ALL WORK THAT MAY BE CALLED FOR IN THE SPECIFICATIONS AND NOT SHOWN ON THE DRAWINGS OR SHOWN ON THE DRAWINGS AND NOT CALLED FOR IN THE SPECIFICATIONS SHALL BE EXECUTED AND FURNISHED BY THE CONTRACTOR, AS IF DESCRIBED IN BOTH THESE WAYS; AND SHOULD ANY WORK OR MATERIAL BE REQUIRED, WHICH IS NOT DEFINED IN THE SPECIFICATIONS OR DRAWINGS EITHER DIRECTLY OR INDIRECTLY, BUT WHICH IS NEVERTHELESS NECESSARY FOR THE PROPER EXECUTION OF THE INTENT THEREOF, THE CONTRACTOR IS TO UNDERSTAND THE THINGS TO BE IMPLIED AND REQUIRED, AND SHALL PERFORM ALL SUCH WORK AND FURNISH ANY SUCH MATERIAL AS FULLY AS IF THEY WERE PARTICULARLY DELINEATED OR DESCRIBED.
- 7. ANY DISCREPANCIES FOUND BETWEEN THE DRAWINGS AND THE SPECIFICATIONS AND SITE CONDITIONS OR ANY INCONSISTENCIES OR AMBIGUITIES IN THE DRAWINGS OR SPECIFICATIONS SHALL BE IMMEDIATELY REPORTED TO THE DEPARTMENT, IN WRITING. WORK PERFORMED BY THE CONTRACTOR AFTER DISCOVERY OF SUCH DISCREPANCIES, INCONSISTENCIES OR AMBIGUITIES WITHOUT REPORTING TO THE DEPARTMENT, SHALL BE PERFORMED AT THE CONTRACTOR'S RISK.
- 8. THE DEPARTMENT, THEIR REPRESENTATIVES AND THE REPRESENTATIVES OF ANY GOVERNMENTAL BODY OR AGENCY HAVING JURISDICTION WILL AT ALL TIMES HAVE ACCESS AND OBSERVATION TO THE WORK. CONTRACTOR SHALL PROVIDE PROPER AND SAFE FACILITIES FOR SUCH ACCESS AND OBSERVATION OF THE WORK AND ALSO FOR ANY INSPECTION OR TESTING THEREOF BY OTHERS. NO WORK WILL BE PERFORMED WITHOUT THE DEPARTMENT HAVING NOTICE THEREOF AND ALL WORK SHALL BE SUBJECT TO INSPECTION BY THE DEPARTMENT.
- 9. THE CONSTRUCTION DRAWINGS ARE NOT TO BE CONSIDERED AS ALL INCLUSIVE. THEY DO NOT INDICATE EVERY FITTING, ELBOW, OFFSET, VALVE, ETC., WHICH WILL BE REQUIRED TO COMPLETE THE JOB. THE CONTRACTOR SHALL PREPARE SHOP DRAWINGS, AS REQUIRED FOR THE USE OF CONTRACTOR'S MECHANICS, TO ENSURE PROPER INSTALLATION.
- 10. IF ANY WORK IS COVERED CONTRARY TO THE WRITTEN REQUEST OF DEPARTMENT OR WITHOUT THE DEPARTMENT'S HAVING TIMELY WRITTEN NOTICE THAT SUCH WORK IS BEING PERFORMED, IT MUST, IF REQUESTED BY DEPARTMENT, BE UNCOVERED FOR THE DEPARTMENT'S OBSERVATION AND REPLACED AT CONTRACTOR'S EXPENSE.
- 11. IF ANY WORK, THE PERFORMANCE OF WHICH THE DEPARTMENT HAS GIVEN WRITTEN NOTICE, HAS BEEN COVERED WITHOUT THE DEPARTMENT OBSERVING IT PRIOR TO ITS BEING COVERED, OR IF DEPARTMENT OR OWNER'S OR OWNER'S REPRESENTATIVE CONSIDERS IT NECESSARY OR ADVISABLE THAT COVERED WORK BE INSPECTED OR TESTED BY OTHERS, CONTRACTOR, AT DEPARTMENT'S REQUEST, SHALL UNCOVER, EXPOSE OR OTHERWISE MAKE AVAILABLE FOR OBSERVATION, INSPECTION OR TESTING AS DEPARTMENT MAY REQUIRE, THAT PORTION OF THE WORK IN QUESTION, FURNISHING ALL NECESSARY LABOR, MATERIAL AND EQUIPMENT.
- 12. THE ENGINEER WILL ISSUE, WITH REASONABLE PROMPTNESS, SUCH WRITTEN CLARIFICATIONS OR INTERPRETATIONS OF THE STANDARD SPECIFICATIONS AS HE OR SHE MAY DETERMINE NECESSARY, WHICH SHALL BE CONSISTENT WITH OR REASONABLY INFERABLE FROM THE OVERALL INTENT OF THE PROJECT.
- 13. THE DEPARTMENT'S REPRESENTATIVE WILL HAVE AUTHORITY TO DISAPPROVE OR REJECT WORK WHICH IS "DEFECTIVE" (WHICH TERM IS HEREINAFTER USED TO DESCRIBE WORK THAT IS UNSATISFACTORY, FAULTY OR DEFECTIVE), DOES NOT CONFORM TO THE REQUIREMENTS OF THE STANDARD SPECIFICATIONS, OR HAS BEEN DAMAGED PRIOR TO APPROVAL OF FINAL PAYMENT. THE DEPARTMENT'S REPRESENTATIVE WILL ALSO HAVE AUTHORITY TO REQUIRE SPECIAL INSPECTION OR TESTING OF THE WORK WHETHER OR NOT THE WORK IS FABRICATED, INSTALLED OR COMPLETED.
- 14. DEPARTMENT WILL NOT BE RESPONSIBLE FOR CONTRACTOR'S MEANS, METHODS, TECHNIQUES, SEQUENCES OR PROCEDURES OF CONSTRUCTION, OR THE SAFETY PRECAUTIONS AND PROGRAMS INCIDENT THERETO; AND DEPARTMENT DOES NOT GUARANTEE THE PERFORMANCE OF THE WORK IN ACCORDANCE WITH THE CONTRACT DOCUMENTS.
- 15. DEPARTMENT WILL NOT BE RESPONSIBLE FOR THE ACTS OR OMISSIONS OF CONTRACTOR, OR ANY SUBCONTRACTORS, OR ANY OF THEIR AGENTS OR EMPLOYEES, OR ANY OTHER PERSONS AT THE SITE OR OTHERWISE PERFORMING ANY OF THE WORK.
- 16. ALL WORK REQUIRING CHANGES TO OR AFFECTING EXISTING UTILITIES, OR AFFECTING THEIR OPERATION, SHALL BE PERFORMED IN A MANNER AND TIME APPROVED BY THE DEPARTMENT. REQUESTS TO DO SUCH WORK SHALL BE SUBMITTED TO THE DIVISION AT LEAST THREE (3) CALENDAR DAYS PRIOR TO THE TIME THAT SUCH WORK IS TO BE PERFORMED.
- 17. THE CONTRACTOR WILL BE RESPONSIBLE FOR LOCATING ALL EXISTING UTILITIES INCLUDING, BUT NOT LIMITED TO, WATER, STEAM, OIL, GAS MAINS, SANITARY AND STORM SEWERS, TELEPHONE AND ELECTRIC CONDUITS WHICH MAY BE ENCOUNTERED IN THE PERFORMANCE OF THE WORK. THE CONTRACTOR WILL ALSO BE RESPONSIBLE FOR LOCATING ALL UNDERGROUND STRUCTURES. THE CONTRACTOR SHALL, AT CONTRACTOR'S OWN EXPENSE, ARRANGE WITH THE OWNERS OF SUCH UTILITIES FOR LOCATING THEM. THE CONTRACTOR SHALL BE RESPONSIBLE FOR PROVIDING ADEQUATE PROTECTION AGAINST DAMAGE TO UTILITIES ENCOUNTERED DURING THE COURSE OF CONSTRUCTION.
- 18. ROCK IS EXPECTED TO BE ENCOUNTERED DURING EXCAVATION. CONTRACTOR TO ADHERE TO ROCK REMOVAL REQUIREMENTS AND SPECIFICATIONS. THE CONTRACTOR SHALL GIVE NOTICE TO THE DEPARTMENT AND STATE FIRE MARSHALL PRIOR TO USING ANY EXPLOSIVES. SUCH EXPLOSIVES SHALL BE STORED, HANDLED AND USED AS PRESCRIBED BY THE FEDERAL, STATE AND/OR LOCAL AUTHORITIES HAVING JURISDICTION OVER SUCH STORAGE AND USE. THE CONTRACTOR SHALL COMPLY WITH ALL SPECIAL RULES AND REGULATIONS THAT MAY BE IN EFFECT AT THE TIME THE WORK IS ACTUALLY DONE. THE CONTRACTOR SHALL OBTAIN THE PERMISSION OF THE STATE FIRE MARSHAL BEFORE STORING AND USING ANY EXPLOSIVES.
- 19. THE CONTRACTOR SHALL AT ALL TIMES TAKE NECESSARY STEPS TO PROTECT AND PRESERVE ALL MATERIALS, SUPPLIES, EQUIPMENT AND WORK WHICH HAS BEEN PERFORMED. SHOULD WORK BE SUSPENDED TEMPORARILY BECAUSE OF INCLEMENT WEATHER OR OTHER CAUSES, THE CONTRACTOR SHALL TAKE SUCH STEPS AS ARE NECESSARY TO PROTECT MATERIALS, SUPPLIES, EQUIPMENT AND WORK PERFORMED. WORK NOT PROPERLY PROTECTED SHALL BE REMOVED AND REPLACED AT THE EXPENSE OF THE CONTRACTOR.
- 20. CONTRACTOR SHALL BE RESPONSIBLE FOR INITIATING, MAINTAINING AND SUPERVISING ALL SAFETY PRECAUTIONS AND PROGRAMS IN CONNECTION WITH THE WORK. CONTRACTOR SHALL TAKE ALL NECESSARY PRECAUTIONS FOR THE SAFETY OF, AND SHALL PROVIDE THE NECESSARY PROTECTION TO PREVENT DAMAGE, INJURY OR LOSS TO: ALL EMPLOYEES ON THE WORK AND OTHER PERSONS WHO MAY BE AFFECTED THEREBY; ALL THE WORK AND ALL MATERIALS OR EQUIPMENT TO BE INCORPORATED THEREIN, WHETHER IN STORAGE ON OR OFF THE SITE; AND OTHER PROPERTY AT THE SITE OR ADJACENT THERETO, INCLUDING UTILITIES NOT DESIGNATED FOR REMOVAL, RELOCATION OR REPLACEMENT IN THE COURSE OF CONSTRUCTION.
- 21. CONTRACTOR SHALL COMPLY WITH ALL APPLICABLE LAWS, ORDINANCES, RULES, REGULATIONS AND ORDERS OF ANY PUBLIC BODY HAVING JURISDICTION FOR THE SAFETY OF PERSONS OR PROPERTY OR TO PROTECT THEM FROM DAMAGE. INJURY OR LOSS.

- 22. ALL FORCEMAINS AND SANITARY SEWERS SHALL BE CONSTRUCTED IN STRICT ACCORDANCE WITH THE LATEST EDITION OF THE WASHINGTON COUNTY DEPARTMENT OF WATER QUALITY'S STANDARD SPECIFICATIONS AND CONTRACT DOCUMENTS.
- 23. CONTRACTOR SHALL NOTIFY MISS UTILITY AT LEAST 72 HOURS PRIOR TO ANY EXCAVATION TO HAVE UNDERGROUND UTILITIES MARKED. UTILITIES SHOWN HEREON ARE APPROXIMATE AND WERE OBTAINED FROM FIELD RUN SURVEY AND AVAILABLE WASHINGTON COUNTY GIS DATA.
- 24. A PRE-CONSTRUCTION MEETING SHALL BE HELD 48 HOURS PRIOR TO THE COMMENCEMENT OF ANY WORK. ALL UTILITY COMPANIES SHALL BE NOTIFIED BY THE CONTRACTOR TO HAVE ALL UTILITIES MARKED PRIOR TO
- 25. UTILITY OUTAGES SUCH AS WATER, GAS, COMMUNICATIONS, AND ELECTRIC MAY BE REQUIRED. CONTRACTOR IS REQUIRED TO COORDINATE WITH ALL PROVIDERS FOR REPAIR OR SCHEDULED SHUT DOWN.
- 26. ALL WORK IS TO BE PERFORMED WITHIN THE RIGHT OF WAYS AND WITHIN ANY SEWER EASEMENTS. ALL OTHER WORK OUTSIDE OF THESE AREAS WILL REQUIRE COORDINATION WITH THE DEPARTMENT FOR APPROVED PROCEDURES, ACCESS, AND PERMISSIONS.
- 27. ALL WORK TO BE PERFORMED WITHIN WASHINGTON COUNTY PUBLIC RIGHT OF WAY OTHER THAN STATE HIGHWAY ADMINISTRATION PROPERTY SHALL BE IN STRICT ACCORDANCE WITH THE CONDITIONS OF THE SPECIAL UTILITY INSTALLATION PERMIT ISSUED BY WASHINGTON COUNTY. ALL WORK TO BE PERFORMED ON MARYLAND STATE HIGHWAY ADMINISTRATION (SHA) PROPERTY SHALL BE IN STRICT ACCORDANCE WITH THE CONDITIONS OF THE ACCESS AND CONSTRUCTION PERMIT ISSUED BY SHA.
- 28. CONTRACTOR IS RESPONSIBLE FOR ALL TRAFFIC CONTROL NECESSARY DURING COMPLETION OF THE WORK.
 TRAFFIC CONTROL SHALL CONFORM TO THE MARYLAND MANUAL ON UNIFORM TRAFFIC CONTROL DEVICES
 (MUTCD)
- 29. IT IS CRITICAL TO MAINTAIN PUMP STATION IN OPERATION AS NOTED ON INDIVIDUAL PUMP STATION SITE PLANS. CONTRACTOR SHALL PREPARE A PLAN FOR PUMP STATION CONSTRUCTION SEQUENCE AND BYPASS OPERATIONS NECESSARY TO CONTINUE TO CONVEY WASTEWATER THROUGHOUT THE DURATION OF THE WORK AS NOTED. CONTRACTOR SHALL SUBMIT PLAN TO COUNTY FOR REVIEW AND APPROVAL PRIOR TO INITIATION OF ANY WORK. PLAN SHALL IDENTIFY THE ESTIMATED DURATION OF NECESSARY PUMP STATION SHUT DOWNS AND BYPASS OPERATIONS.
- 30. THE CONTRACTOR IS RESPONSIBLE TO DRAIN ALL SEWAGE FROM PIPES TO BE ABANDONED AS WELL AS CONNECTIONS TO THE EXISTING SYSTEMS; AND PROVIDE ALL REQUIRED MANPOWER, EQUIPMENT, AND DISPOSAL. CONTRACTOR SHALL HAVE EQUIPMENT ONSITE TO ADDRESS THE REMOVAL OF SEWAGE FROM THE LINE. AT NO TIME IS SEWAGE PERMITTED TO ENCOUNTER THE GROUND.
- 31. DURING CONSTRUCTION CONTRACTOR SHALL NOT ALLOW SEWAGE TO BE RELEASED ONTO THE GROUND. CONTRACTOR IS RESPONSIBLE TO PROVIDE EQUIPMENT, MATERIALS, AND LABOR TO SAFELY COLLECT, STORE, PUMP, TRANSPORT, AND BYPASS SEWAGE ENCOUNTERED AND AS NECESSARY FOR COMPLETION OF THE WORK AS DETAILED IN THESE CONTRACT DOCUMENTS. FOR THE CONTRACTOR'S REFERENCE, AVERAGE AND PEAK DAILY WASTEWATER FLOWS FOR EACH PUMP STATION ARE SUMMARIZED THIS SHEET.
- 32. EXISTING FENCING MUST BE MAINTAINED AT ALL TIMES. TEMPORARY FENCING MAY BE CONSTRUCTED AT CONTRACTOR'S EXPENSE AS NECESSARY.
- 33. FIELD RUN SURVEY COLLECTED BY FREDERICK, SEIBERT, & ASSOCIATES, INC. BASED ON SURVEY COLLECTION IN DECEMBER 2018 AND JANUARY 2019 AND IN JANUARY 2020. HORIZONTAL SURVEY DATUM IN MARYLAND NAD83 AND VERTICAL DATUM IN MARYLAND NAVD88.
- 34. CONTRACTOR IS RESPONSIBLE FOR ALL DEWATERING AND ASSOCIATED PERMITTING TO DISCHARGE AS NECESSARY TO COMPLETE THE WORK.
- 35. CONTRACTOR IS RESPONSIBLE FOR ALL ACTIVITIES RELATING TO CONFINED SPACE ENTRY, REQUIRED PERMITS, TRAINED PERSONNEL AND EQUIPMENT AS REQUIRED BY OSHA AND COUNTY REQUIREMENTS.
- 36. THE DEPARTMENT SHALL INSPECT ALL FACILITIES DURING CONSTRUCTION TO ENSURE CONFORMANCE TO DESIGN AND SPECIFICATIONS.
- 37. THE CONTRACTOR IS RESPONSIBLE FOR OBTAINING ALL PERMITS NECESSARY FOR THE PROJECT, PRIOR TO THE START OF CONSTRUCTION. A COPY OF THESE PERMITS SHALL BE SUPPLIED TO THE DEPARTMENT OF WATER QUALITY PRIOR TO START OF CONSTRUCTION. THE CONTRACTOR IS RESPONSIBLE FOR PAYING ALL FEES ASSOCIATED WITH OBTAINING NECESSARY CONSTRUCTION PERMITS.
- 38. THE CONTRACTOR SHALL COMPLY WITH ALL PERMITS AND APPLICABLE CODES AND REGULATIONS.
- 39. UPON ACCEPTANCE OF THE SYSTEM BY THE DEPARTMENT OF WATER QUALITY, THE CONTRACTOR SHALL WARRANTY ALL WORK FROM DATE OF ACCEPTANCE FOR A PERIOD OF ONE YEAR.
- 40. CONTRACTOR IS RESPONSIBLE TO REMOVE AND REPLACE ANY SHRUBBERY AND TREES LOCATED WITHIN THE RIGHT OF WAY, IN ACCORDANCE WITH CONTRACT DOCUMENTS.
- 41. JACK AND BORE REQUIRED AT VARIOUS LOCATIONS THROUGHOUT THE PROJECT. SENDING AND RECEIVING PITS SHOWN IN CONTRACT DOCUMENTS ARE FOR THE CONTRACTOR'S REFERENCE ONLY. CONTRACTOR SHALL ESTABLISH JACK AND BORE PITS AS NEEDED TO COMPLETE THE WORK AND SHALL MINIMIZE THE SIZE OF PITS AND RELATED DISTURBANCE. ANY BORE PIT ESTABLISHED MUST REMAIN WITHIN THE LOD AND/OR EXISTING UTILITY EASEMENTS SHOWN ON PLANS.
- 42. FOREST CONSERVATION REQUIREMENTS FOR THIS PROJECT ARE BEING MET OFF-SITE BY COUNTY IN ACCORDANCE WITH FOREST RETENTION EASEMENT PLAT DEVELOPED BY FSA DATED 07-27-2020, MISC PLAT NO. 934 APPROVED BY WASHINGTON COUNTY ON 22 APRIL 2022.

		SANITARY	SEVVER IVIAIN	HOLL SCHL	DOLL		
MANHOLE NO.	MANHOLE DIA. (IN)	NORTHING	EASTING	RIM ELEVATION	PIPE OUT	PIPE IN	INVERT ELEVATION
DMH SD 15-701	48"	N 741942.17	E 1110060.80	644.95	8"	8"	633.1 ±
DMH SD 15-100	48"	N 737466.47	E 1102486.46	604.16	15" (NE)		589.87 (NE)
MH 150-1739	48"	N 735386.40	E 1100320.99	583.69	8" (S)	8" (NW)	569.63 (S) 569.73 (NW)
MH 150-1738	60"	N 735363.47	E 1100325.21	582.68	15" (SW)	8" (N) 16" (SE)	568.83 (SW) 569.51 (N) 568.93 (SE)
MH 15-1151	48"	N 735451.88	E 1100237.69	581.80	8" (SW)	15" (NW)	570.58 (SW) 570.10 (NW)
MH 15-1152	60"	N 735439.43	E 1100230.03	581.69	8" (SW)	8" (N E)	570.41 (SW) 570.51 (NE)
MH 150-1737	48"	N 735166.32	E 1100217.22	581.42	15" (SW)	15" (N E)	567.62 (SW) 567.72 (NE)
MH 150-1740	48"	N 735431.26	E 1100225.33	581.10	8" (SE)	8" (N E)	570.26 (SE) 570.36 (NE)
MH 150-1736	48"	N 734945.37	E 1100100.01	578.92	15" (S)	15" (NE)	566.28 (S) 566.38 (NE)
MH 150-1735	48"	N 734731.48	E 1100026.94	577.44	15" (SW)	15" (N) 8" (E)	565.06 (SW) 565.16 (N) 565.80 (E)
MH 150-1734	48"	N 734462.38	E 1099869.58	572.90	15" (SW)	15" (N E)	563.40 (SW) 563.50 (NE)
MH 150-1733	48"	N 734193.30	E 1099712.24	570.27	15" (S W)	15" (NE) 8" (SE)	561.75 (SW) 561.85 (NE) 562.50 (SE)
MH 150-1732	48"	N 733812.71	E 1099487.06	566.78	15" (SW)	15" (NE)	559.45 (SW) 559.55 (NE)
MH 150-1731	48"	N 733597.18	E 1099188.71	565.40	15" (SW)	15" (NE)	557.50 (SW) 557.60 (NE)
MH 180-393	60"	N 723941.08	E 1097759.83	564.19	15" (S)	8" (W) 8" (E) 16" (N)	556.50 (S) 557.11 (W) 557.11 (E) 556.60 (N)
MH 150-1730	48"	N 733337.06	E 1099073.09	563.86	15" (SW)	15" (NE) 8" (NW) 8" (SE)	556.08 (NE) 555.98 (SW) 556.70 (NW) 556.70 (SE)
MH 180-392	48"	N 723709.13	E 1097776.08	562.85	15" (S)	15" (N) 8" (E)	554.08 (S) 554.18 (N) 554.80 (E)
MH 150-1729	48"	N 733076.93	E 1098957.46	562.16	15" (S)	15" (N E) 8" (W) 8" (E)	554.45 (S) 554.55 (NE) 555.20 (W) 555.20 (E)
MH 150-1728	48"	N 732824.94	E 1098877.45	559.44	15" (S)	15" (N) 8" (W) 8" (E)	553.02 (S) 553.12 (N) 553.80 (W) 553.80 (E)
MH 150-1726	48"	N 732097.81	E 1098676.47	558.60	15" (S)	15" (N) 8" (W) 8" (E)	548.70 (S) 548.80 (N) 549.40 (W) 549.40 (E)
MH 150-1727	48"	N 732441.30	E 1098764.23	556.77	15" (S)	15" (N) 8" (W) 8" (E)	550.68 (S) 550.78 (N) 551.40 (W) 551.40 (E)
MH 180-391	48"	N 723470.44	E 1097798.34	553.94	15" (S)	15" (N) 8" (E) 8" (W)	548.06 (S) 548.16 (N) 548.80 (E) 548.80 (W)
MH 150-1725	48"	N 731848.08	E 1098595.92	553.81	15" (S)	15" (N) 8" (W) 8" (E)	544.39 (S) 544.49 (N) 544.90 (W) 544.90 (E)
MH 180-389	48"	N 723046.71	E 1097689.35	552.84	15" (W)	15" (NE) 8" (E)	540.08 (W) 540.18 (NE) 540.80 (E)
MH 180-390	48"	N 723231.54	E 1097806.73	552.75	15" (SW)	15" (N) 8" (E)	545.57 (SW) 545.67 (N) 546.26 (E)
MH 180-388	60"	N 723057.17	E 1097561.70	551.63	15" (S)	15" (E) 8" (N)	535.87 (S) 536.11 (E) 536.78 (N)
MH 180-370	60"	N 722976.50	E 1097557.34	551.54		15" (N)	533.90 (N)

DESCRIPTION	EXISTING	PROPOSED
BUILDING		NA
CURB		NA
CLEAN OUT	⊗	8
EDGE OF GRAVEL		
EDGE OF DRIVEWAY		NA
EDGE OF PAVEMENT		NA
SANITARY SEWER - EASEMENT		
ELECTRIC LINE	E	Е
ELECTRIC UTILITY MARKING	Ø	NA NA
C & P POLE W/ PHONE BOX	Ω 6	NA
FENCE		x
FIRE HYDRANT	••	NA NA
GAS LINE		NA
GROUND EARTH (ROCKY)	80	NA.
MAILBOX	1903	NA
MINOR CONTOUR	100	100-
INDEX CONTOUR	101	- - - 101-
ISOLATION & AIR RELEASE COMBINATION VALVE	- — — 101— — — — NA	, , , ,
PROPERTY LINE		M NA
RIPRAP		NA
RIGHT-OF-WAY		NA NA
FORCEMAIN W/ FLOW ARROW	FM	FM
SANITARY SEWER GRAVITY MAIN W/ FLOW		,,
ARROW		cs
SANITARY SEWER - MANHOLE	S	•
SHRUB	\bigcirc	NA
SIDEWALK	^	NA
SIGN		NA
STORM PIPE		NA
STORM STRUCTURE		NA
STREAM		NA
SURFACE WATER		NA
TRAFFIC SIGN	-0-	NA
TRAFFIC BARRIER (GUARD RAIL)		NA
TREE LINE	-	,~~~~~~
TREE TELEPHONE LINE	· 😘	NA
	T	NA
WETLAND WETLAND BUFFER	<u> </u>	NA
WATER LINE	ВВ	NA
WATER VALVE		NA
WATER VALVE	•	NA
PUMP STATION BUILDING	(₩)	NA
O.M. OTATION DOILDING		
BOLLARD		
BORING		•
CONCRETE	⊕ B−1	NA
DEMOLITION	1 - 1 - 1 - 1 - 1 - 1 - 1 - 1 - 1 - 1 -	1
	NA NA	
ABANDONED IN PLACE	NA	— X s X —
100-YEAR FLOODPLAIN SILT FENCE	*********	NA
JACK AND BORE PITS	NA	sF
MON AND BONE FITS	NA	\times
CONTRACTORS STAGING AREA	NA	
THEHING CONNECTION	NA NA	Ω.
FLUSHING CONNECTION	NA NA	\bowtie
LATERALS	NA NA	ss
HORIZONTAL BENDS	NA	FM

FLOW TABLE							
EXISTING FLOW CONDITION							
PUMP STATION	AVG. DAILY FLOW (GPD/GPM)	PEAK DAILY FLOW (GPD/GPM)					
FARM LANE	180,360 / 125	721,440 / 500					
MAUGANSVILLE ROAD	153,360 / 106	613,440 / 424					
MAUGANS MEADOWS	44,280 / 31	177,120 / 123					
PROPOSED FLOW CONDITION							
FARM LANE	225,000 / 156	900,000 / 625					
MAUGANSVILLE ROAD	585,000 / 406	2,340,000 / 1,625					
NEW REGIONAL	630,000 / 440	2,520,000 / 1,760					

WASHINGTON COUNTY DEPARTMENT OF ENGINEERING SERVICES
16232 ELLIOTT PARKWAY
WILLIAMSPORT, MD 21795

WASHINGTON COUNTY, MARYLAND
GENERAL NOTES AND LEGEND

CERTIFY THAT THESE DOCUMENTS WERE

PREPARED OR APPROVED BY ME, AND THA

I AM A DULY LICENSED PROFESSIONAL ENGINEER UNDER THE LAWS OF THE STATE

OF MARYLAND, LICENSE NO. 15453

EA Engineering, Science, and Technology, Inc., PBC

Hunt Valley Center
225 Schilling Circle, Suite 400


DATE: APRIL 2022
PROJECT NUMBER: 1556701


G-002

Hunt Valley, Maryland 21031

(410) 584-7000

SHEET: 2 OF 76

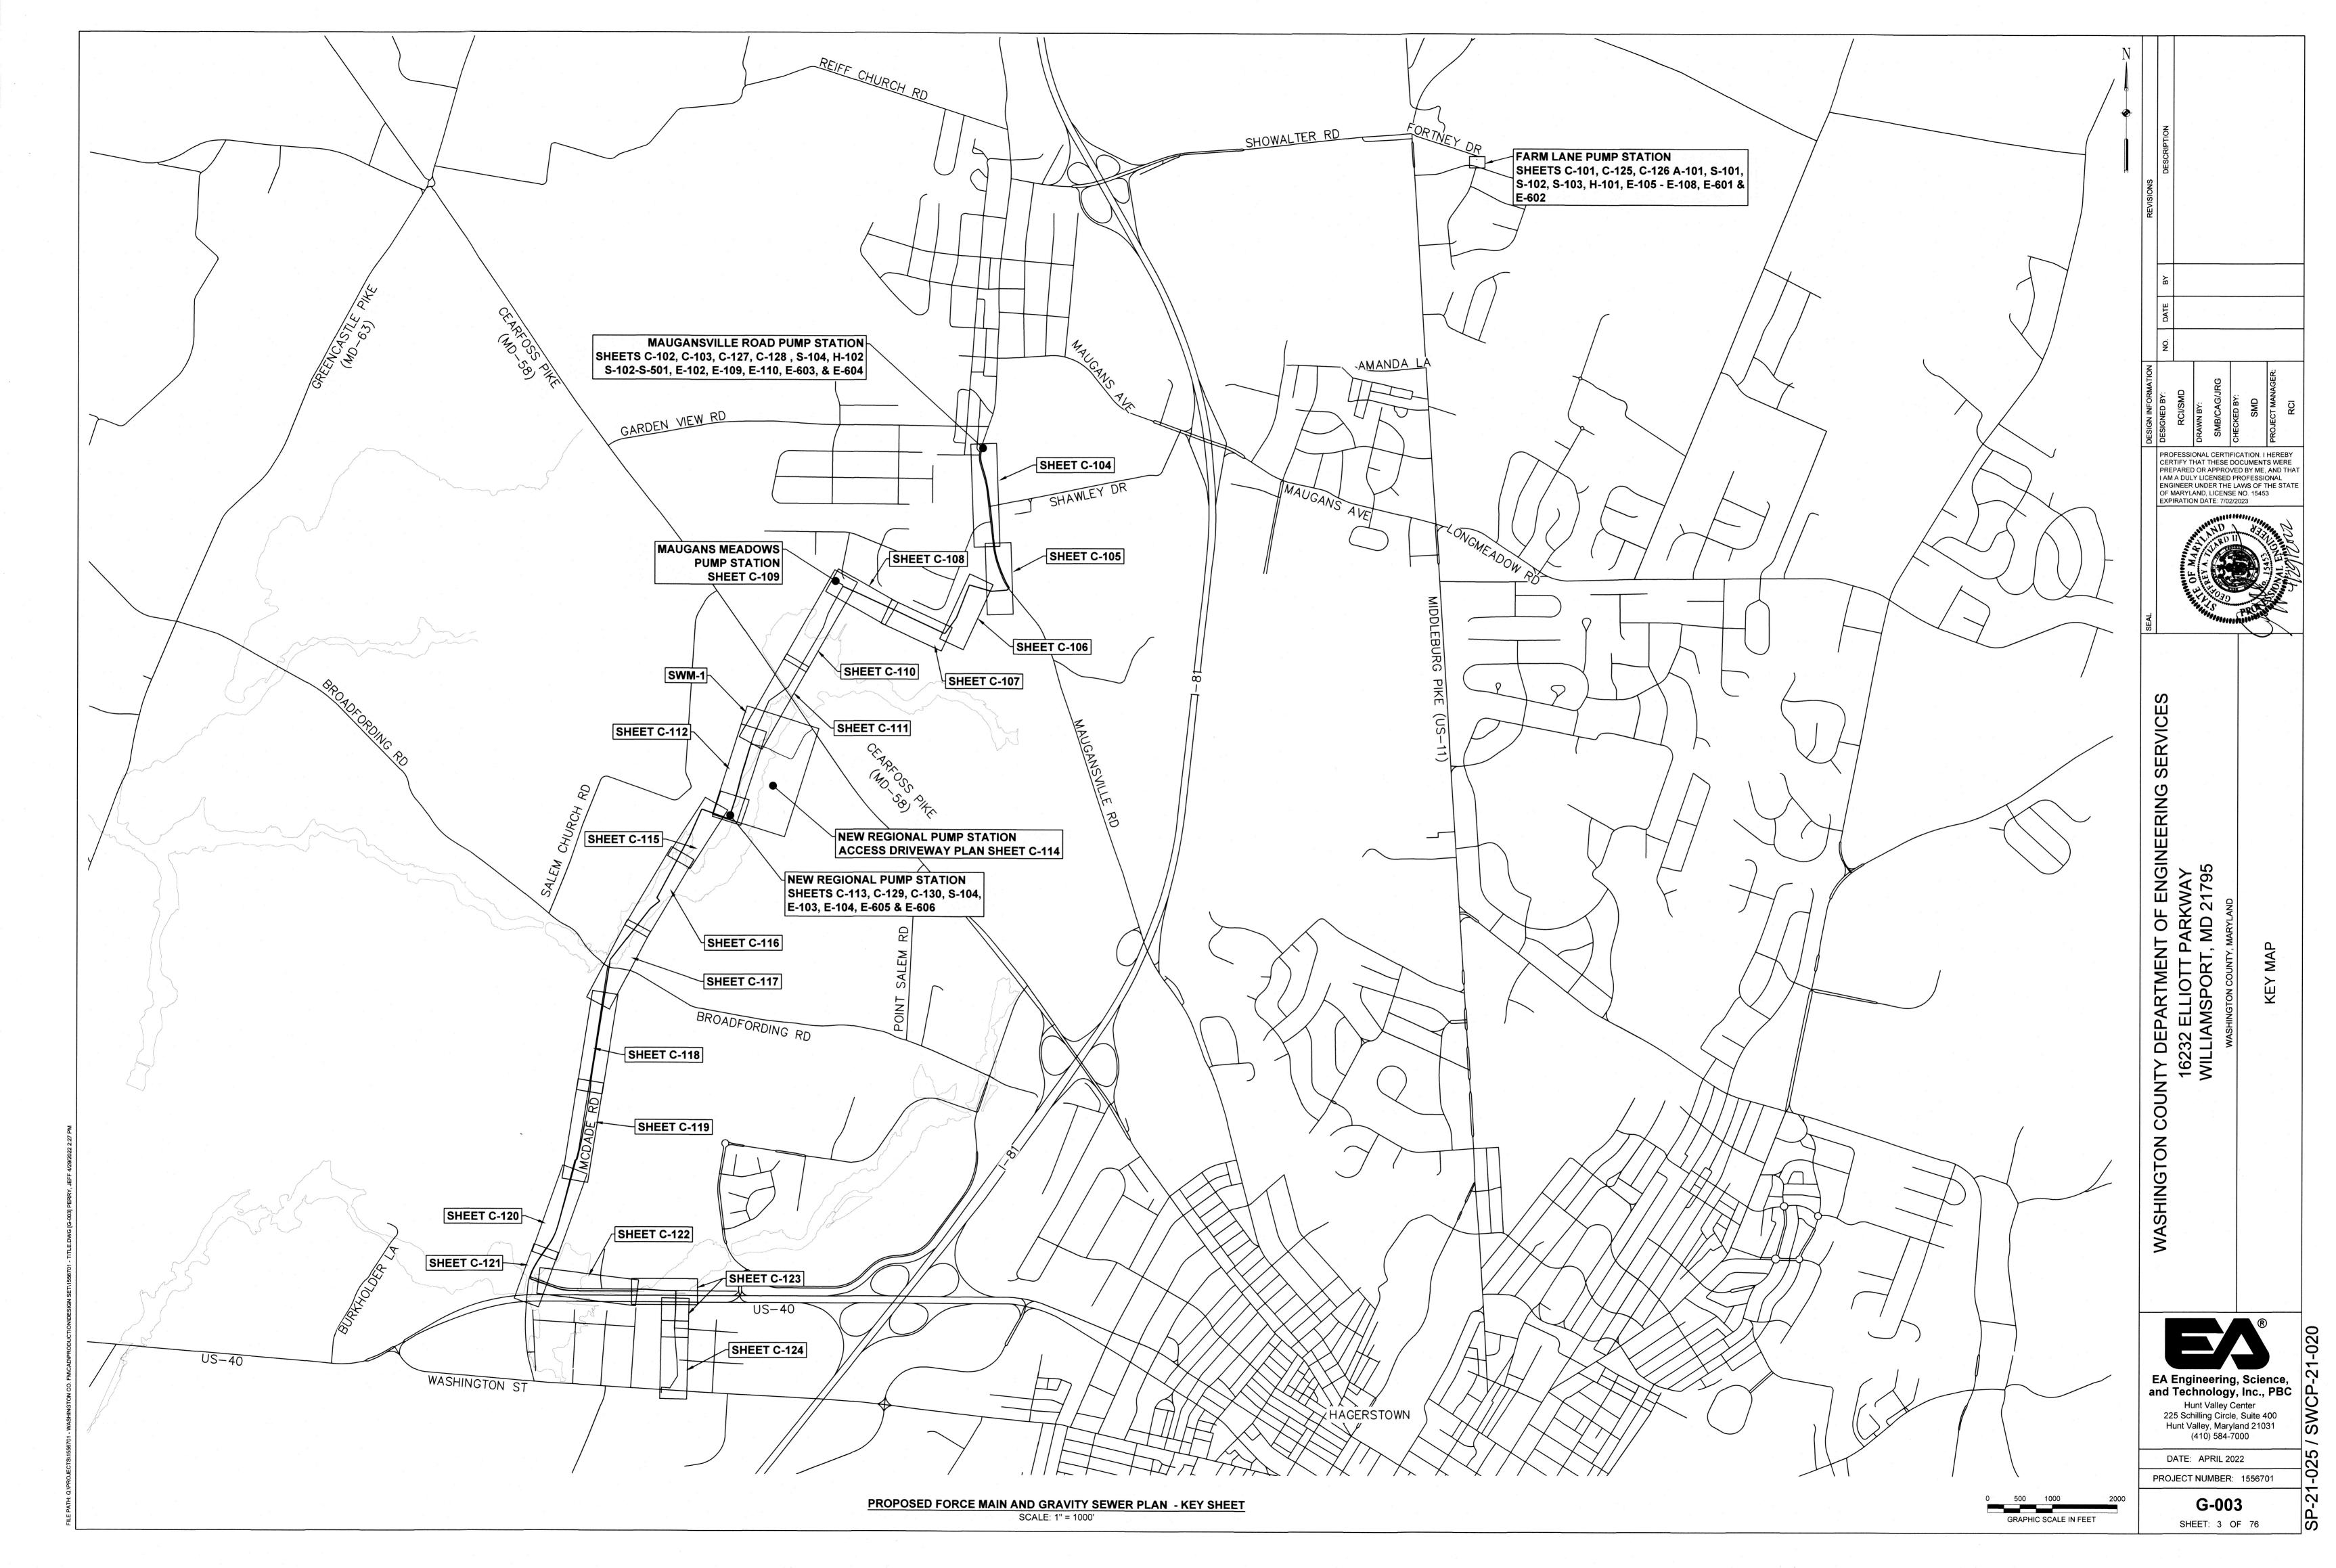

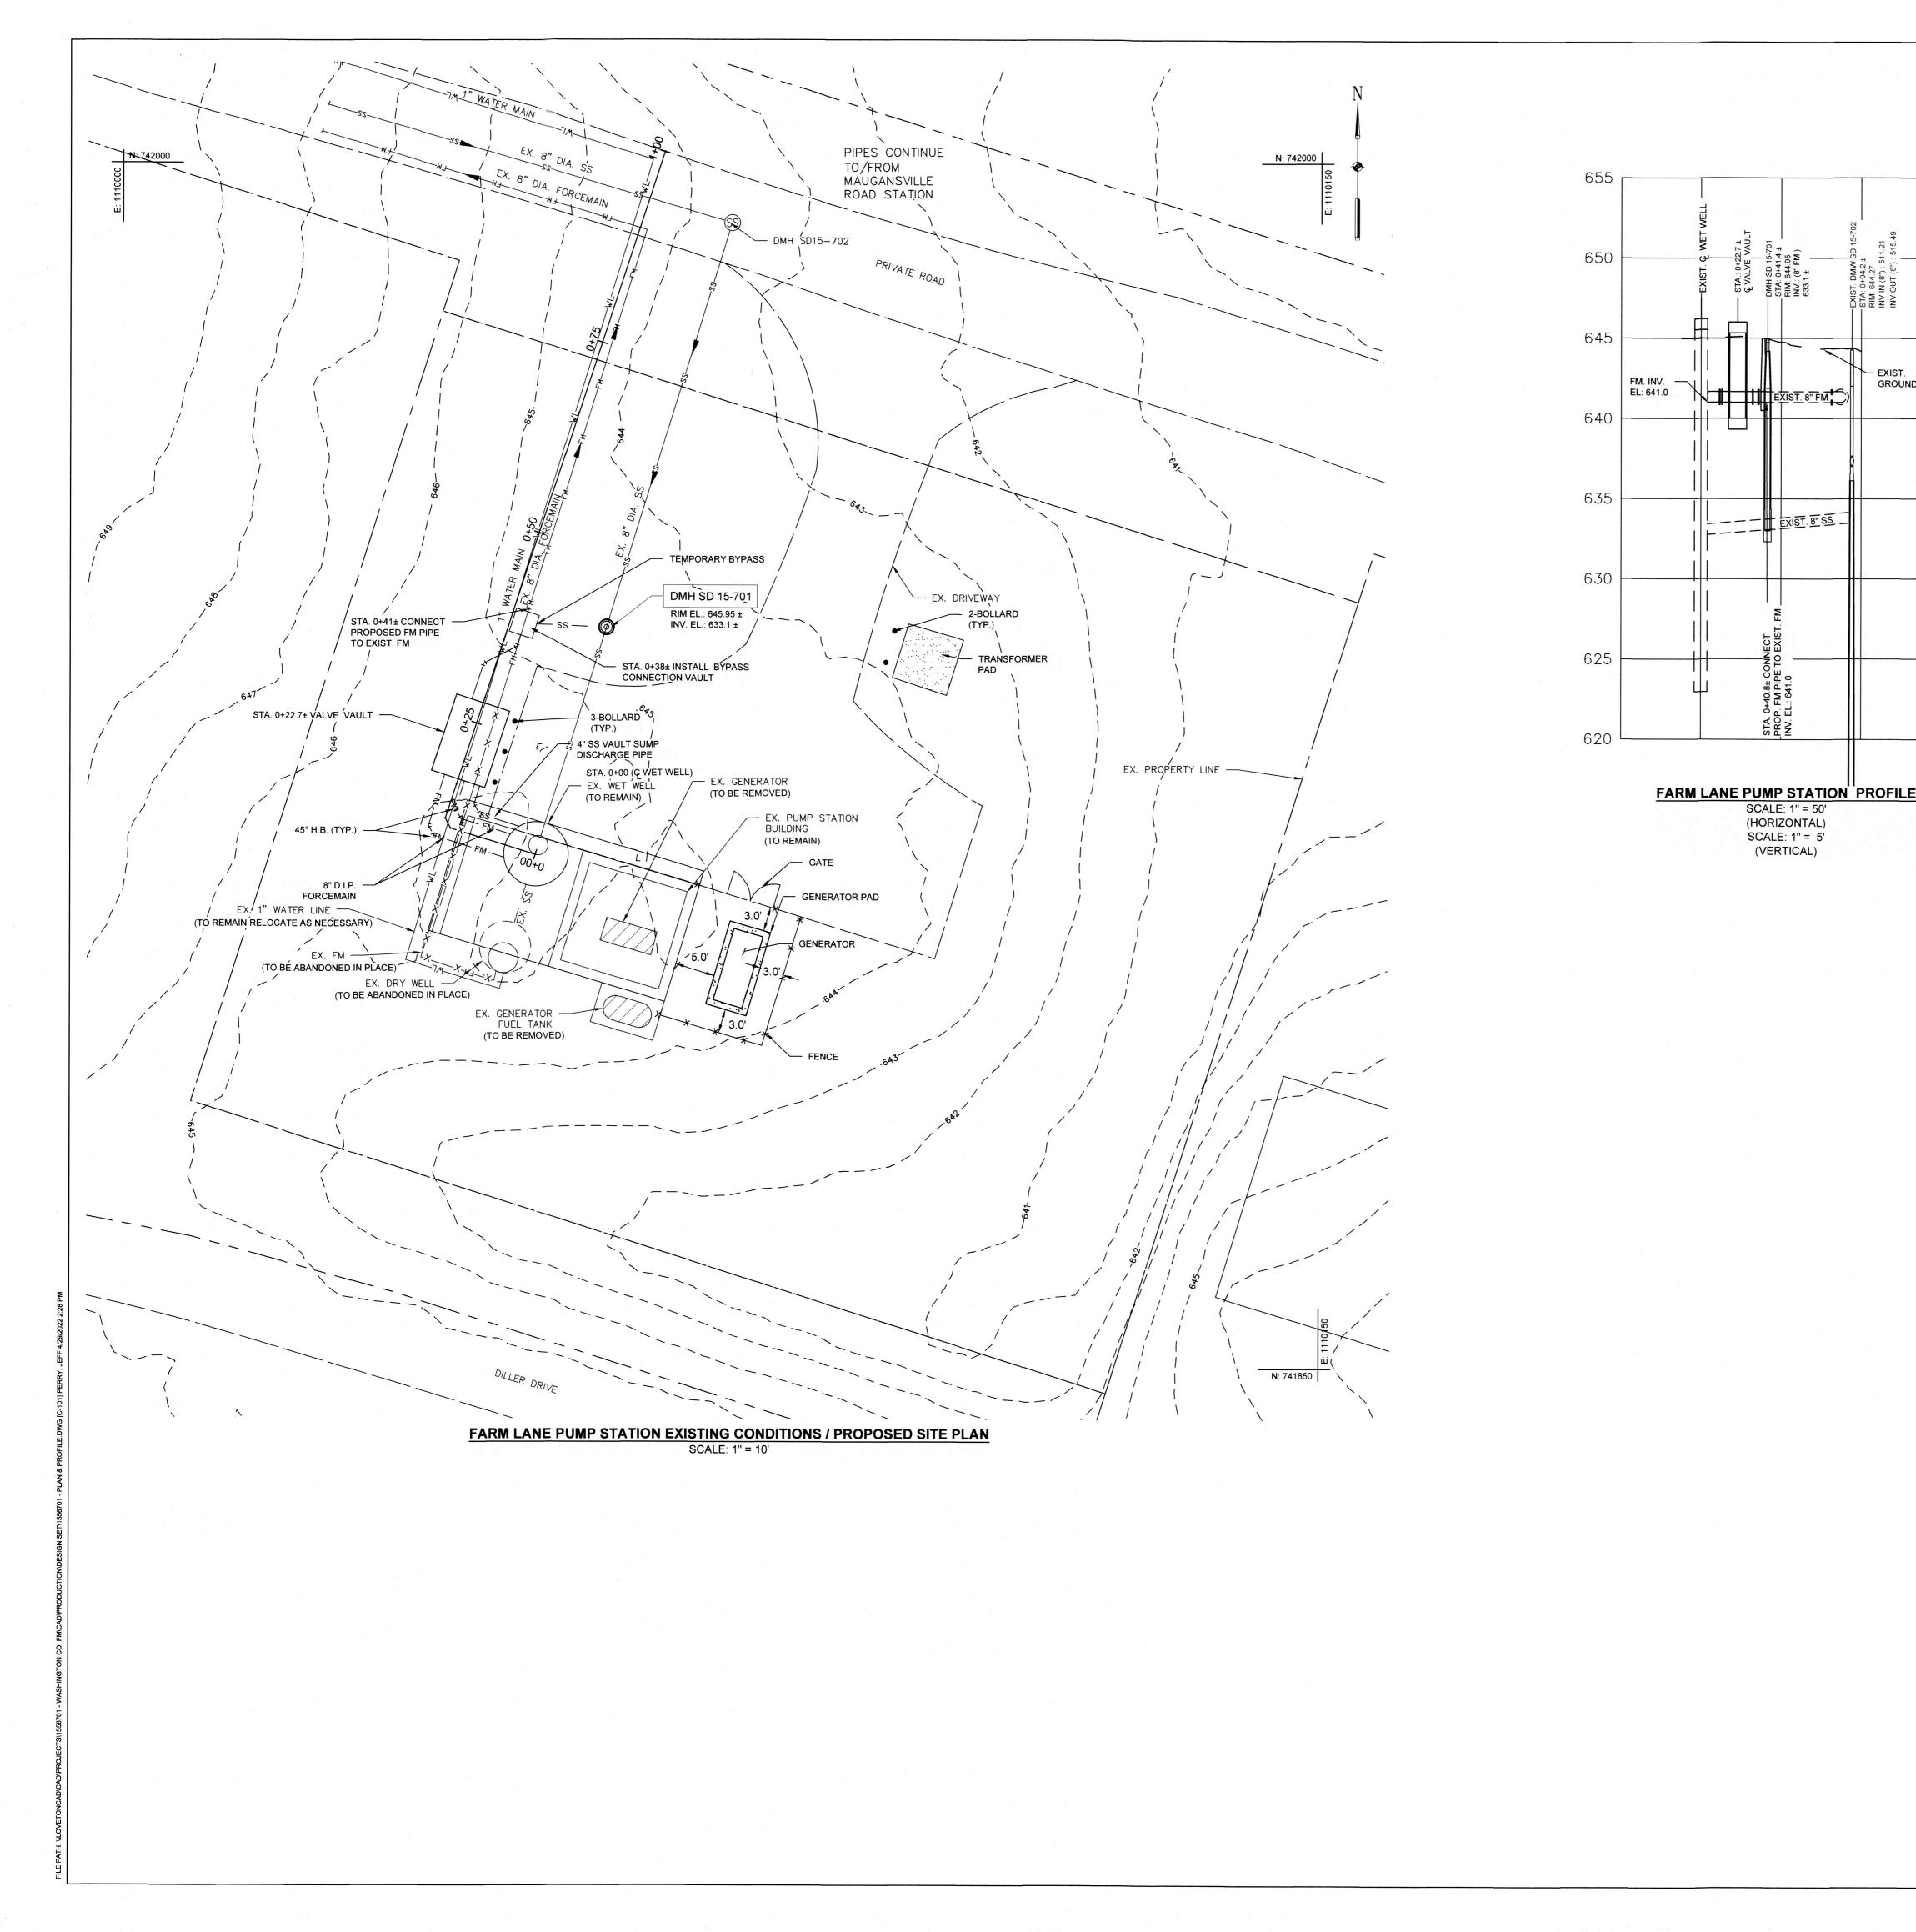

645

635

SCALE: 1" = 50'

(HORIZONTAL)

SCALE: 1" = 5'

(VERTICAL)


- 1. EXISTING CONDITIONS AND TOPOGRAPHY WERE PROVIDED BY FREDERICK, SEIBERT, & ASSOCIATES, INC. BASED ON FIELD RUN SURVEY IN DECEMBER 2018 AND JANUARY 2019, AND WASHINGTON COUNTY GIS DATA.
- 2. EXISTING PUMP STATION BUILDING FEATURES BASED ON RECORD DRAWING DD-601-221 BY GILBERT ASSOCIATES, INC. DATED JUNE 1985. DRAWING REFERENCED IS AN AVAILABLE RECORD DRAWING AND MAY NOT DEPICT AS-BUILT CONDITIONS.
- 3. FOR PUMP STATION ELECTRICAL CONDUIT PLAN AND ONE LINE DIAGRAM DETAILS FOR AS-BUILT ELECTRICAL AND CONTROLS EQUIPMENT, SEE RECORD DRAWINGS DD-601-220 AND DD-601-221 BY GILBERT ASSOCIATES, INC. DATED JUNE 1985. DRAWING REFERENCED IS AN AVAILABLE RECORD DRAWING AND MAY NOT DEPICT AS-BUILT CONDITIONS.
- 4. CONTRACTOR SHALL PROVIDE TEMPORARY BYPASS SYSTEMS TO ALLOW CONTINUED FLOW OF SEWAGE TO THE COUNTY'S COLLECTION SYSTEM. TEMPORARY BYPASS SHALL BE IN PLACE UNTIL ALL SITE UPGRADES ARE COMPLETE, STRUCTURES HAVE BEEN REMOVED AND REPLACED, WATERTIGHT CONNECTION OF ALL PIPING HAS BEEN SECURED, AND ALL DOWNSTREAM CONNECTIONS ARE IN PLACE. CONTRACTOR SHALL MINIMIZE DURATION FOR THE NEED OF TEMPORARY BYPASS. CONTRACTOR MAY PROPOSE ALTERNATE SEQUENCE OF CONSTRUCTION.
- 5. EXISTING PUMP STATION BUILDING TO REMAIN, WITH MODIFICATIONS. SEE DRAWING A-101 FOR DETAILS.
- 6. TWO EXISTING 15 HP FLOODED SUCTION PUMPS AND ALL RELATED APPURTENANCES LOCATED WITHIN EXISTING DRY WELL SHALL BE REMOVED. PUMPS SHALL BE DISCONNECTED FROM EXISTING DISCHARGE OUTLET PIPE.
- 7. EXISTING DRY WELL TO BE ABANDONED IN PLACE. SEE STRUCTURAL DRAWING S-101 FOR STRUCTURE DEMOLITION PLAN AND DETAILS. SEE ELECTRICAL DRAWINGS E-105 AND E-106 FOR ELECTRICAL DEMOLITION.
- 8. FORCEMAIN PIPING BETWEEN EXISTING DRY WELL AND PROPOSED POINT OF CONNECTION TO NEW FORCEMAIN, TO BE ABANDONED IN PLACE, EXISTING FORCEMAIN SHALL BE REMOVED WHERE NECESSARY FOR THE INSTALLATION OF PROPOSED WORK.
- 9. EXISTING WET WELL STRUCTURE SHALL REMAIN, WITH MODIFICATIONS. SEE STRUCTURAL DRAWING S-102 FOR STRUCTURAL PLAN AND DETAILS.
- 10. TWO 50 HP SUBMERSIBLE PUMPS SHALL BE MOUNTED WITHIN WET WELL. INSTALL PUMPS WITHIN WET WELL TO OPERATING CONDITION, INCLUDING, BUT NOT LIMITED TO, PUMPS AND STAND ASSEMBLY, DISCHARGE PIPING, FITTINGS, GUIDE RAILS, VALVES, AND ELECTRICAL CONNECTIONS. SEE DRAWING C-125 FOR PROPOSED PUMP INSTALLATION WITHIN WET WELL.
- 11. SUBMERSIBLE PUMP VALVE PACKAGE SHALL BE INSTALLED WITHIN PROPOSED VALVE VAULT. SEE DRAWING C-126 FOR PROPOSED PUMP STATION VALVE VAULT, DRAWING S-103 FOR VALVE VAULT STRUCTURAL DETAILS, AND DRAWING E-108 FOR VALVE VAULT ELECTRICAL DETAILS.
- 12. PROPOSED MANHOLE SD 15-701 SHALL BE INSTALLED FOR CONTINUOUS FLOW WITHIN EXISTING 8" DIA. SANITARY GRAVITY MAIN. MANHOLE SHALL BE PACKAGED GRINDER MANHOLE, INCLUDING 60" DIA. PRE-FABRICATED FRP. MANHOLE AND ASSEMBLY, 5 HP SUBMERSIBLE GRINDER INSTALLED IN PRE-FORMED CHANNEL, GUIDE RAIL AND CONTROLLER. SYSTEM SHALL BE TASKMASTER GRINDER TM8516 IN FMI GRINDER MANHOLE, OR APPROVED EQUAL. PRODUCT SHALL BE SUBMITTED TO COUNTY FOR REVIEW AND APPROVAL PRIOR TO INSTALLATION.
- 13. FOR SITE ELECTRICAL UPGRADES, SEE DRAWING E-101 FOR ELECTRICAL SITE PLAN AND DRAWING E-107 FOR ELECTRICAL NEW WORK PLAN.
- 14. CONTRACTOR TO COMPLETE SITE WORK IN ACCORDANCE WITH CONTRACT DOCUMENTS AND COUNTY SPECIFICATIONS TO INSTALL A FULLY FUNCTIONAL PUMP STATION AT THE SITE.
- 15. COORDINATE WITH LOCAL POWER COMPANY FOR MODIFICATIONS TO EXISTING ELECTRICAL SERVICE AS INDICATED ON CONTRACT DOCUMENTS.
- 16. FINAL SITE GRADE SHALL MATCH PRE-CONSTRUCTION CONDITIONS, UNLESS OTHERWISE NOTED. ALL DISTURBED AREA SHALL BE PERMANENTLY
- 17. FOR EROSION AND SEDIMENT CONTROLS IN THIS AREA, SEE INSET 1 ON DRAWING C-132.
- 18. CONTRACTOR SHALL COORDINATE WITH THE COUNTY FOR SALVAGE OF PUMPS OR ANY ADDITIONAL EQUIPMENT OR CONTROLS TO BE REMOVED FROM THE PUMP STATION. ALL ITEMS FOR SALVAGE SHALL REMAIN ONSITE FOR COUNTY PICKUP, TO BE COORDINATED DIRECTLY WITH THE COUNTY.

SEQUENCE OF CONSTRUCTION:

- 1. PERFORM PROJECT NOTIFICATIONS AND INSTALLATION OF PERIMETER AND SITE-SPECIFIC EROSION AND SEDIMENT CONTROLS IN ACCORDANCE WITH THE APPROVED EROSION AND SEDIMENT CONTROL PLAN, PRIOR TO INITIATION OF ANY WORK AT THIS SITE. SEE SHEET C-131 FOR OVERALL EROSION AND SEDIMENT CONTROL PLAN.
- 2. INSTALL BYPASS CONNECTION VAULT ON EXISTING FORCEMAIN. SEE DETAIL ON DRAWING C-507.
- INSTALL 60" DIA. MANHOLE AT SD 15-701. ESTABLISH TEMPORARY BYPASS BETWEEN BYPASS CONNECTION VAULT AND SD 15-701.
- 4. AFTER BYPASS IS IN PLACE, DRAIN EXISTING SEWER PIPING DOWNSTREAM OF DMH SD15-702, WET WELL, DRY WELL, AND FORCEMAIN PIPING. PLUG EFFLUENT LINE FROM MANHOLE SD15-702.
- 5. COMPLETE ALL SITE WORK.
- 6. AFTER ALL SITE WORK IS COMPLETE, PERFORM PUMP STATION STARTUP AND
- 7. PUMP STATION SHALL BE INSPECTED BY THE COUNTY FOR ACCEPTANCE. PROVIDE A MINIMUM 48 HOUR NOTICE TO COUNTY FOR SITE INSPECTION.
- 8. AFTER SANITARY SEWER PIPE INSTALLATION AND ALL PIPING CONNECTIONS DOWNSTREAM OF THE MAUGANSVILLE ROAD PUMP STATION HAVE BEEN INSTALLED AND ACCEPTED BY COUNTY, PERFORM 4 HOUR BYPASS SHUTDOWN PERIODS TO PERMANENTLY CONNECT SEWER AND FORCE MAIN PIPING FOR NORMAL STATION OPERATIONS, COORDINATE WITH COUNTY, ALL PUMP STATION EQUIPMENT AND FEATURES, AND CONTROLS SHALL BE OPERATIONAL AND APPROVED BY THE COUNTY PRIOR TO BEING PUT INTO SERVICE.
- 9. OBTAIN SUBSTANTIAL COMPLETION (14-DAY TEST APPROVAL FROM COUNTY). PLACE THE FARM LANE PUMP STATION ONLINE FOR NORMAL OPERATIONS.

10. REMOVE TEMPORARY BYPASS SYSTEM.


11. PERFORM PROJECT NOTIFICATIONS AND REMOVAL OF PERIMETER AND SITE-SPECIFIC EROSION AND SEDIMENT CONTROLS IN ACCORDANCE WITH THE APPROVED EROSION AND SEDIMENT CONTROL PLAN. SEE SHEET C-131 FOR OVERALL EROSION AND SEDIMENT CONTROL PLAN.

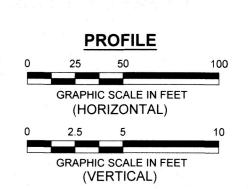

FARM LANE PUMP STATION 14135 PENNSYLVANIA AVENUE, HAGERSTOWN, MD 21742



CERTIFY THAT THESE DOCUMENTS WERE PREPARED OR APPROVED BY ME, AND THAT I AM A DULY LICENSED PROFESSIONAL ENGINEER UNDER THE LAWS OF THE STATE OF MARYLAND, LICENSE NO. 15453 EXPIRATION DATE: 7/02/2023

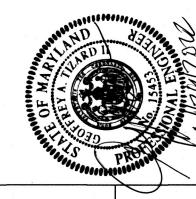

ENGINE WAY 21795 T OF EN OUNTY DEPARTMENT C 16232 ELLIOTT PAR WILLIAMSPORT, ME

Ш

Ш


EA Engineering, Science, and Technology, Inc., PBC **Hunt Valley Center** 225 Schilling Circle, Suite 400


Hunt Valley, Maryland 21031 (410) 584-7000


PROJECT NUMBER: 1556701


DATE: APRIL 2022

SHEET: 4 OF 76

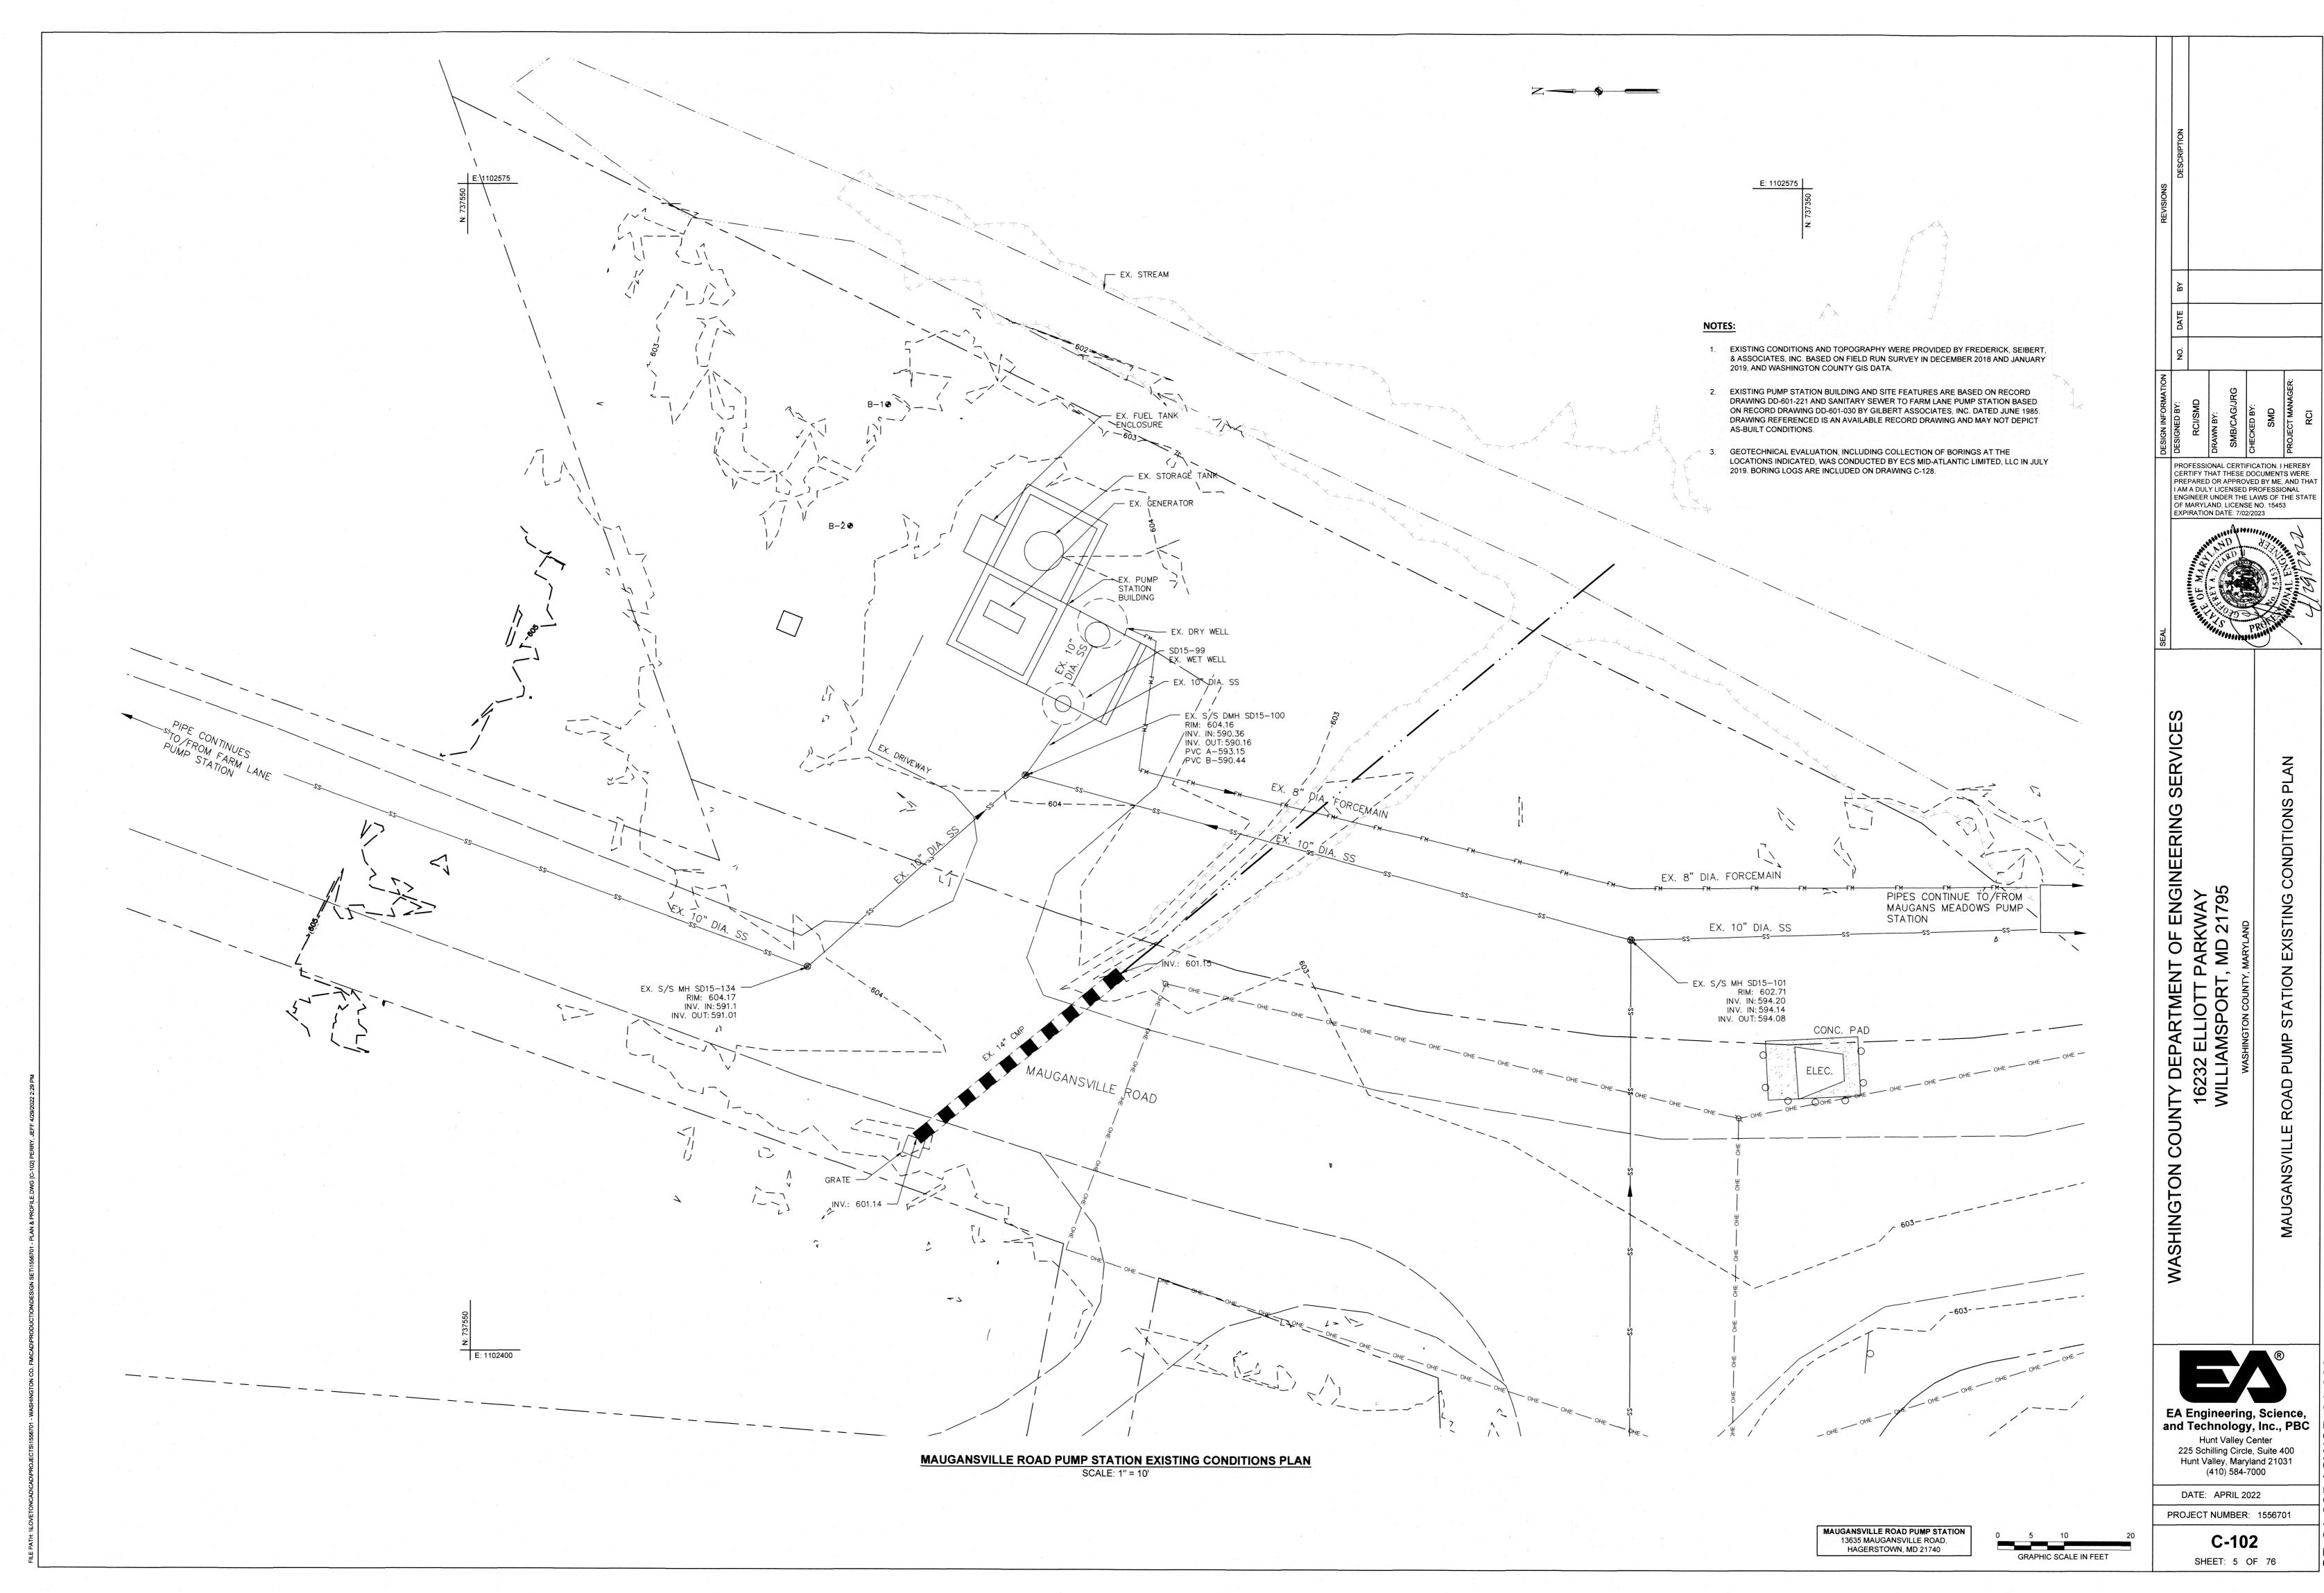

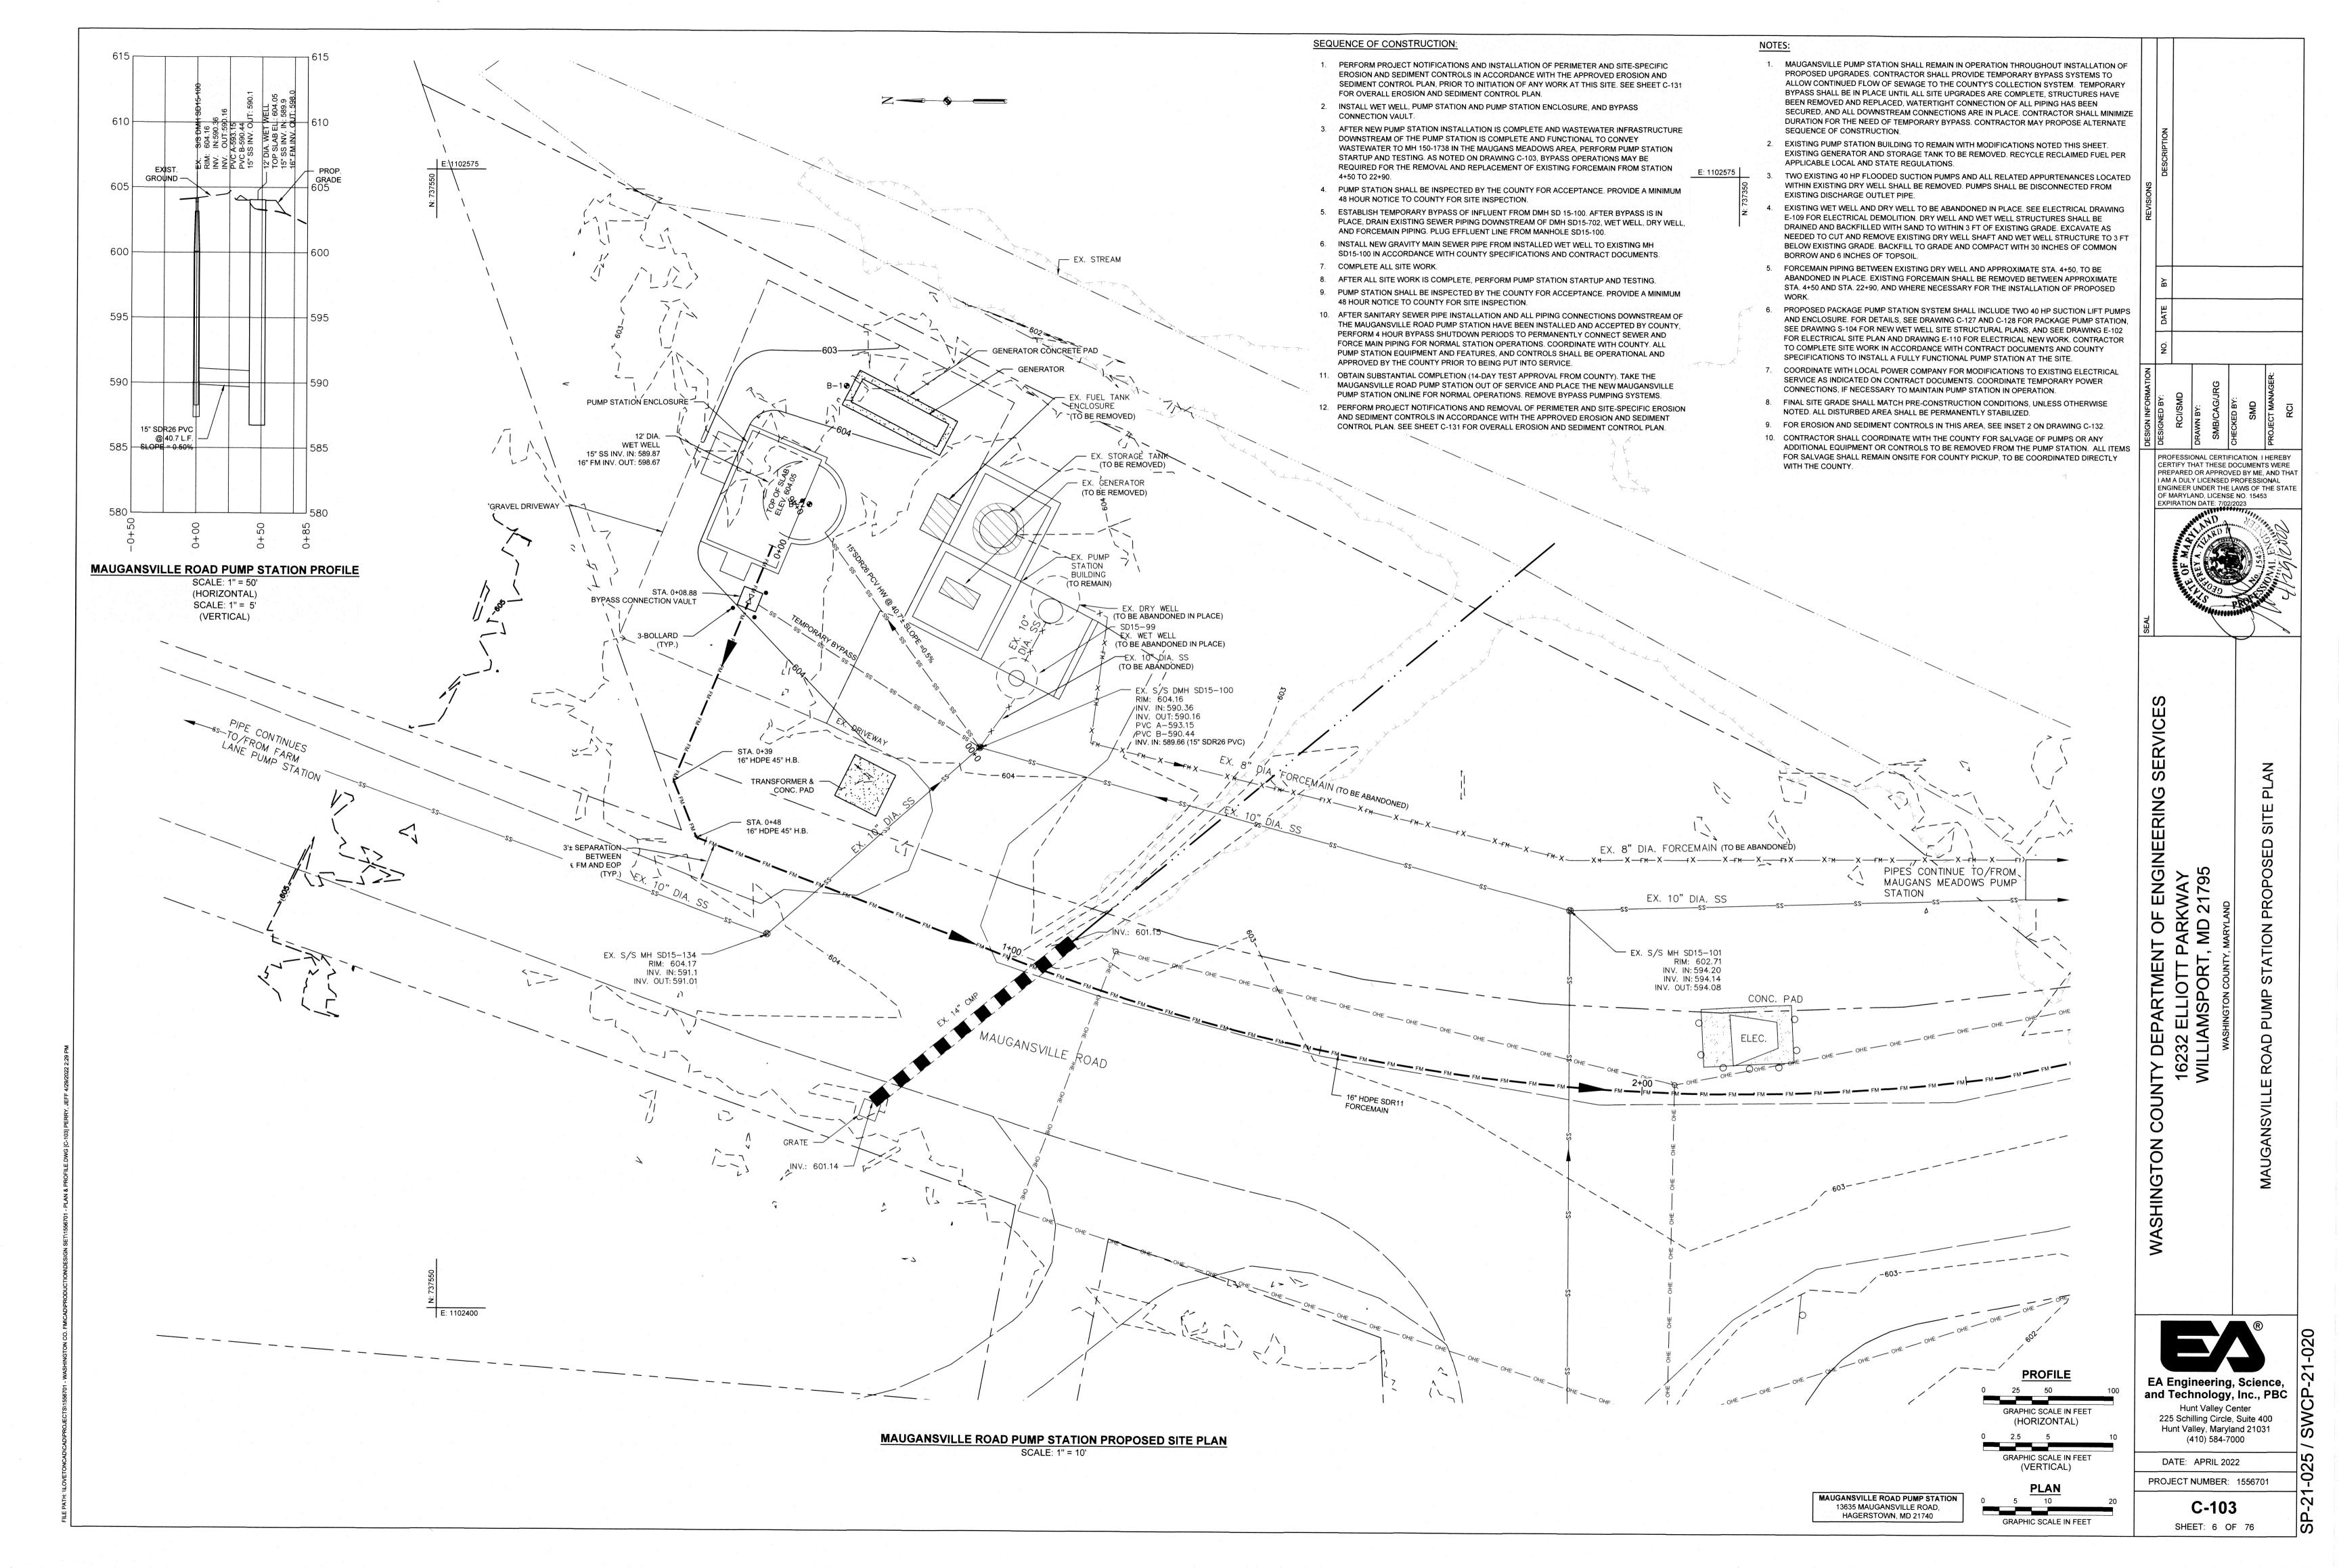

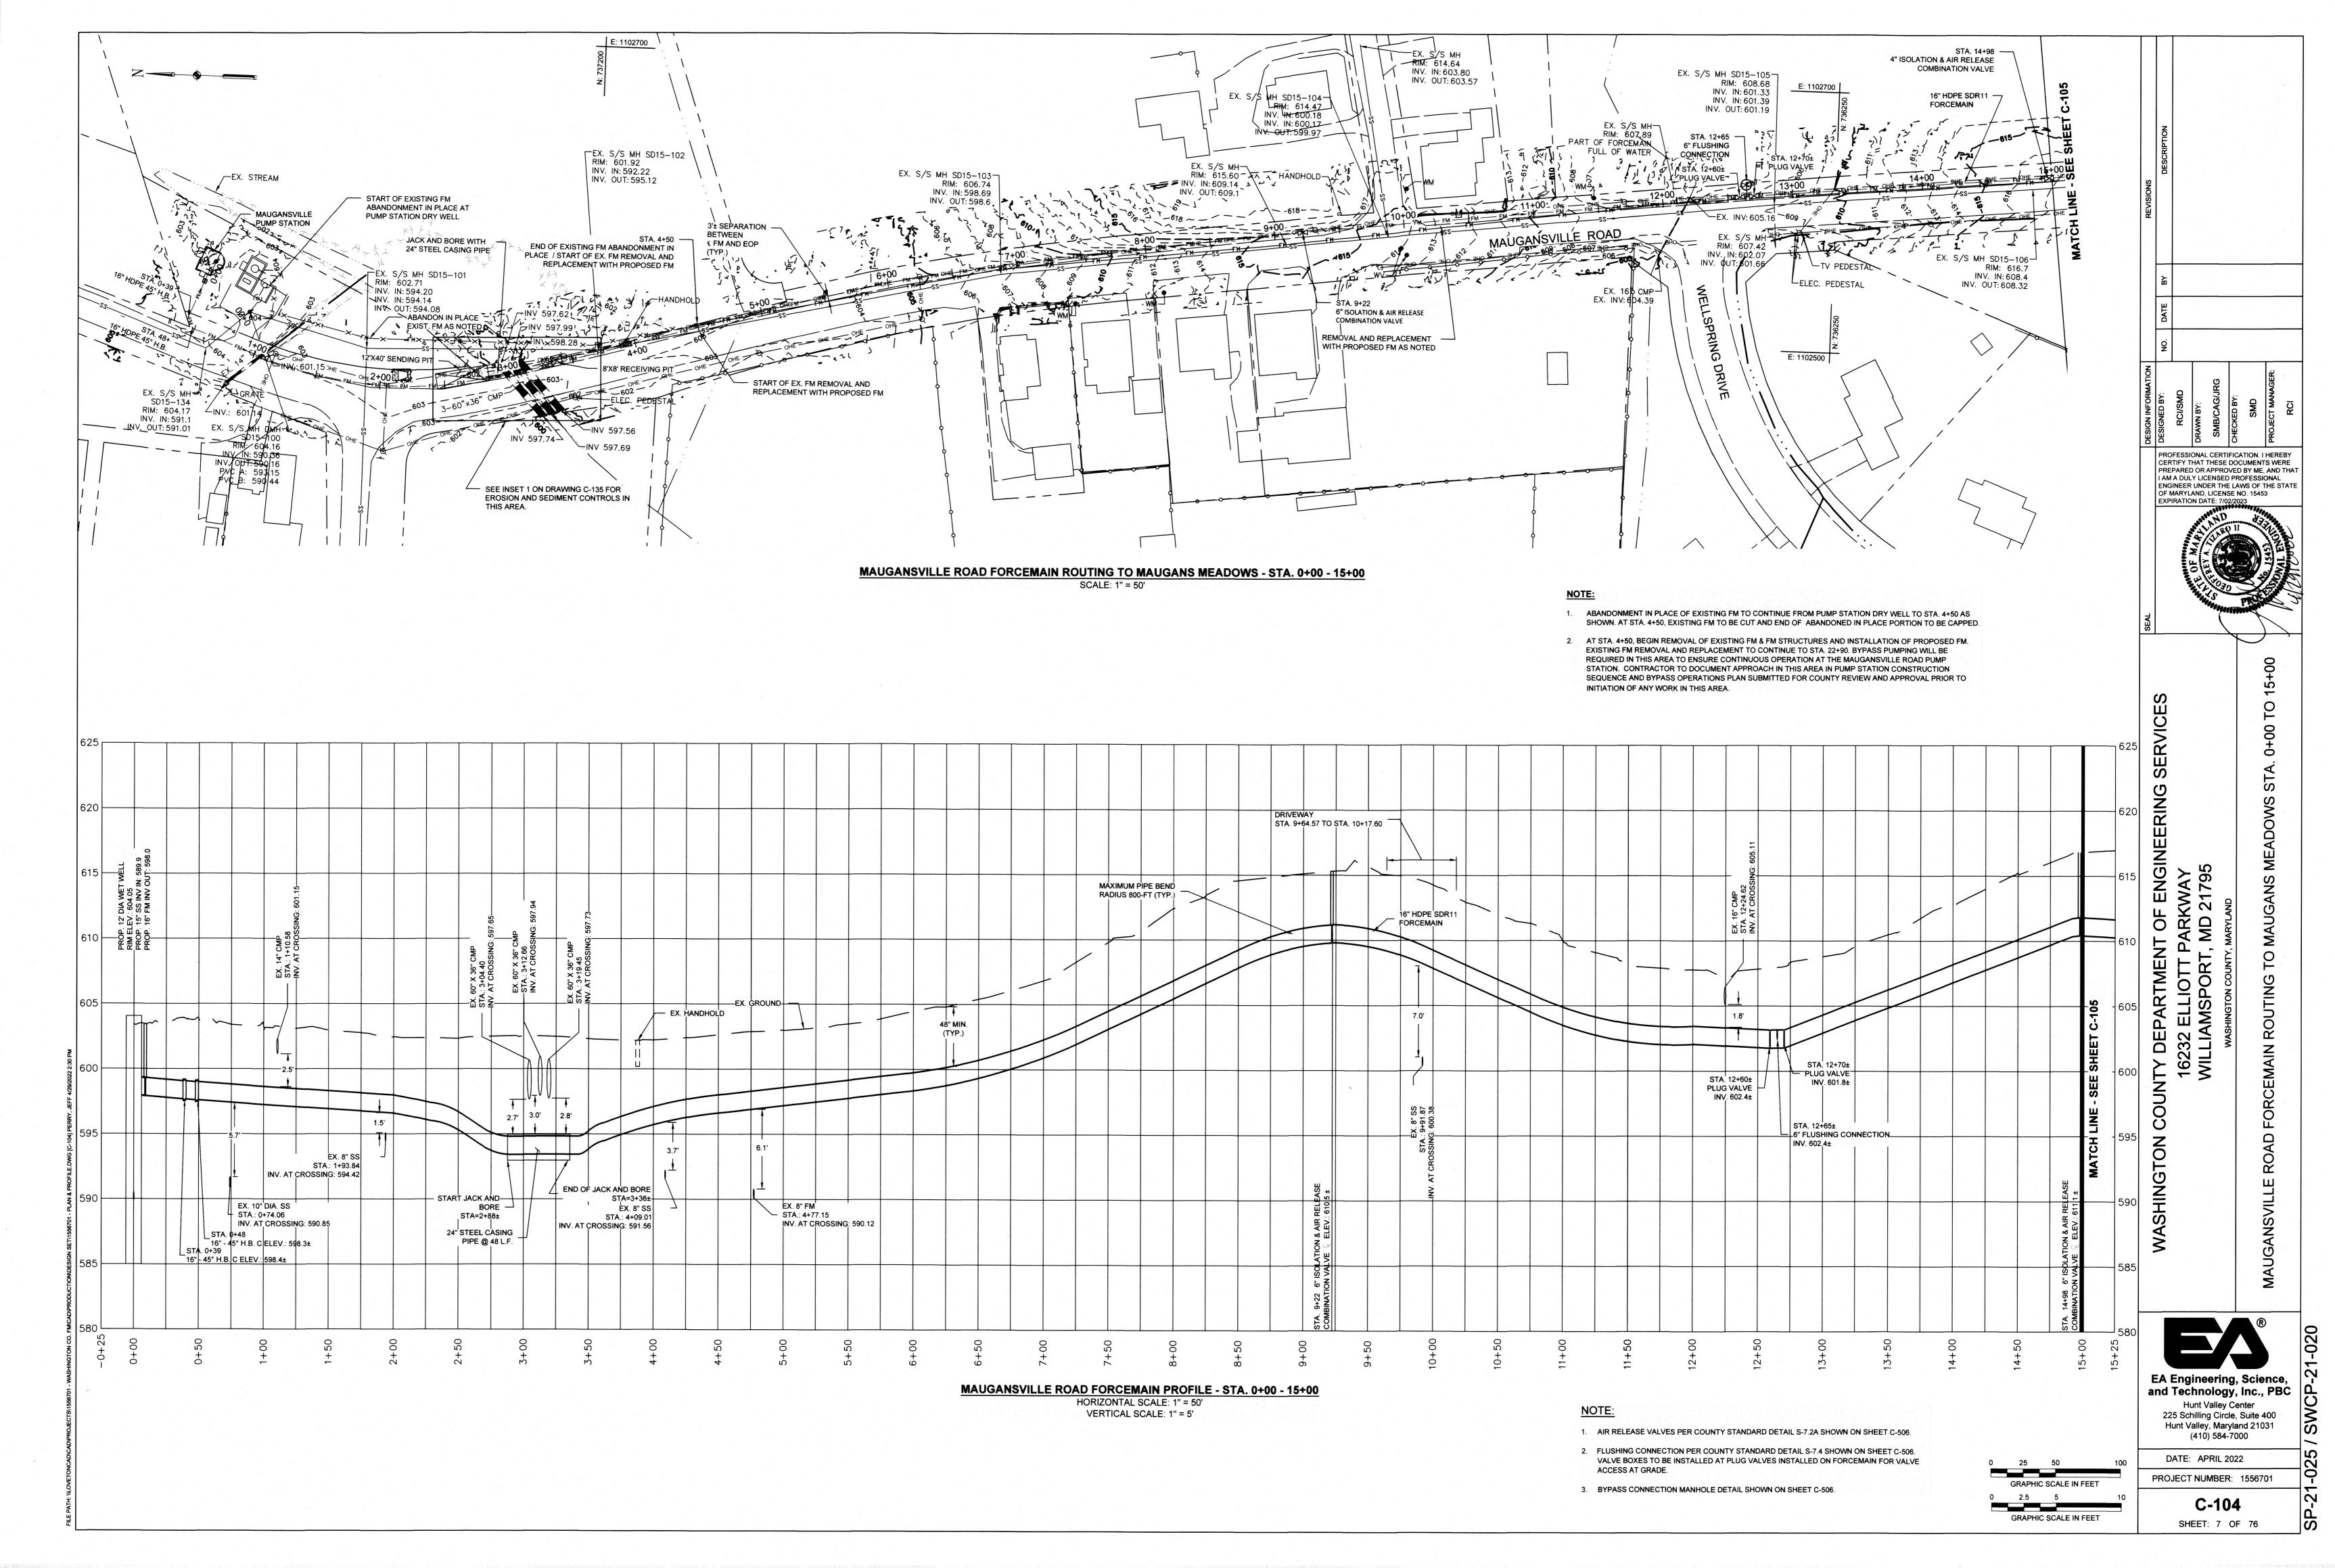

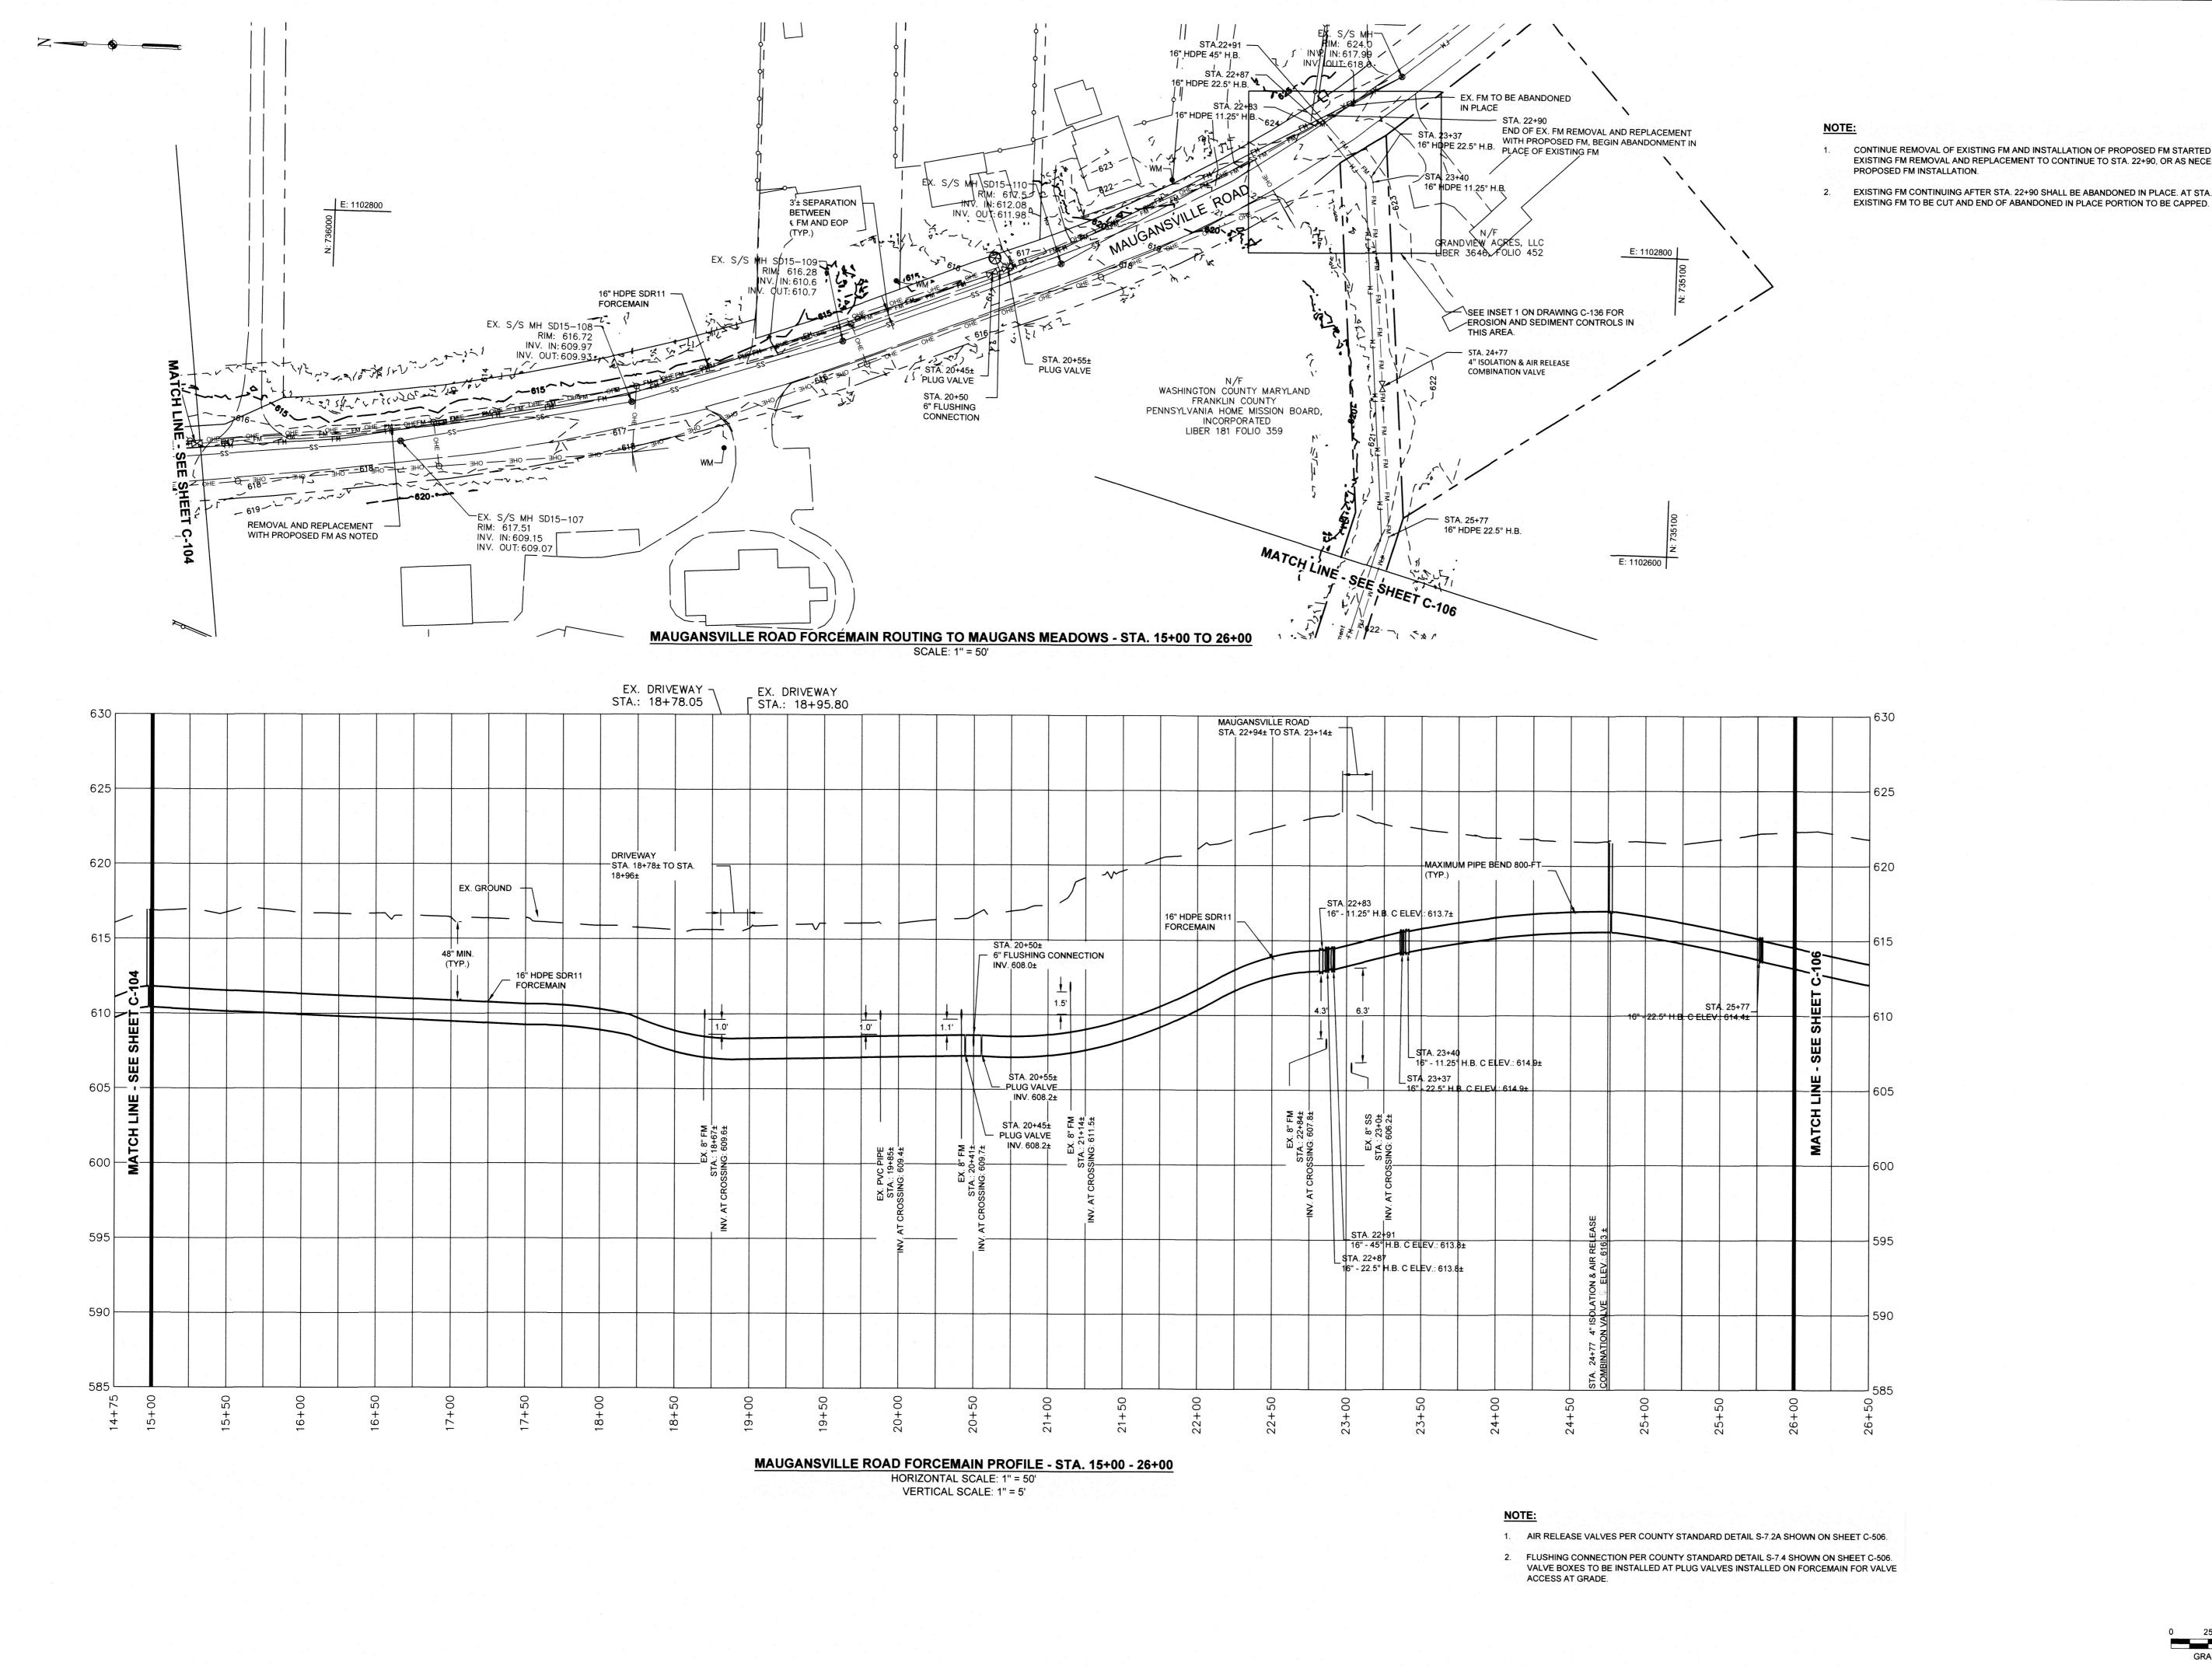

- CONTINUE REMOVAL OF EXISTING FM AND INSTALLATION OF PROPOSED FM STARTED AT STA. 4+50. EXISTING FM REMOVAL AND REPLACEMENT TO CONTINUE TO STA. 22+90, OR AS NECESSARY FOR PROPOSED FM INSTALLATION.
- EXISTING FM CONTINUING AFTER STA. 22+90 SHALL BE ABANDONED IN PLACE. AT STA. 22+90,

PROFESSIONAL CERTIFICATION, I HEREBY CERTIFY THAT THESE DOCUMENTS WERE PREPARED OR APPROVED BY ME, AND THAT I AM A DULY LICENSED PROFESSIONAL ENGINEER UNDER THE LAWS OF THE STATE OF MARYLAND, LICENSE NO. 15453 EXPIRATION DATE: 7/02/2023



OUNTY DEPARTMENT OF ENGINEERI
16232 ELLIOTT PARKWAY
WILLIAMSPORT, MD 21795

ROAD

EA Engineering, Science, and Technology, Inc., PBC **Hunt Valley Center** 225 Schilling Circle, Suite 400 Hunt Valley, Maryland 21031


(410) 584-7000

DATE: APRIL 2022 PROJECT NUMBER: 1556701

C-105

GRAPHIC SCALE IN FEET SHEET: 8 OF 76

GRAPHIC SCALE IN FEET

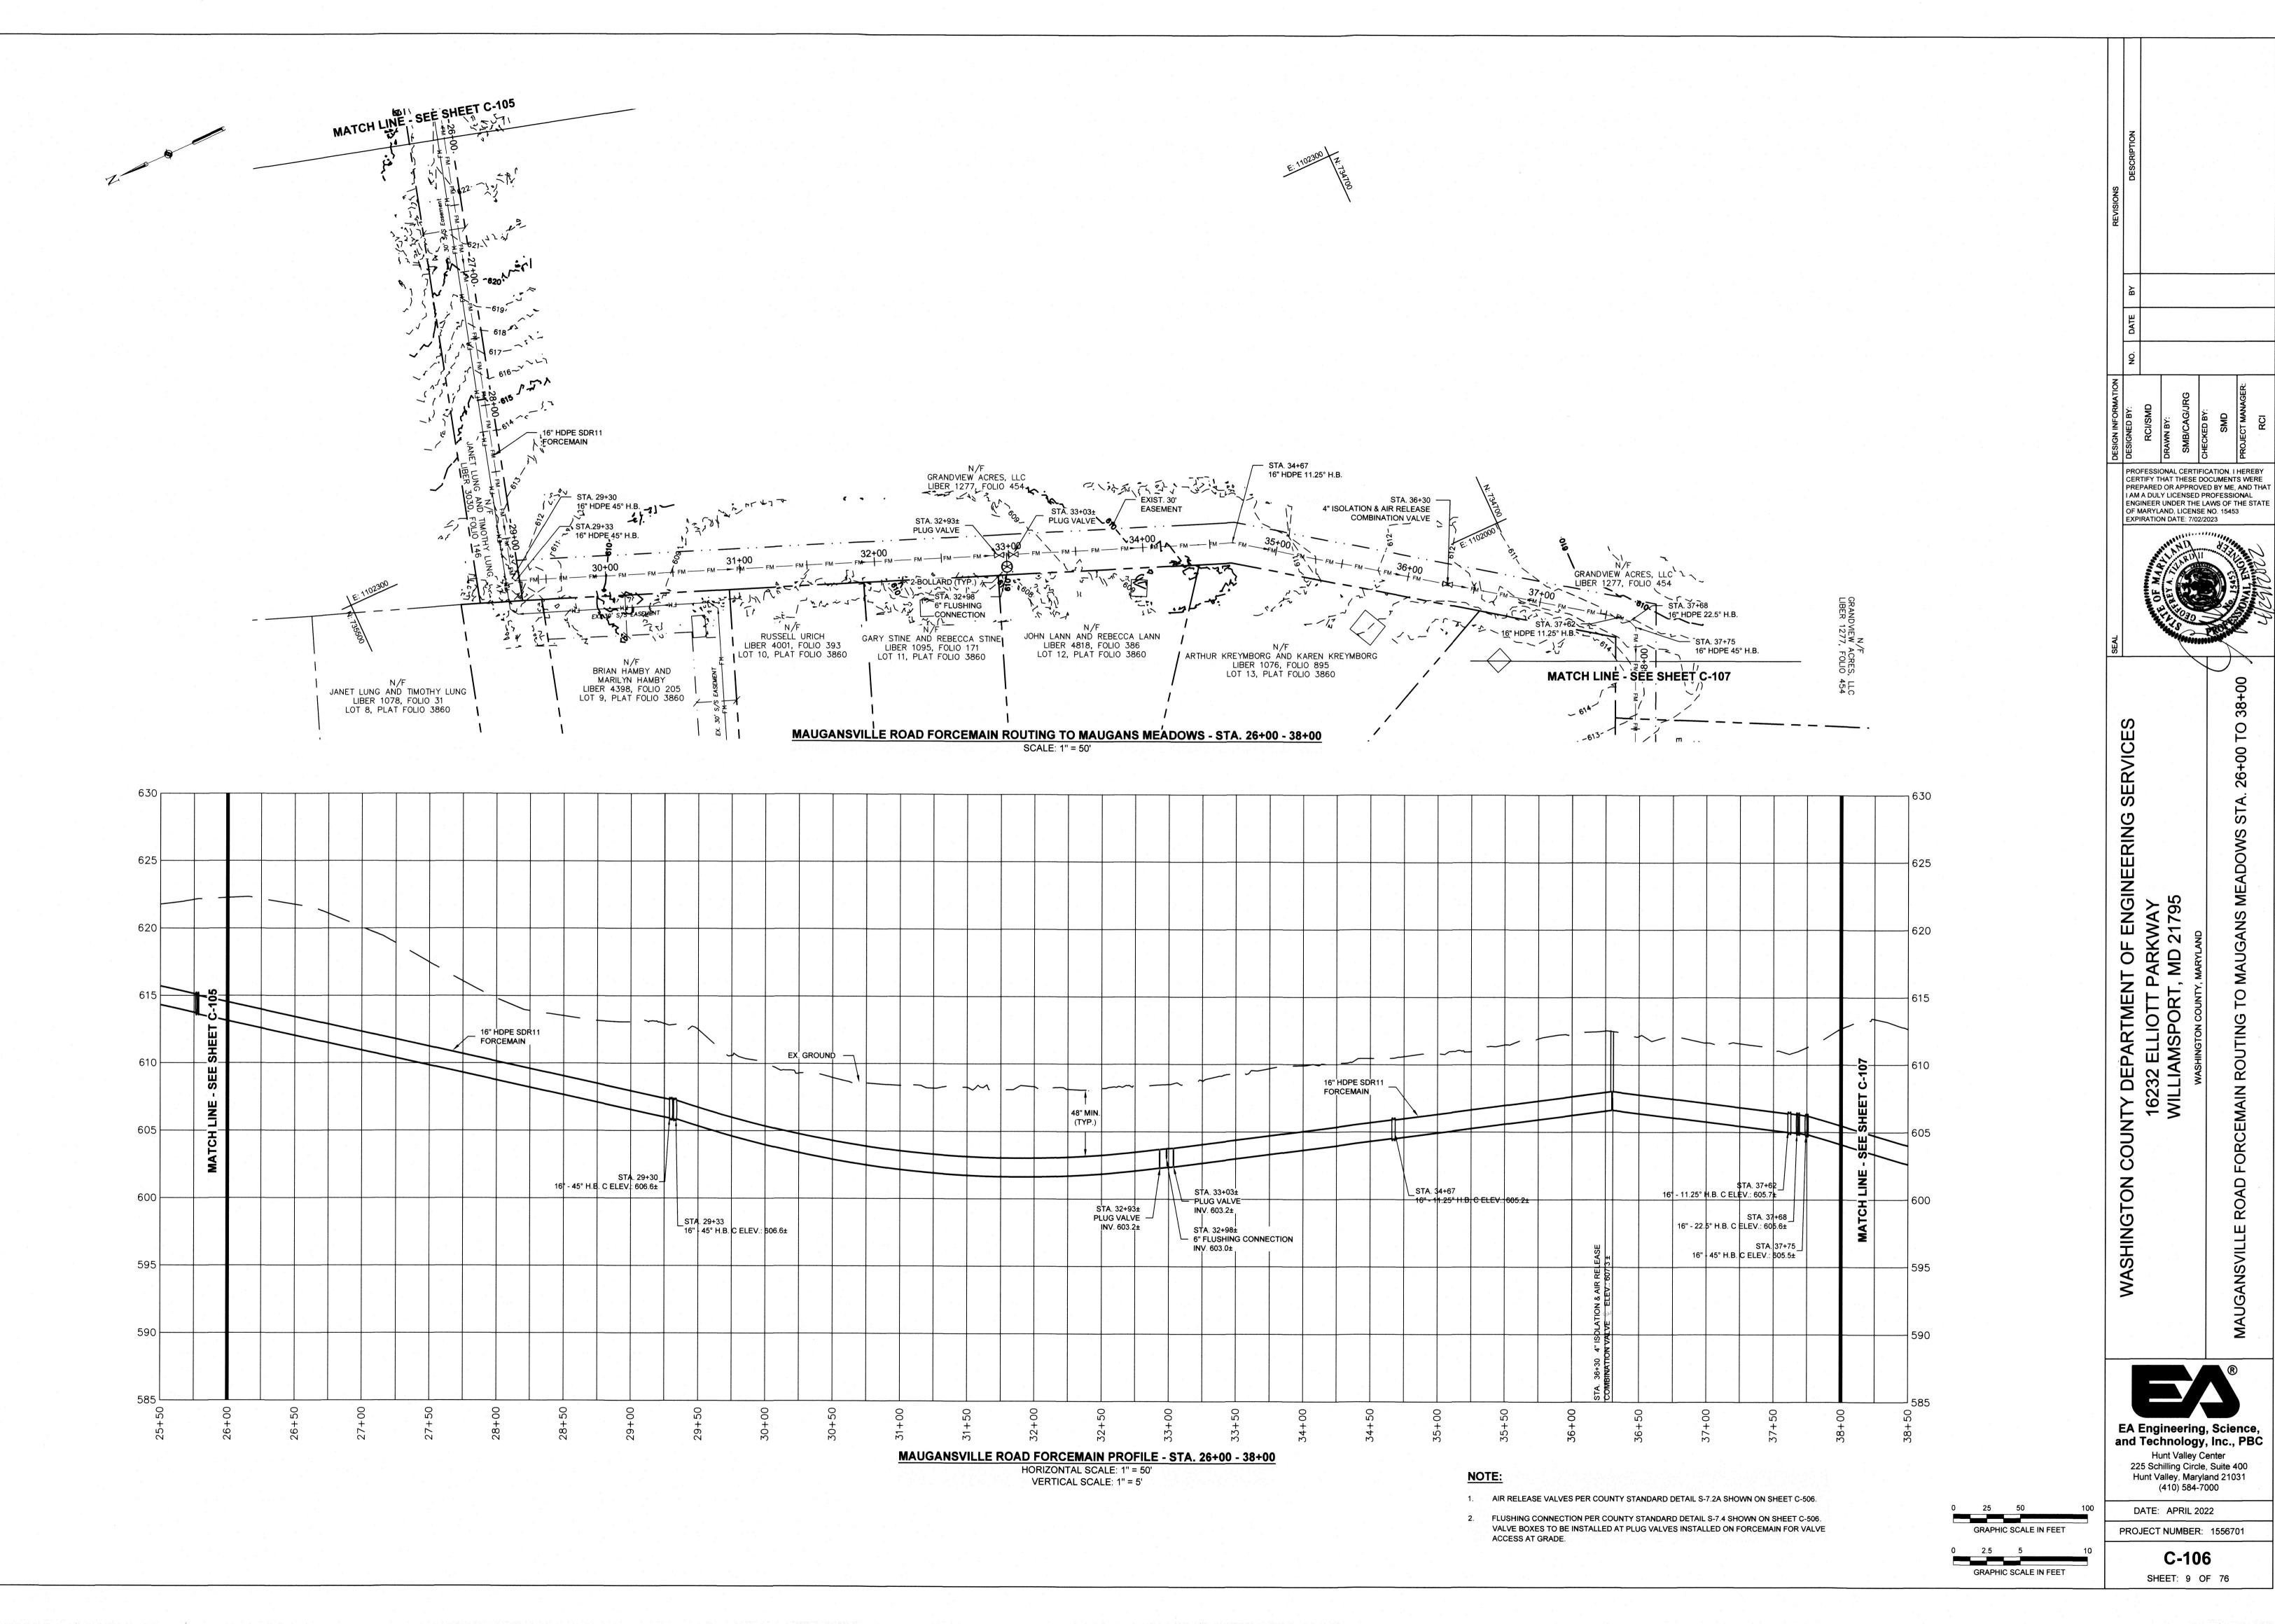

COUNTY DEPARTMENT OF ENGINI
16232 ELLIOTT PARKWAY
WILLIAMSPORT, MD 21795

PROFESSIONAL CERTIFICATION. I HEREBY

CERTIFY THAT THESE DOCUMENTS WERE


EXPIRATION DATE: 7/02/2023

EA Engineering, Science, and Technology, Inc., PBC **Hunt Valley Center** 225 Schilling Circle, Suite 400 Hunt Valley, Maryland 21031 (410) 584-7000

DATE: APRIL 2022 PROJECT NUMBER: 1556701

C-106

SHEET: 9 OF 76

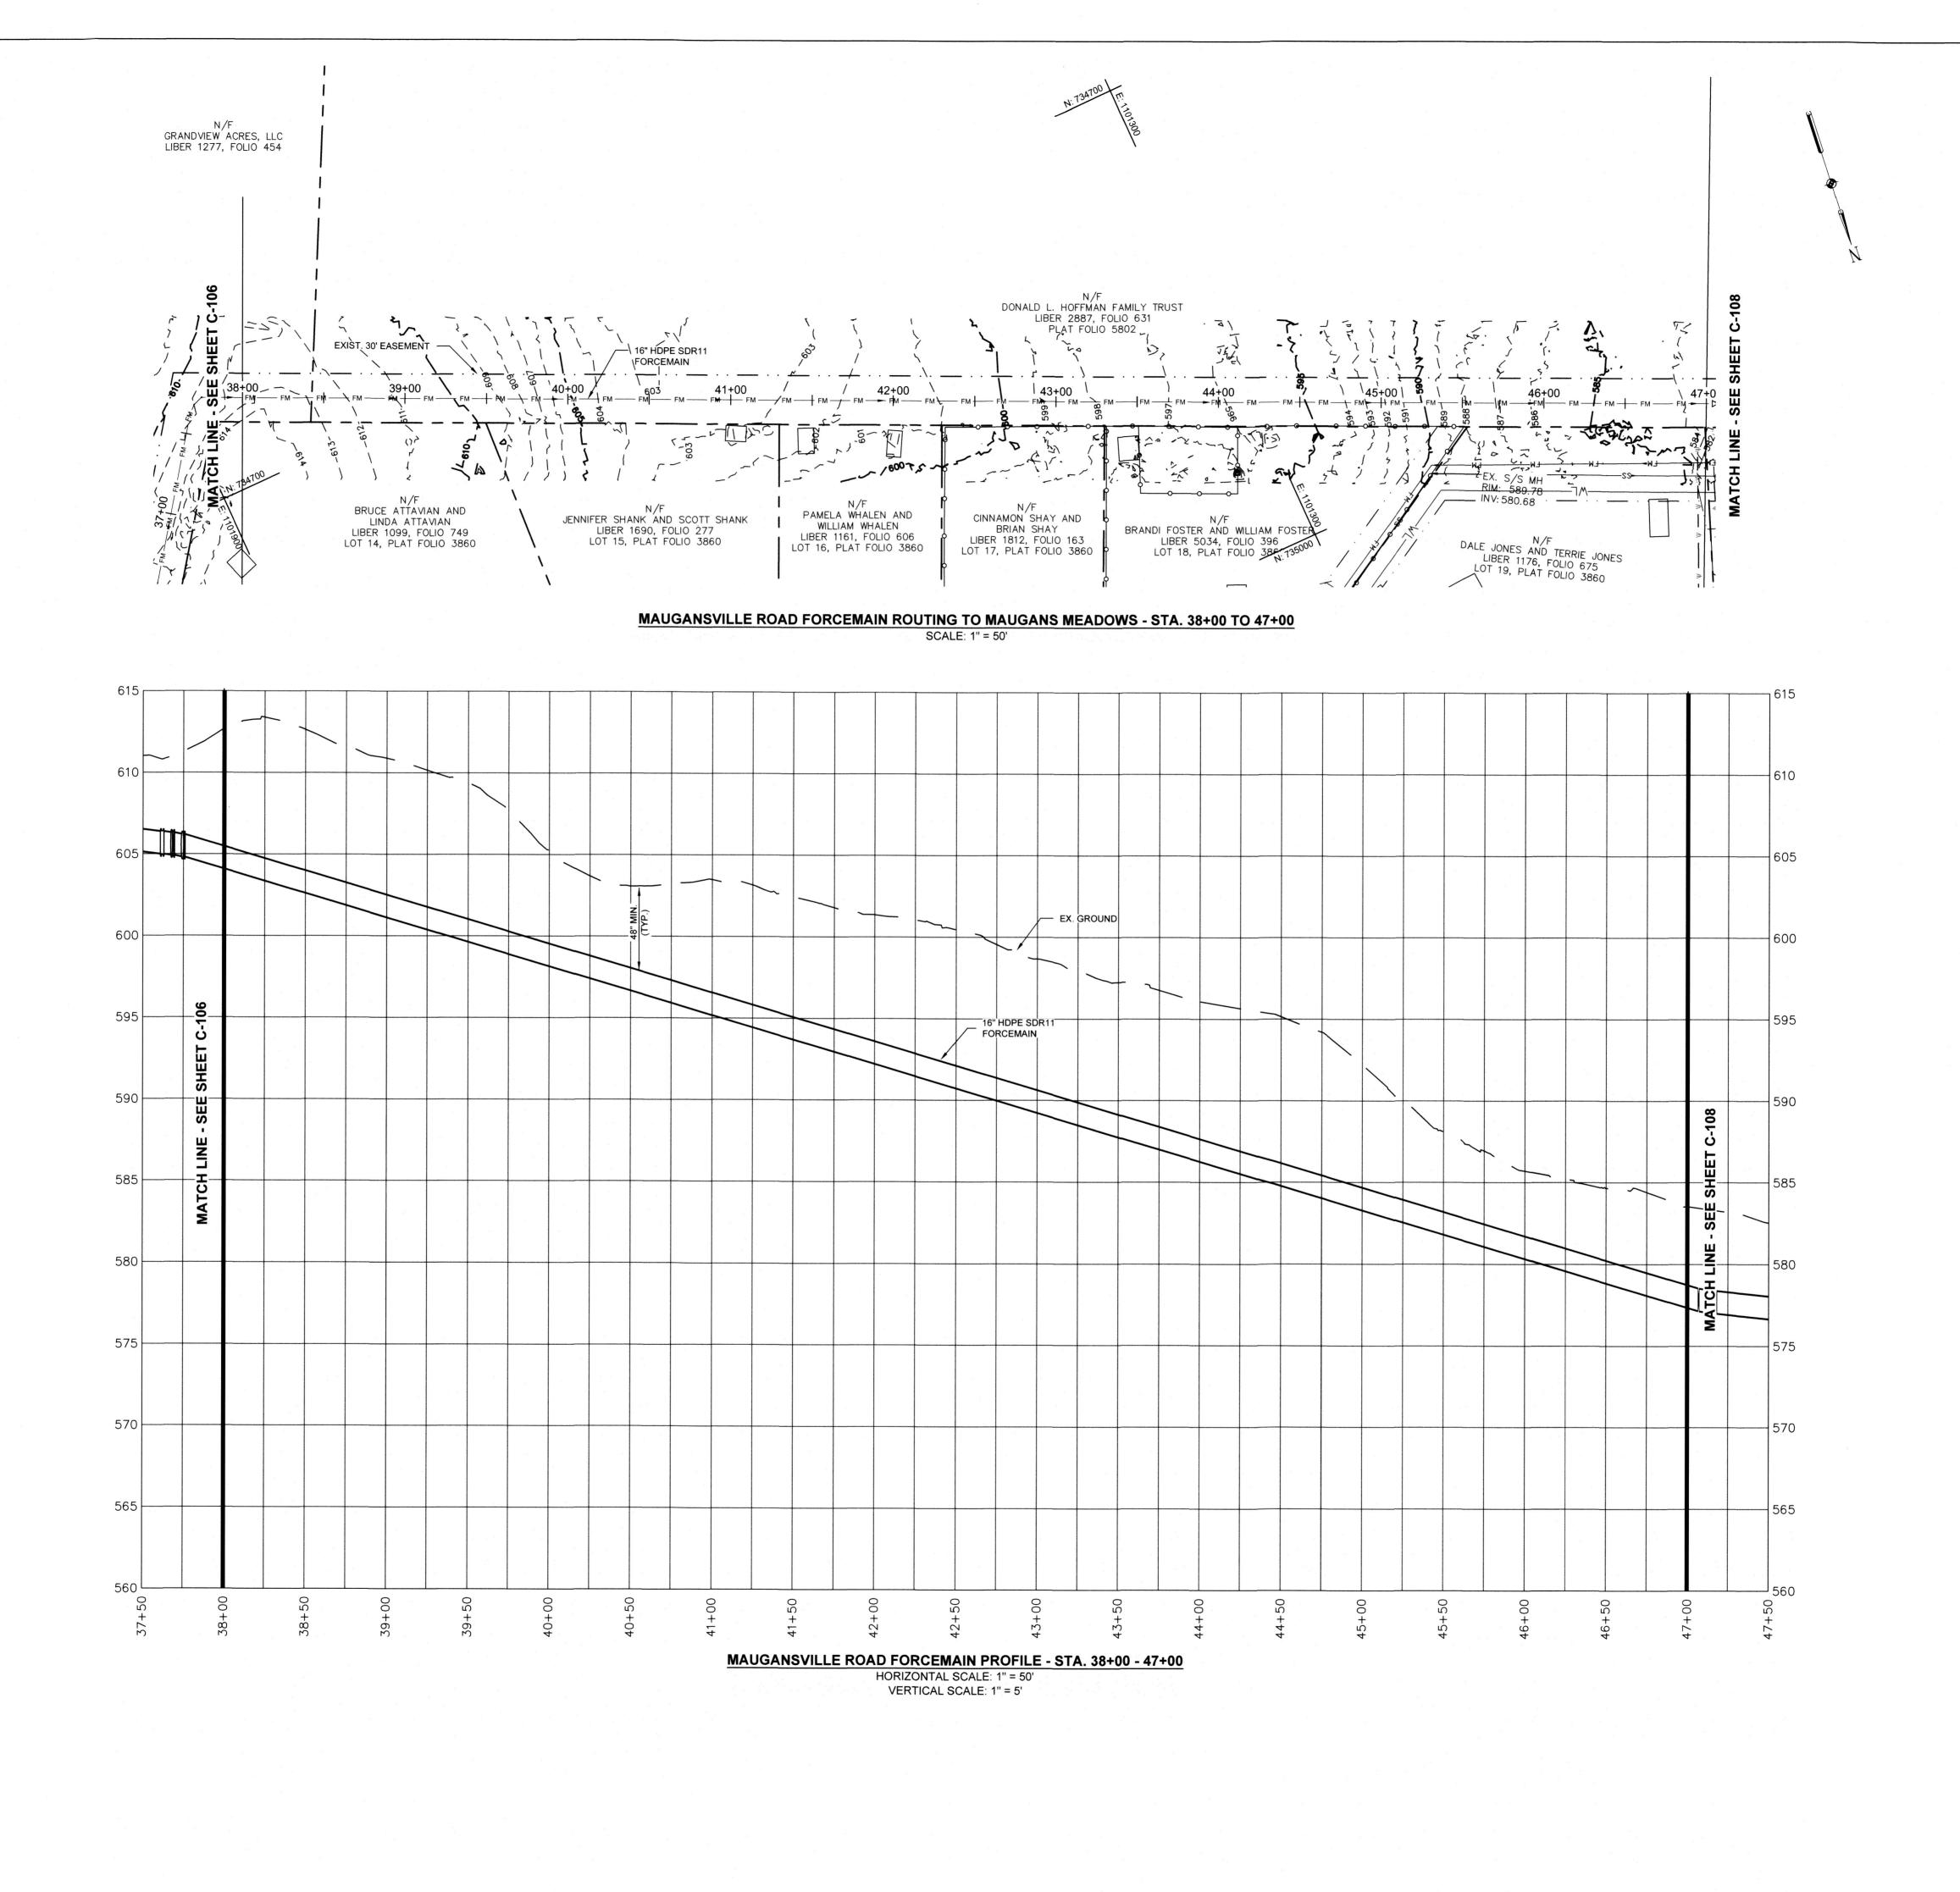

COUNTY DEPARTMENT OF ENGINEER
16232 ELLIOTT PARKWAY
WILLIAMSPORT, MD 21795
WASHINGTON COUNTY, MARYLAND

PROFESSIONAL CERTIFICATION. I HEREBY CERTIFY THAT THESE DOCUMENTS WERE PREPARED OR APPROVED BY ME, AND THAT I AM A DULY LICENSED PROFESSIONAL

ENGINEER UNDER THE LAWS OF THE STATE OF MARYLAND, LICENSE NO. 15453 EXPIRATION DATE: 7/02/2023

7

FORCEMAIN

AD


EA Engineering, Science, and Technology, Inc., PBC Hunt Valley Center 225 Schilling Circle, Suite 400 Hunt Valley, Maryland 21031 (410) 584-7000

DATE: APRIL 2022 PROJECT NUMBER: 1556701

GRAPHIC SCALE IN FEET

GRAPHIC SCALE IN FEET


C-107 SHEET: 10 OF 76

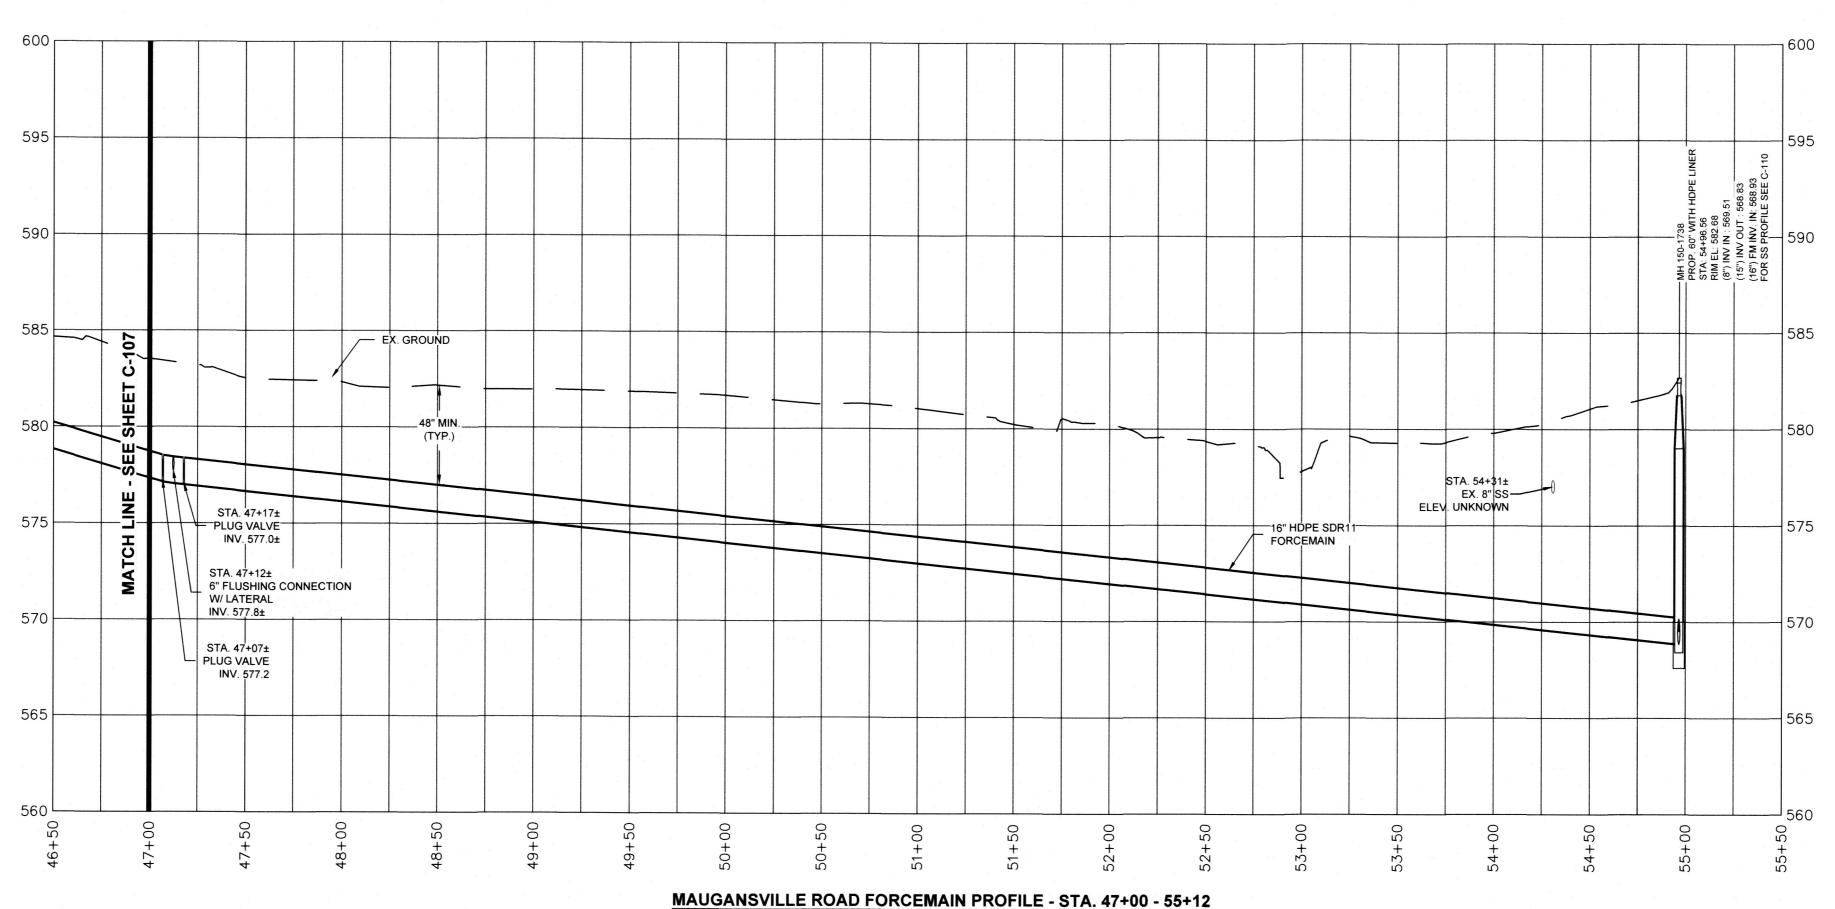


HORIZONTAL SCALE: 1" = 50' VERTICAL SCALE: 1" = 5'

NOTE:

- 1. AIR RELEASE VALVES PER COUNTY STANDARD DETAIL S-7.2A SHOWN ON SHEET C-506.
- 2. FLUSHING CONNECTION PER DETAIL SHOWN ON SHEET C-506 FOR FLUSHING CONNECTION WITH LATERAL. VALVE BOXES TO BE INSTALLED AT PLUG VALVES INSTALLED ON FORCEMAIN FOR VALVE ACCESS AT GRADE.
- 3. FOR FORCEMAIN INSTALLATION AT STREAM CROSSING SHOWN THIS SHEET, SEE DETAIL ON DRAWING C-134.

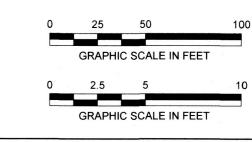

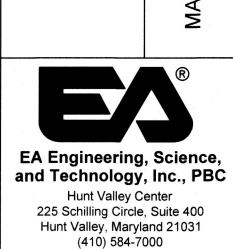

AD

PROFESSIONAL CERTIFICATION. I HEREBY

CERTIFY THAT THESE DOCUMENTS WERE

PREPARED OR APPROVED BY ME, AND THAT

I AM A DULY LICENSED PROFESSIONAL ENGINEER UNDER THE LAWS OF THE STATE OF MARYLAND, LICENSE NO. 15453

EXPIRATION DATE: 7/02/2023

ER

OUNTY DEPARTMENT OF ENGINI 16232 ELLIOTT PARKWAY WILLIAMSPORT, MD 21795


DATE: APRIL 2022

PROJECT NUMBER: 1556701

SHEET: 11 OF 76

C-108

CERTIFY THAT THESE DOCUMENTS WERE PREPARED OR APPROVED BY ME, AND THAT LAM A DULY LICENSED PROFESSIONAL ENGINEER UNDER THE LAWS OF THE STATE OF MARYLAND, LICENSE NO. 15453

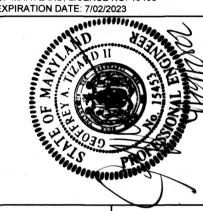

MAUGANS MEADOWS PUMP STATION 13500 ELAINE'S WAY HAGERSTOWN, MD 21740

6. FOR EROSION AND SEDIMENT CONTROLS IN THE AREA. SEE INSET 1 ON DRAWING

GRAPHIC SCALE IN FEET



AR MD


and Technology, Inc., PBC **Hunt Valley Center** 225 Schilling Circle, Suite 400 Hunt Valley, Maryland 21031


DATE: APRIL 2022


(410) 584-7000

PROJECT NUMBER: 1556701

SHEET: 12 OF 76

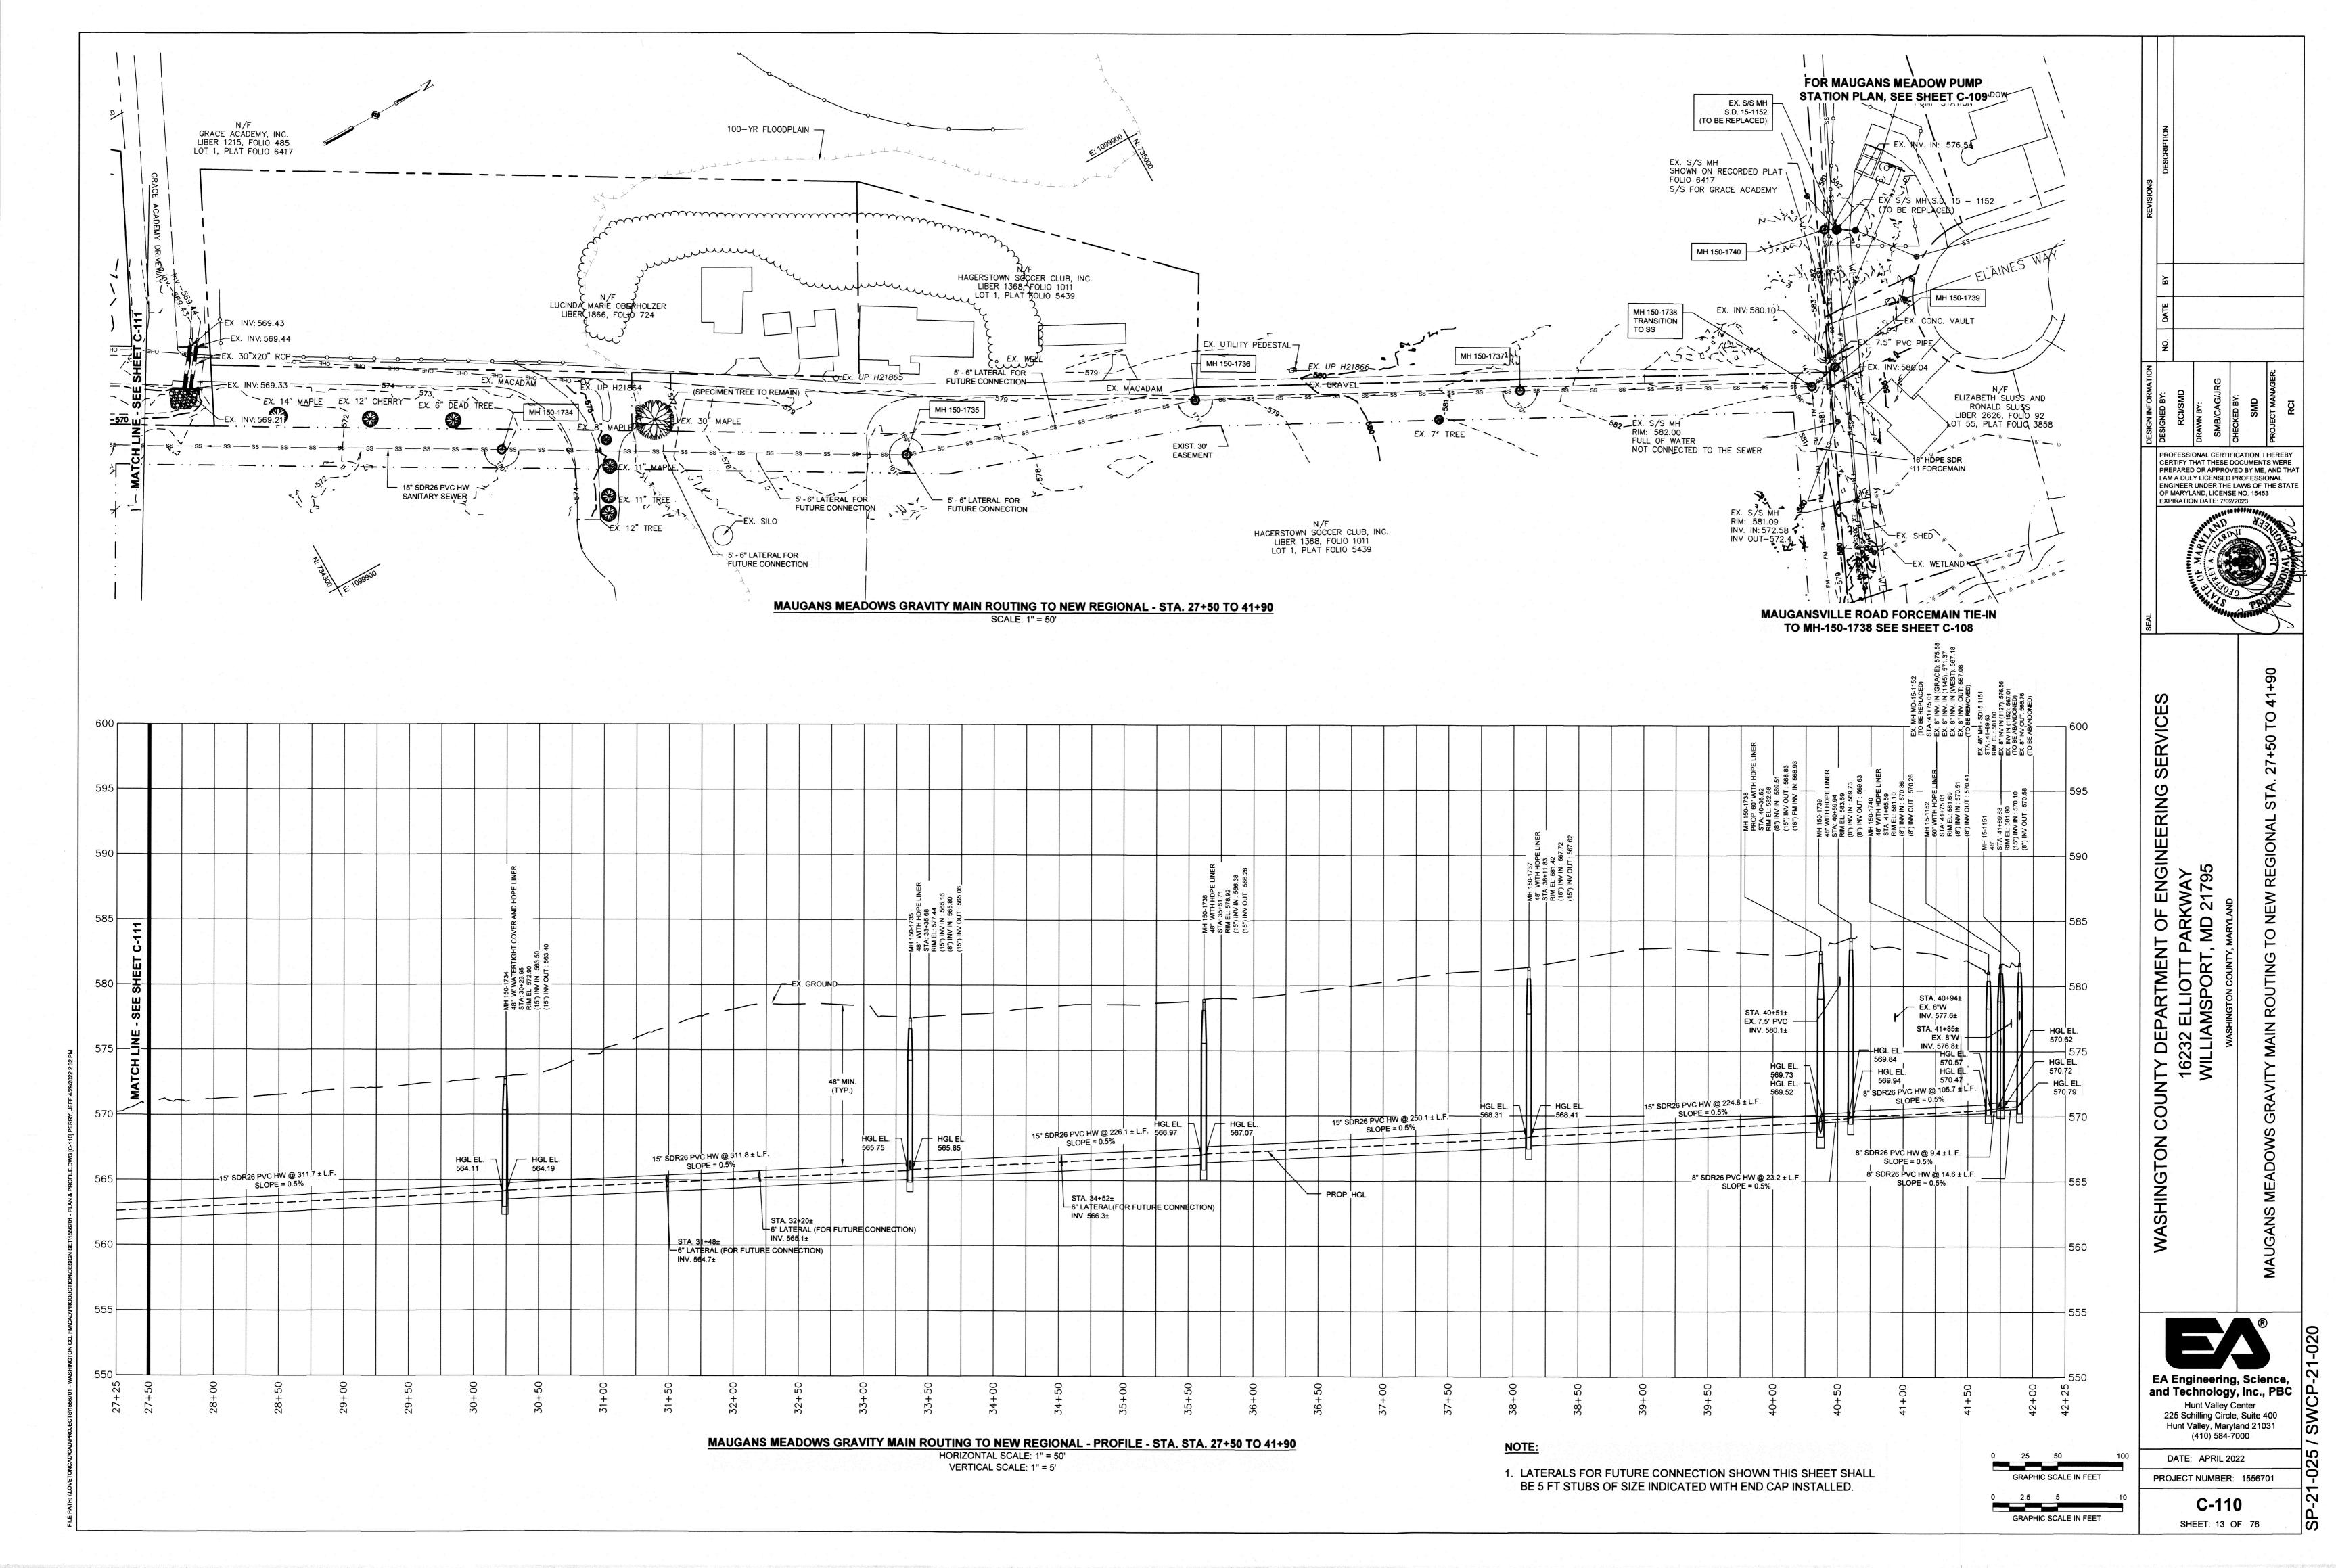

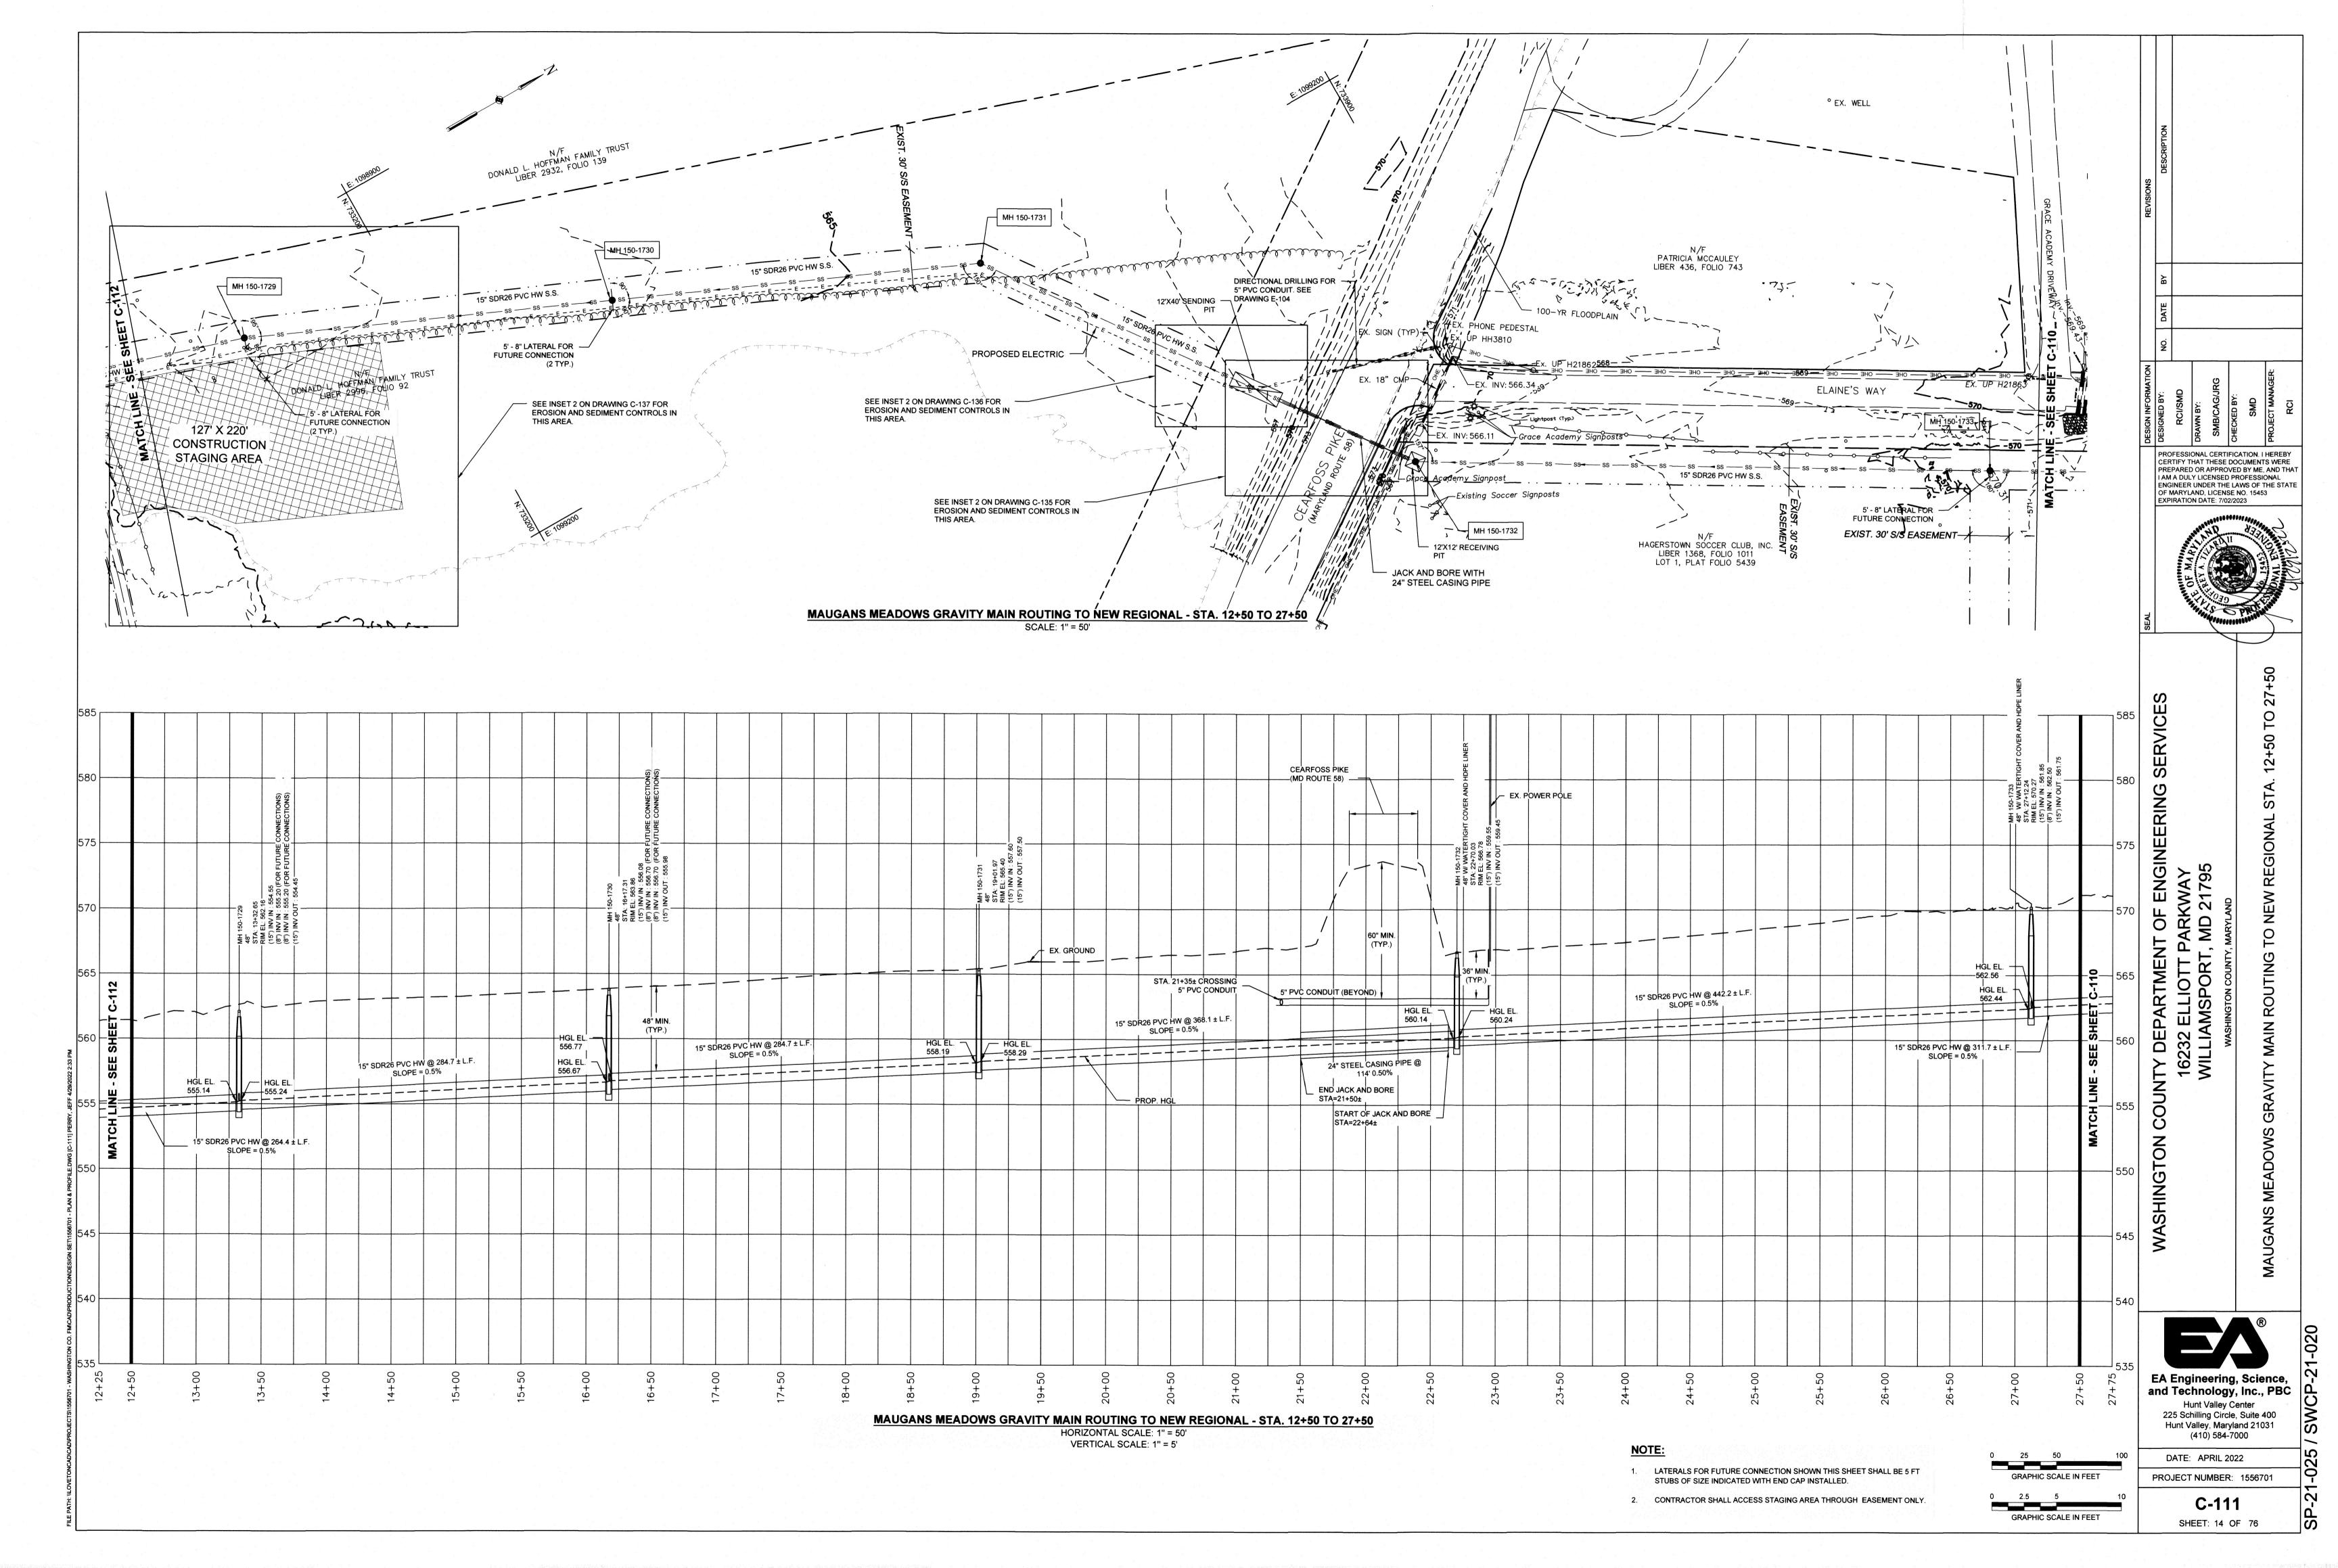

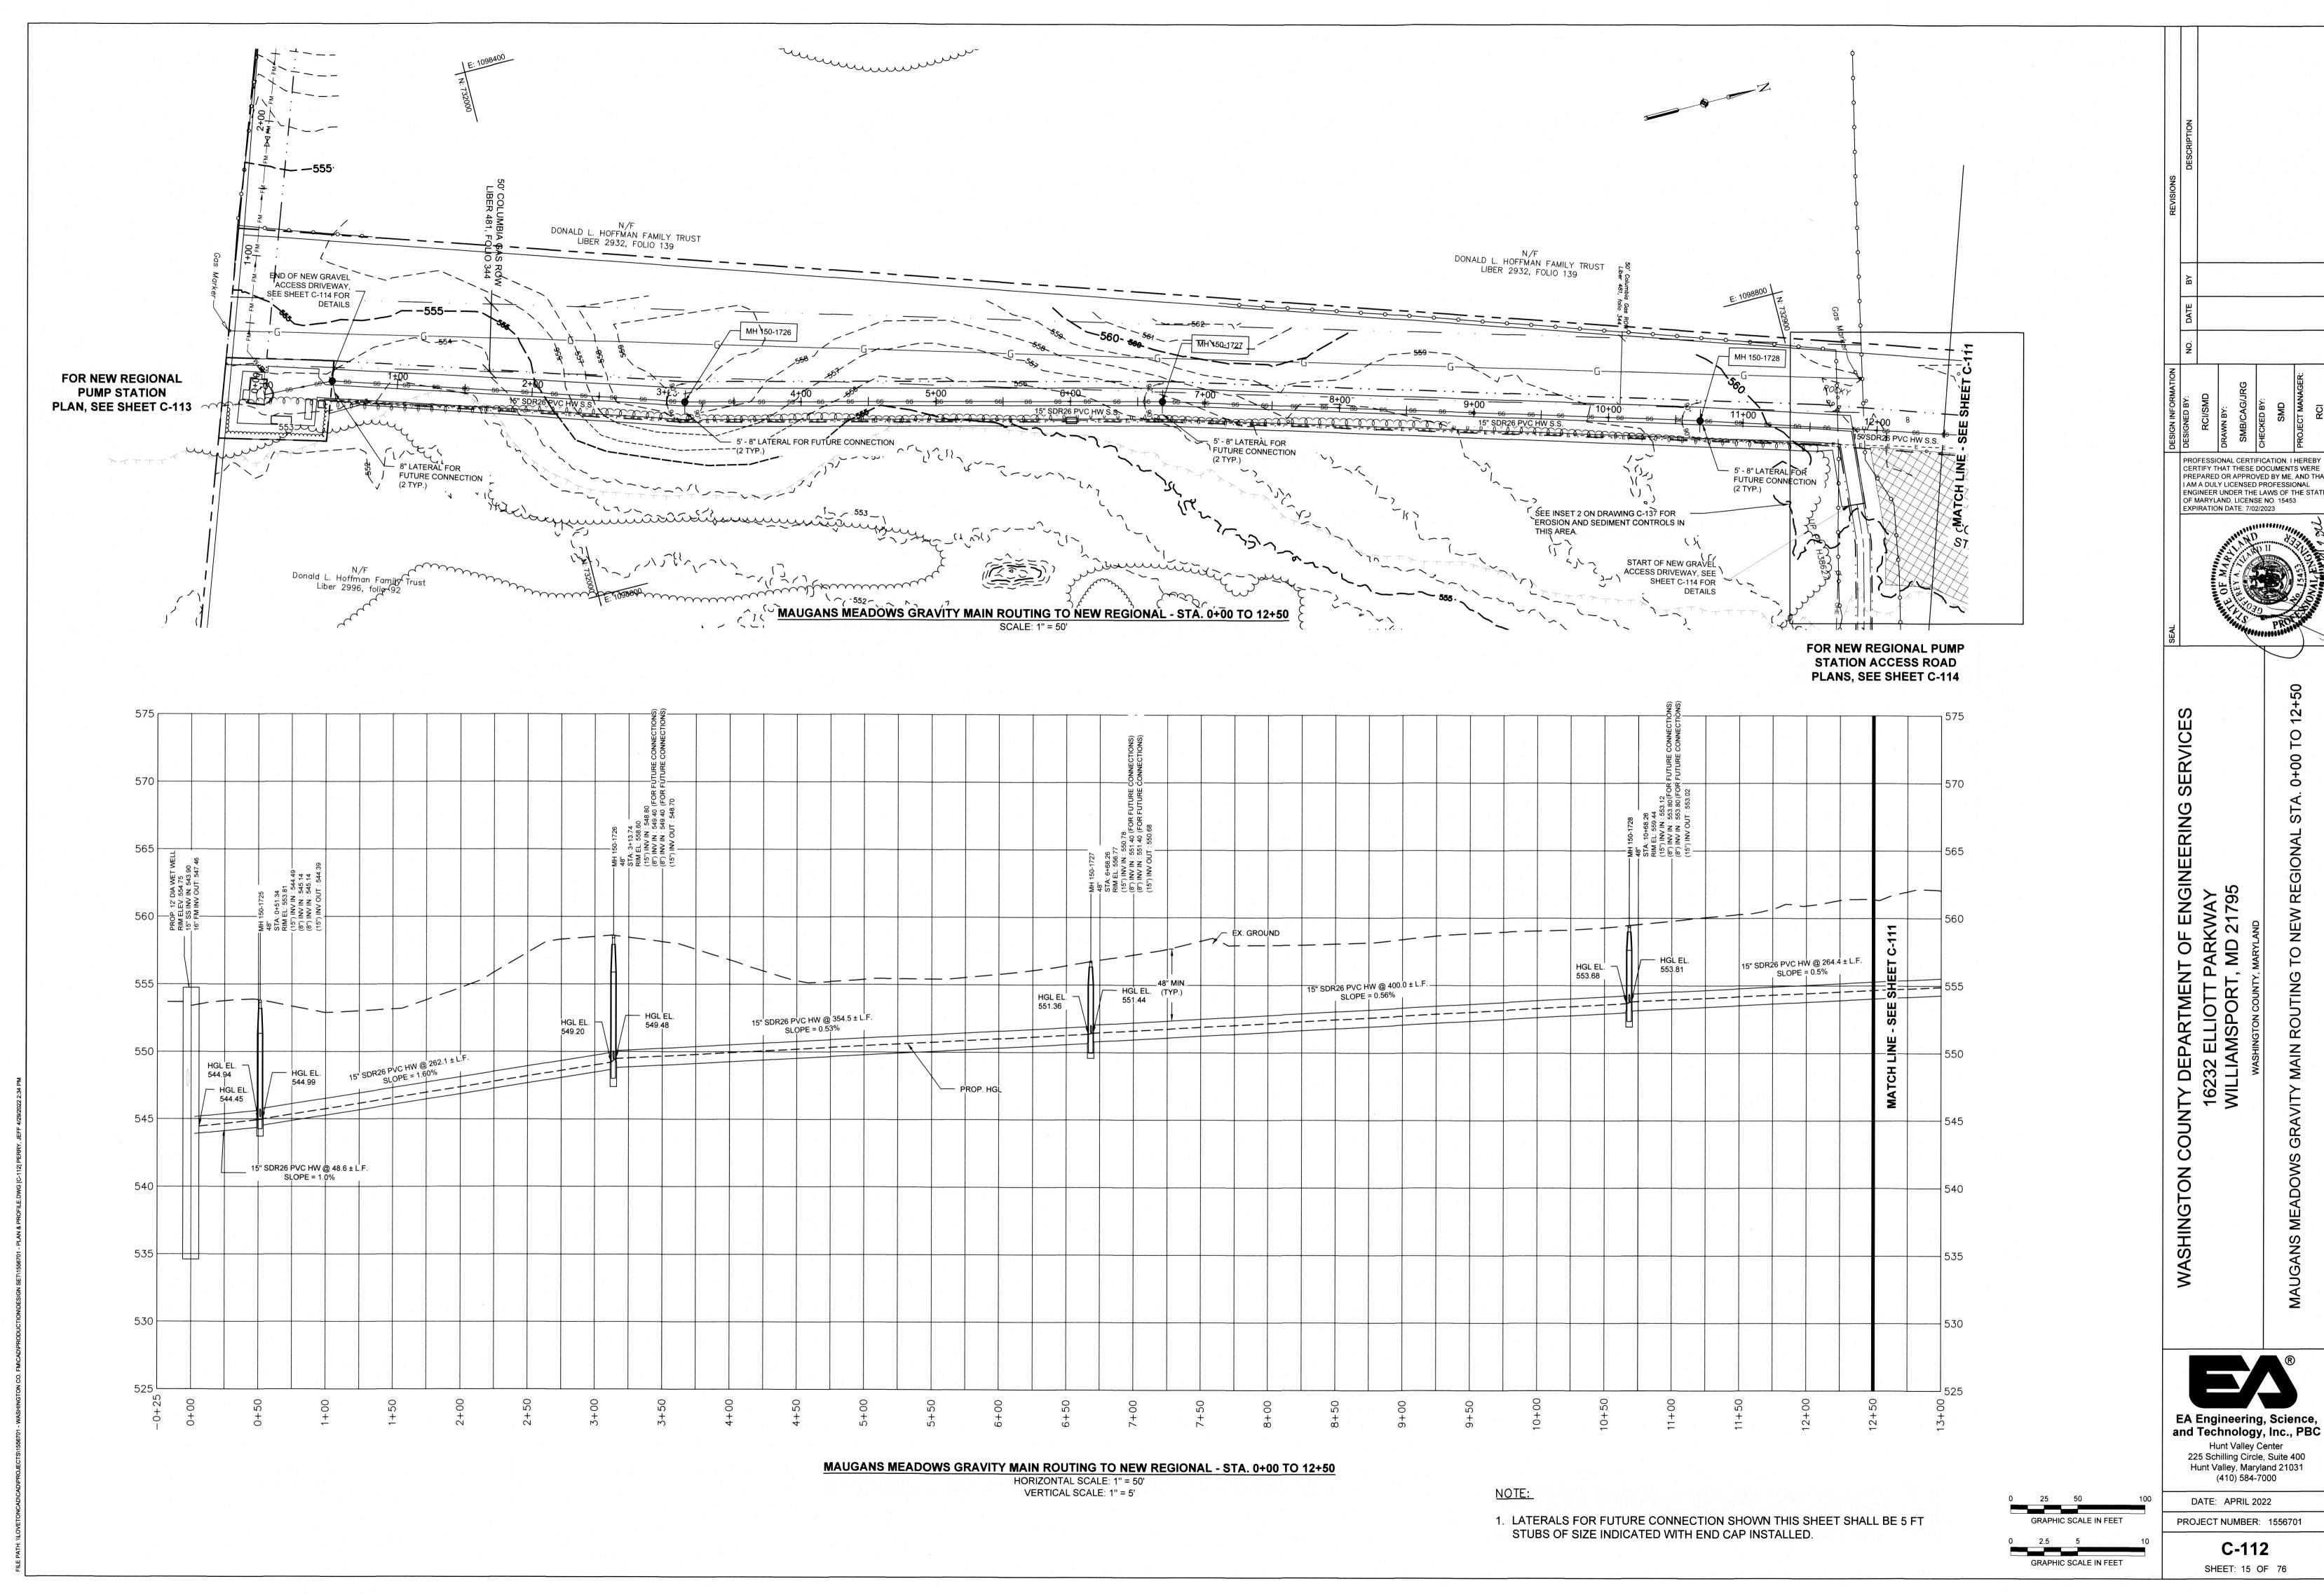

NEW REGIONAL

Ö

2

EA Engineering, Science, and Technology, Inc., PBC

Hunt Valley Center 225 Schilling Circle, Suite 400 Hunt Valley, Maryland 21031 (410) 584-7000

PROJECT NUMBER: 1556701

1111

PROPOSED & EXISTING ACCESS LANE PLAN


GRAPHIC SCALE IN FEET


13240 CEARFOSS PIKE, HAGERSTOWN, MD 21740

Hunt Valley, Maryland 21031 (410) 584-7000 DATE: APRIL 2022

PROJECT NUMBER: 1556701

SHEET: 16 OF 76

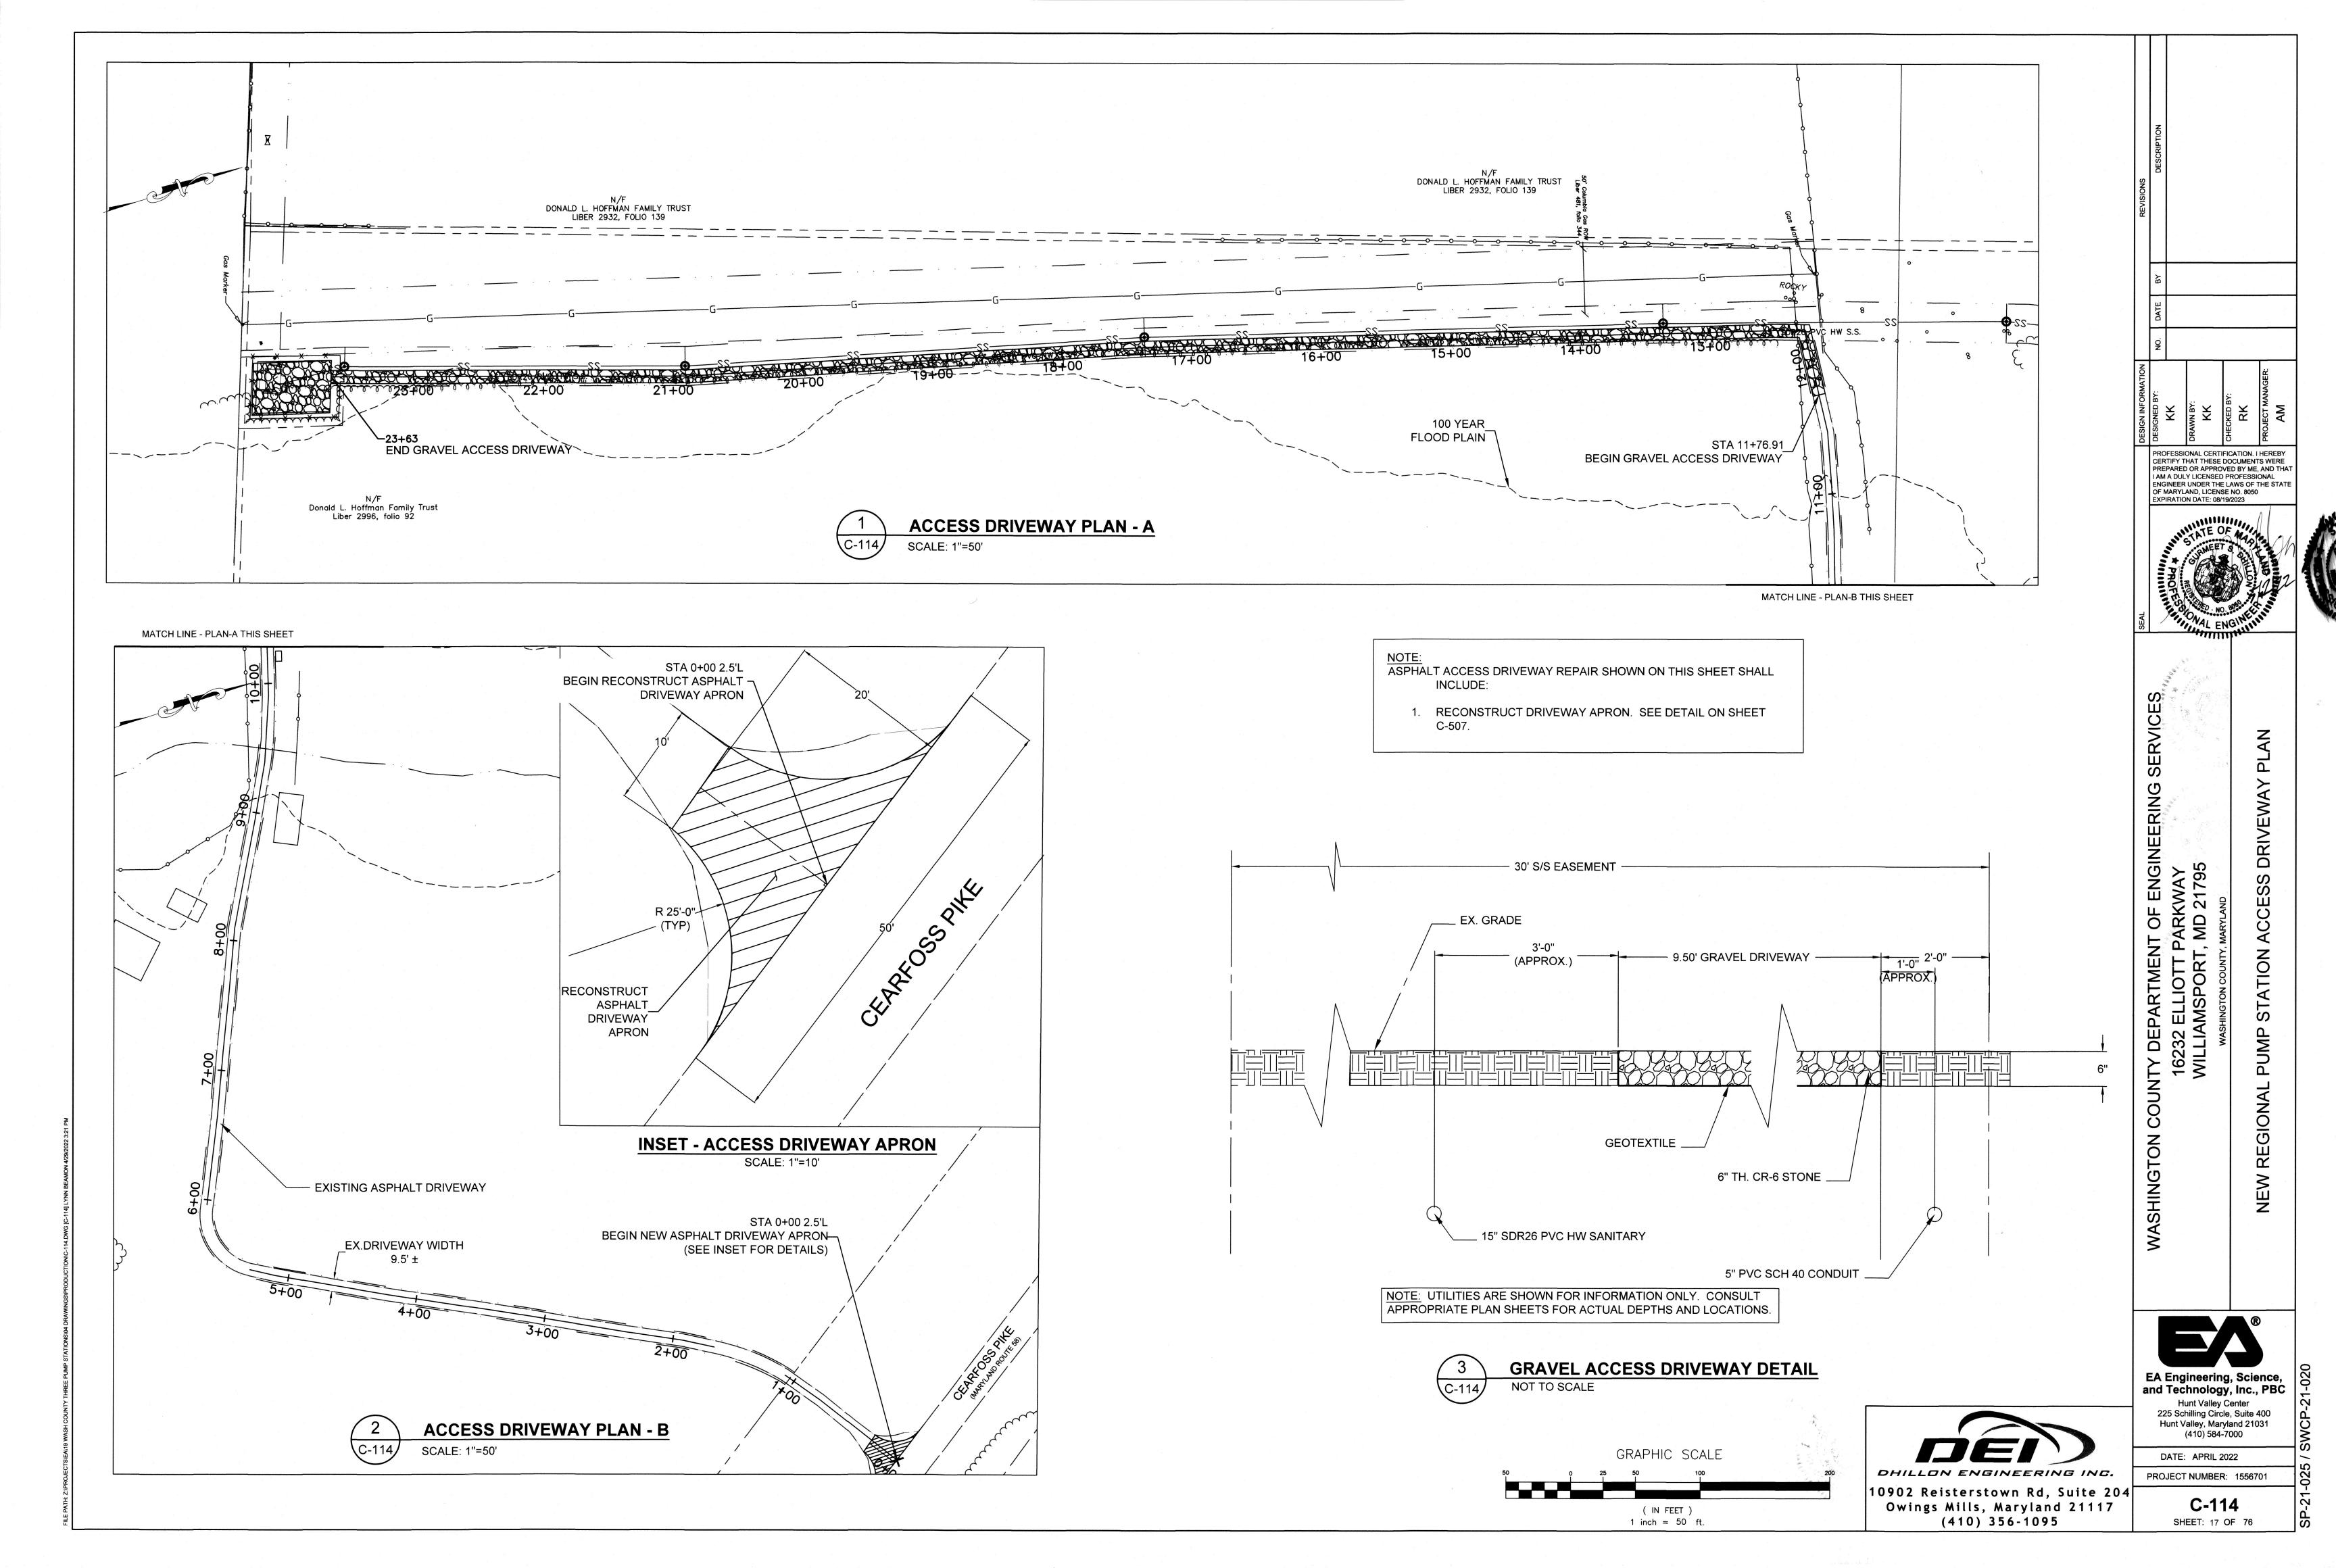

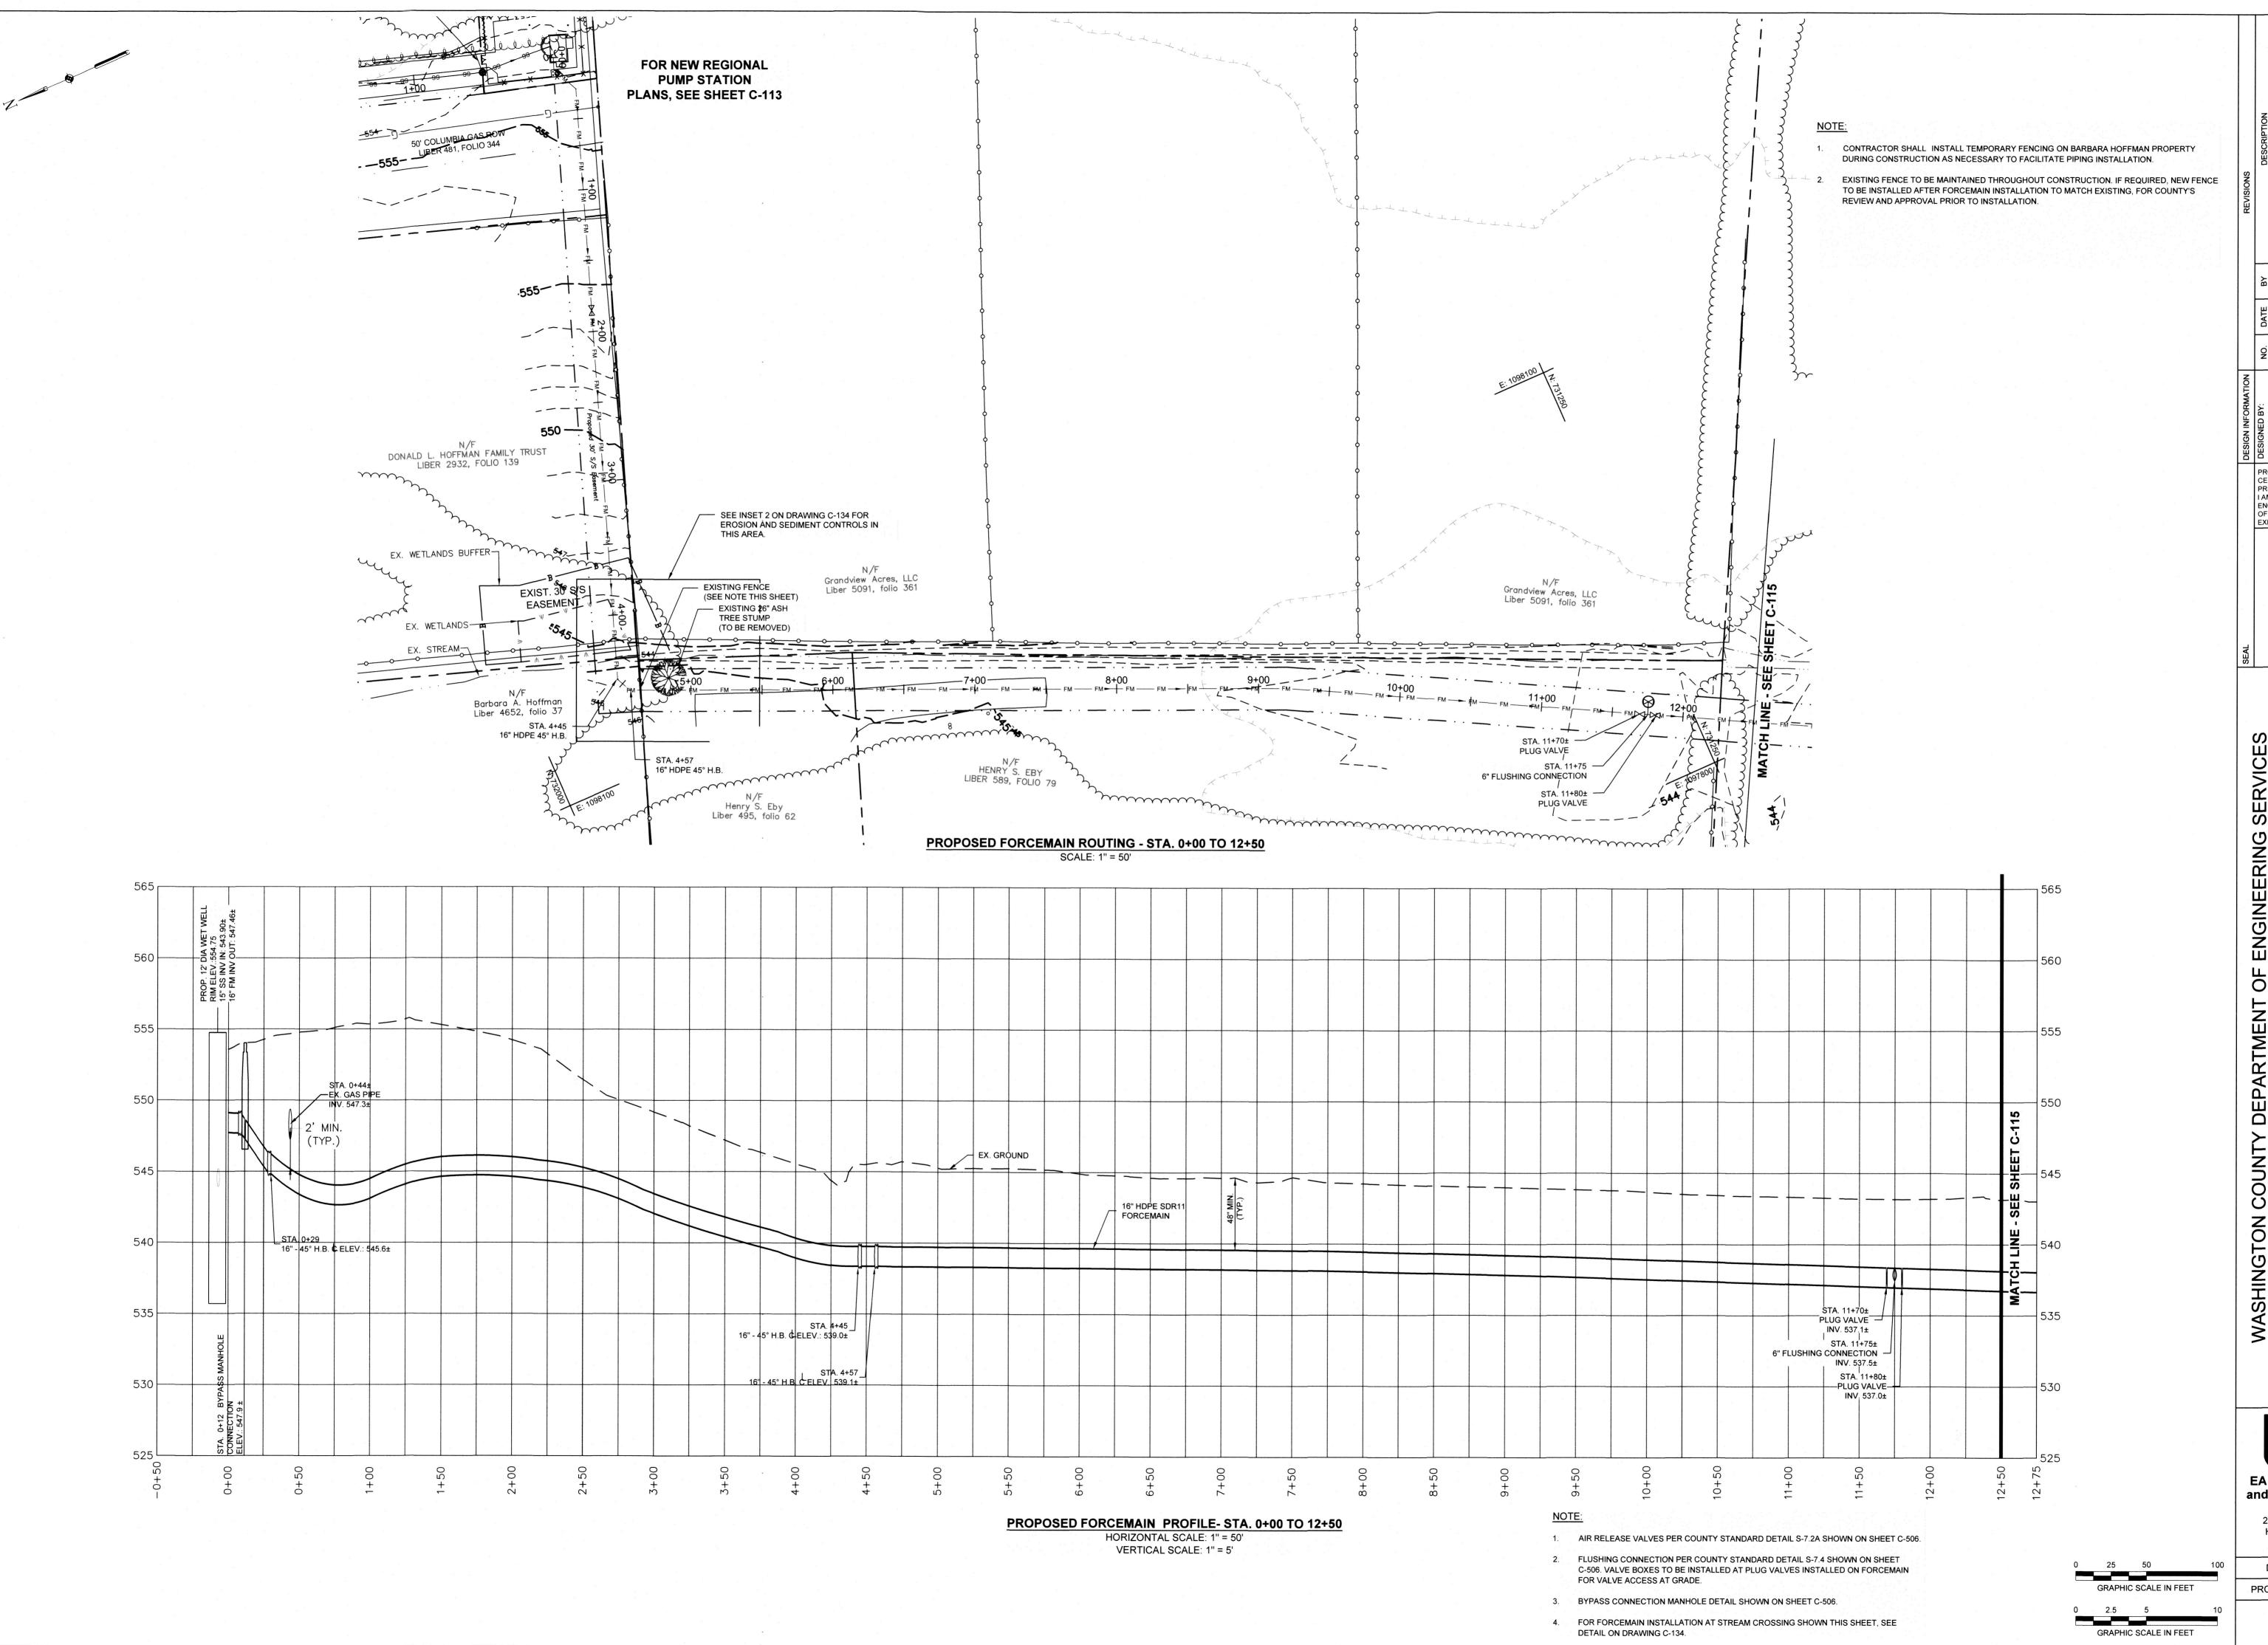

PROFESSIONAL CERTIFICATION. I HEREBY CERTIFY THAT THESE DOCUMENTS WERE PREPARED OR APPROVED BY ME, AND THAT I AM A DULY LICENSED PROFESSIONAL ENGINEER UNDER THE LAWS OF THE STATE

OUNTY DEPARTMENT OF ENGINI 16232 ELLIOTT PARKWAY WILLIAMSPORT, MD 21795

Ó

EA Engineering, Science, and Technology, Inc., PBC


Hunt Valley Center

225 Schilling Circle, Suite 400
Hunt Valley, Maryland 21031
(410) 584-7000 (410) 584-7000

DATE: APRIL 2022

PROJECT NUMBER: 1556701

C-115 SHEET: 18 OF 76

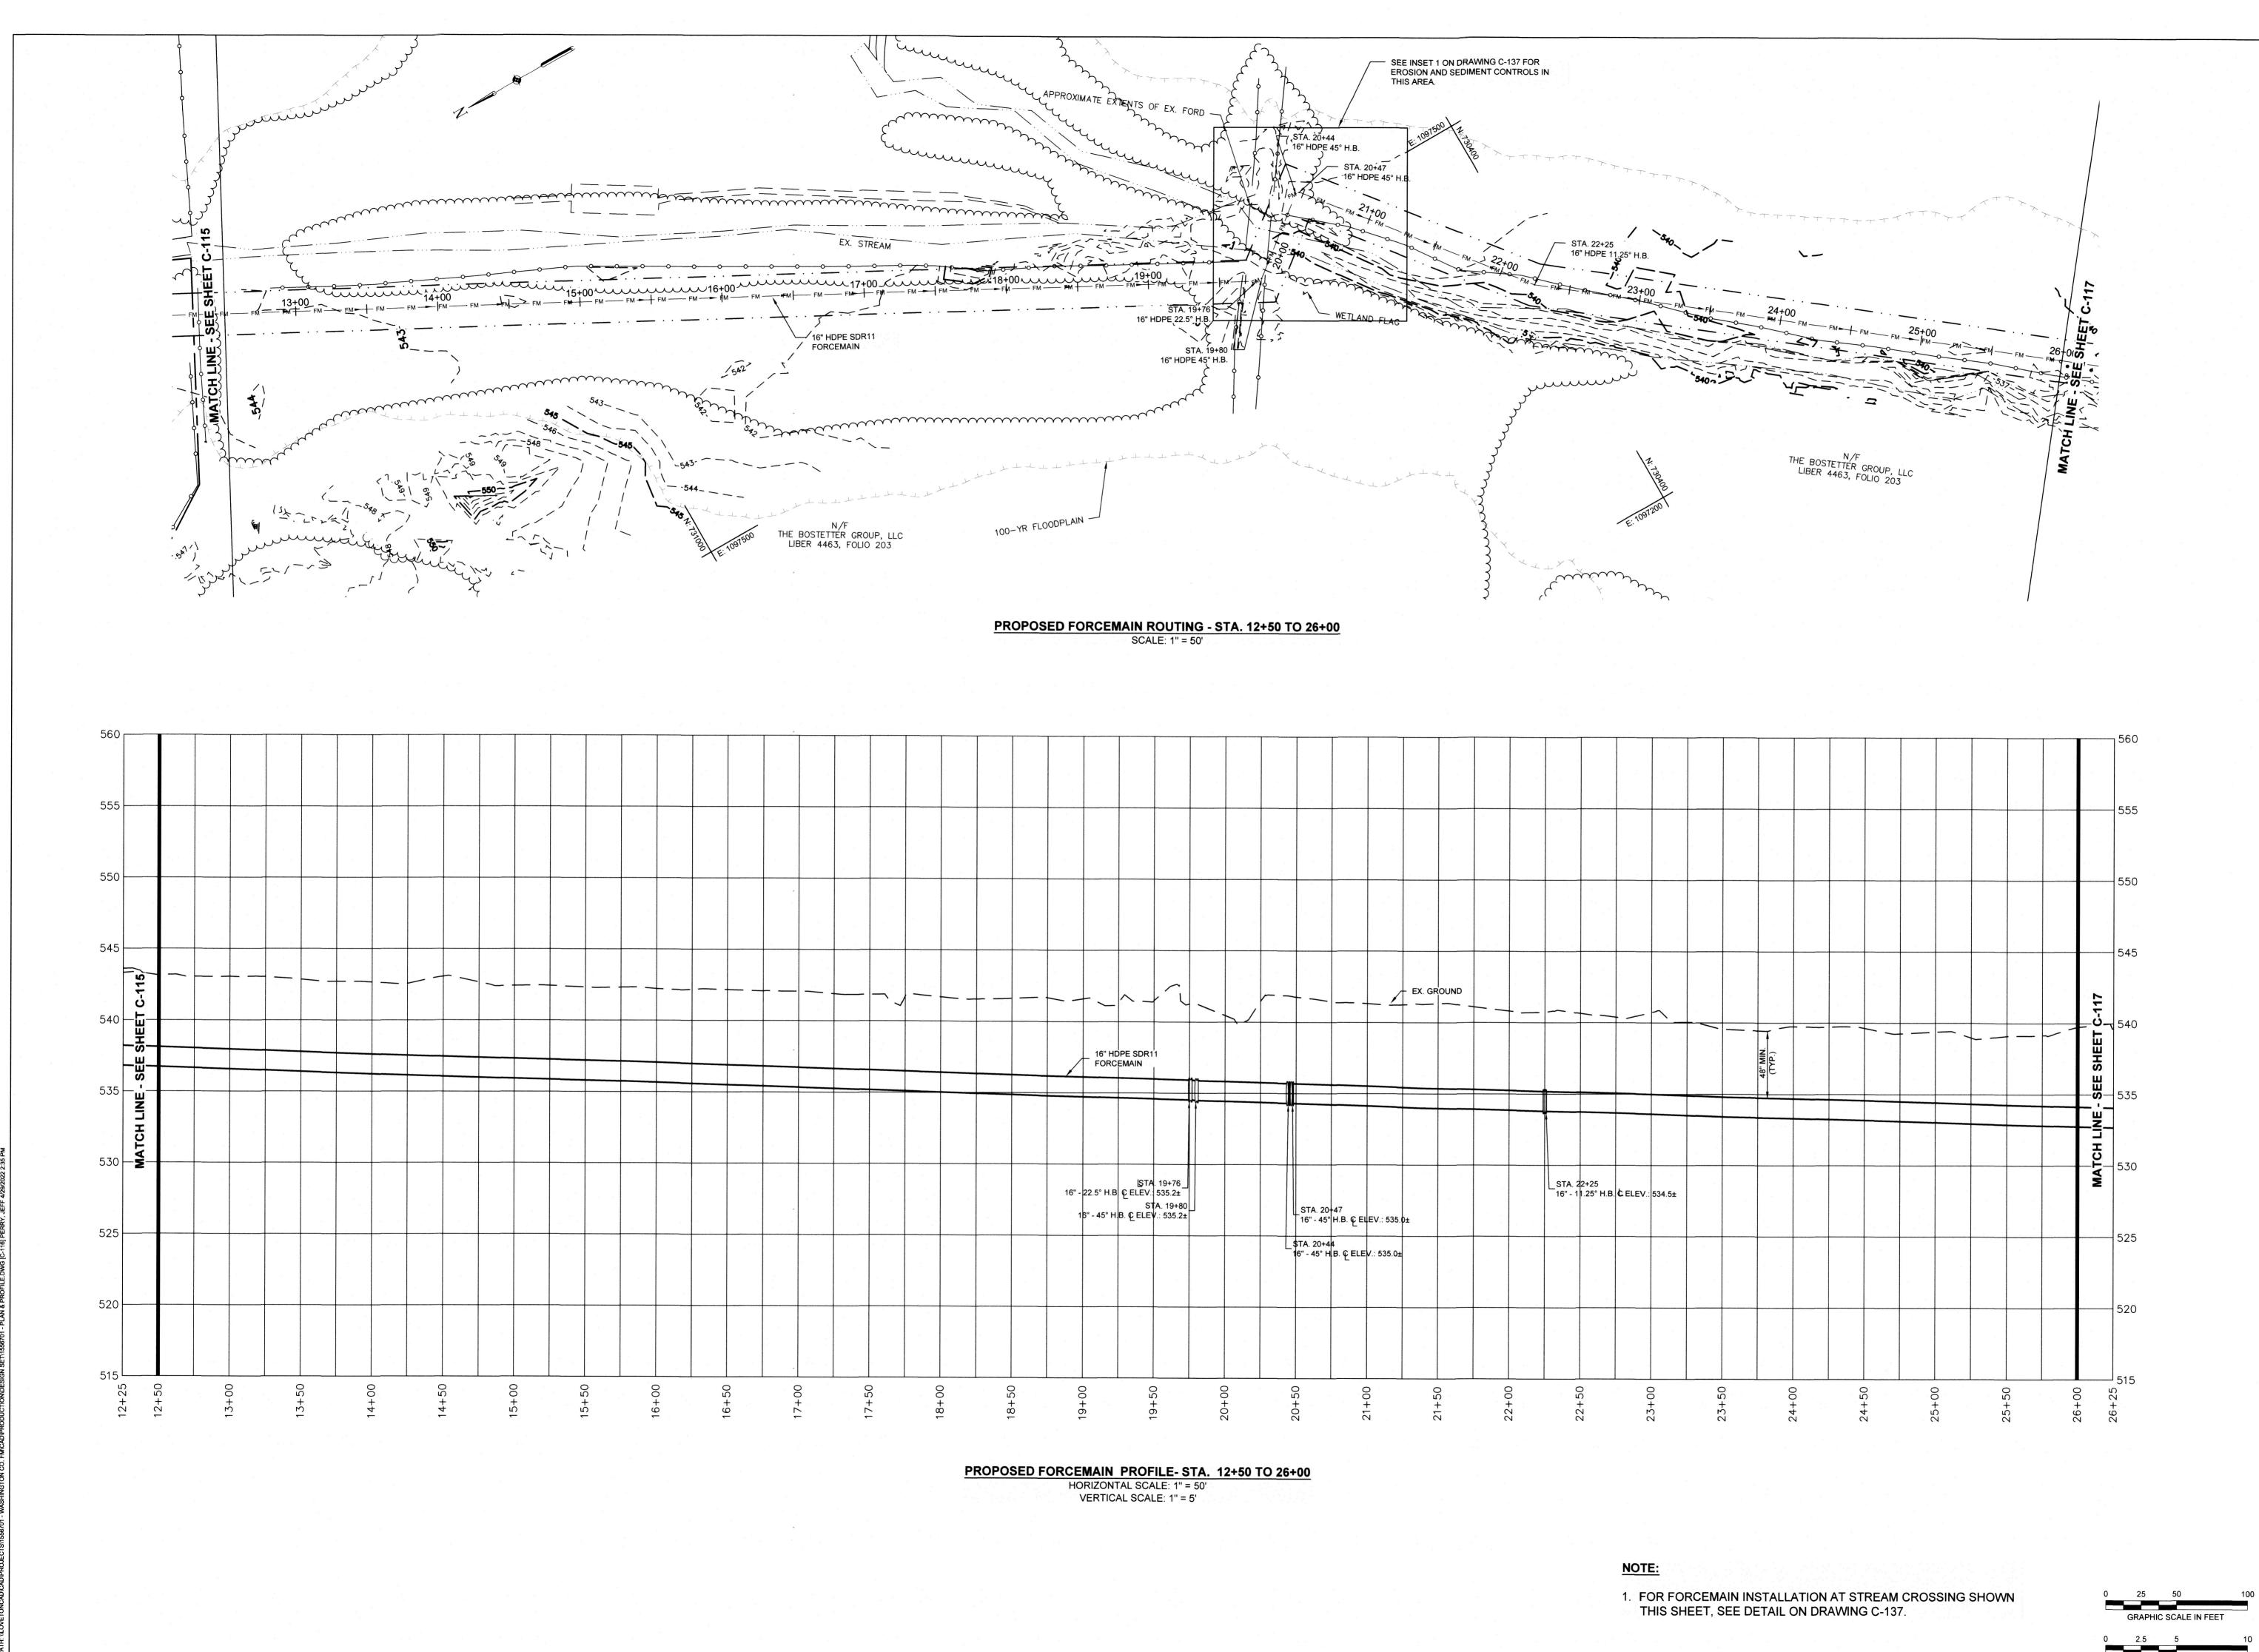

COUNTY DEPARTMENT OF ENGINEERI
16232 ELLIOTT PARKWAY
WILLIAMSPORT, MD 21795
WASHINGTON COUNTY, MARYLAND

FORCEMAIN

NEW

PROFESSIONAL CERTIFICATION, I HEREBY CERTIFY THAT THESE DOCUMENTS WERE PREPARED OR APPROVED BY ME, AND THAT

I AM A DULY LICENSED PROFESSIONAL ENGINEER UNDER THE LAWS OF THE STATE OF MARYLAND, LICENSE NO. 15453 EXPIRATION DATE: 7/02/2023


EA Engineering, Science, and Technology, Inc., PBC Hunt Valley Center 225 Schilling Circle, Suite 400 Hunt Valley, Maryland 21031 (410) 584-7000

DATE: APRIL 2022

PROJECT NUMBER: 1556701

GRAPHIC SCALE IN FEET

C-116 SHEET: 19 OF 76

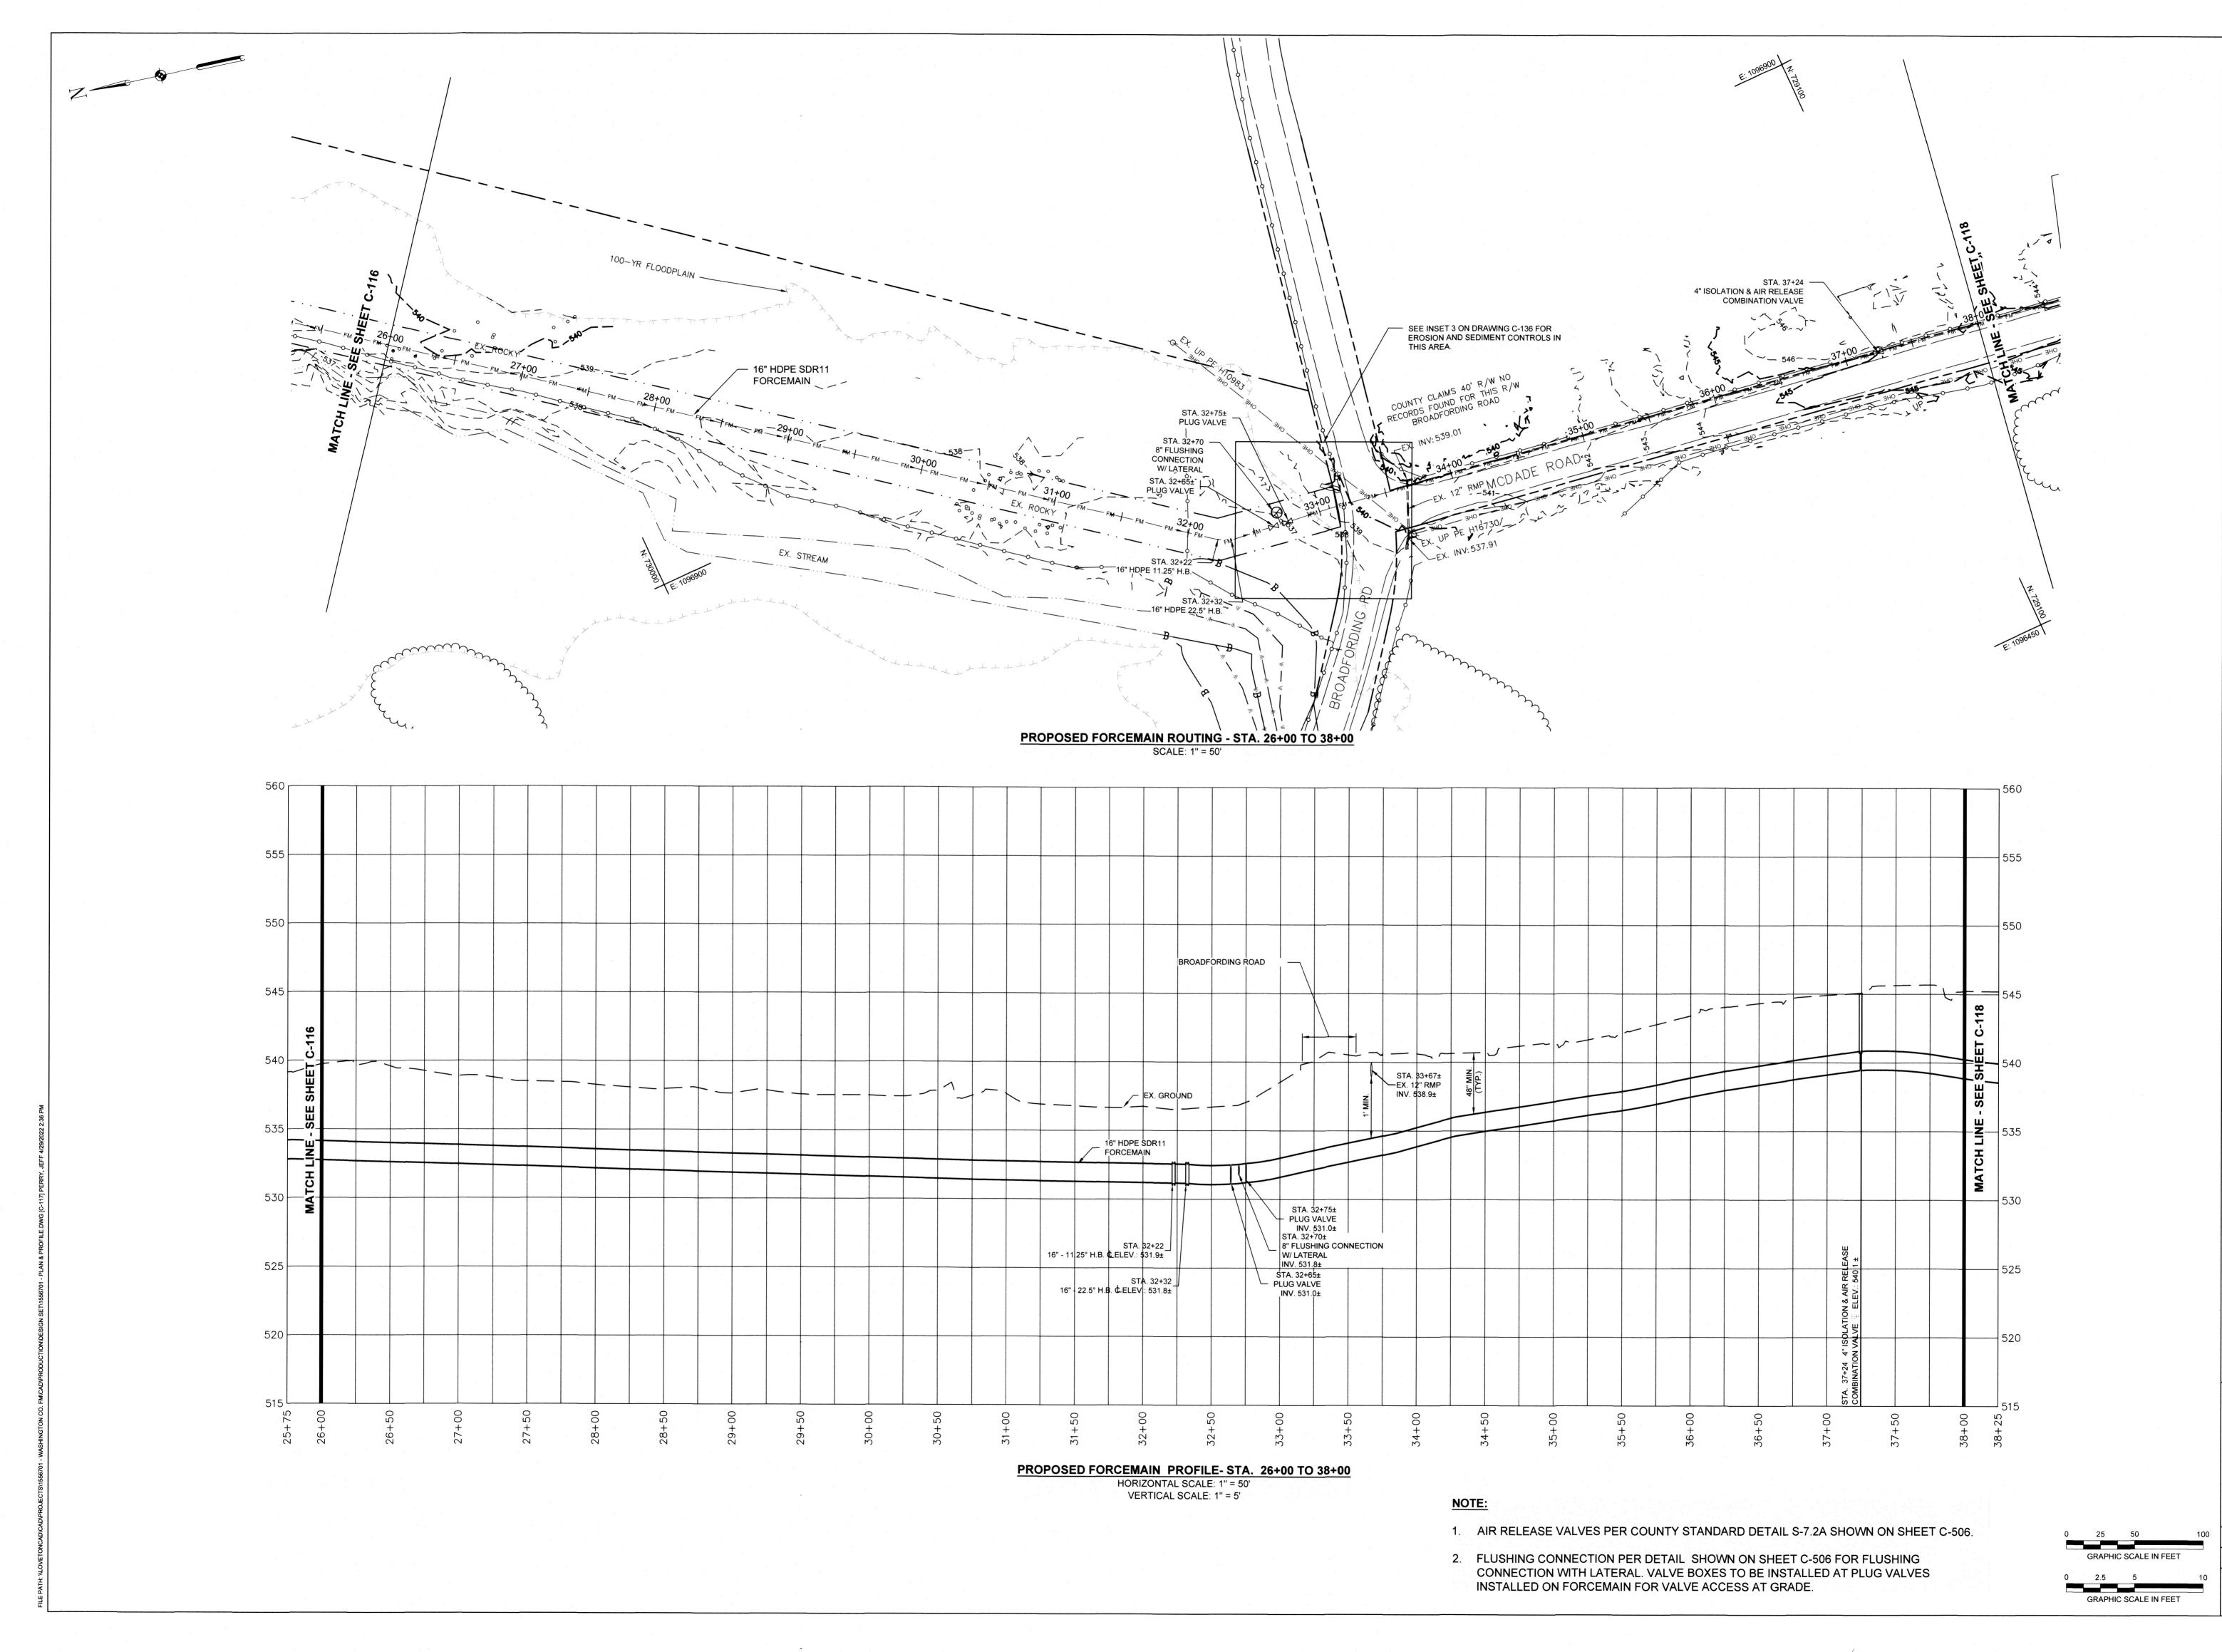

PROFESSIONAL CERTIFICATION. I HEREBY CERTIFY THAT THESE DOCUMENTS WERE PREPARED OR APPROVED BY ME, AND THAT I AM A DULY LICENSED PROFESSIONAL ENGINEER UNDER THE LAWS OF THE STATE

OF MARYLAND, LICENSE NO. 15453 EXPIRATION DATE: 7/02/2023

OUNTY DEPARTMENT OF ENGINEER 16232 ELLIOTT PARKWAY WILLIAMSPORT, MD 21795

EA Engineering, Science, and Technology, Inc., PBC

Hunt Valley Center

225 Schilling Circle, Suite 400
Hunt Valley, Maryland 21031
(410) 584-7000 Hunt Valley Center 225 Schilling Circle, Suite 400 Hunt Valley, Maryland 21031 (410) 584-7000

DATE: APRIL 2022

PROJECT NUMBER: 1556701

C-117 SHEET: 20 OF 76