GENERAL NOTES:

- GENERAL NOTES ON THIS DRAWING SHALL APPLY TO ALL TECHNOLOGY DRAWINGS ON THIS PROJECT. CAREFULLY READ ALL GENERAL NOTES PRIOR TO COMMENCEMENT OF WORK.
- ANY MATERIALS & DEVICES NOT SPECIFICALLY MENTIONED IN THESE SPECIFICATIONS 2 OR INDICATED ON THESE CONTRACT DRAWINGS THAT ARE REQUIRED FOR A COMPLETE FINISHED AND OPERATING SYSTEM INSTALLATION SHALL BE PROVIDED BY THE CONTRACTOR AT NO ADDITIONAL COST TO THE OWNER.
- WHERE THE TERM "PROVIDE" IS USED ON THE DRAWINGS, IT SHALL BE DEFINED AS FOLLOWS: FURNISH, INSTALL, & MAKE ALL FINAL CONNECTIONS FOR THE EQUIPMENT INDICATED.
- CABLE ROUTES ILLUSTRATED ARE DIAGRAMMATIC. EXACT ROUTING SHALL BE 4 DETERMINED IN FIELD BY THE CONTRACTOR & DOCUMENTED FOR FUTURE REFERENCE BY THE OWNER.
- ALL WORK SHALL BE IN ACCORDANCE WITH THE LATEST EDITION OF THE NATIONAL ELECTRICAL CODE & LOCAL AMENDMENTS.
- REFER TO ELECTRICAL DRAWINGS & DIVISION 16 SPECIFICATIONS FOR ELECTRICAL 6. ROUGH-IN, CONDUITS & BOXES. ANY CONDUIT, BOXES, & ASSOCIATED ROUGH-IN NOT INCLUDED IN DIVISION 26 SHALL BE PROVIDED UNDER DIVISION 27.

AMP	AMPERE, AMPERES
AFF	ABOVE FINISHED FLOOR
AFG	ABOVE FINISHED GRADE
AIC	AMPERE INTERRUPTING CAPACITY
AWG	AMERICAN WIRE GAUGE
С	CONDUIT
CAP	CAPACITY
CB	CIRCUIT BREAKER
CKT	CIRCUIT
	CONDUIT
COMP CTX	COMPUTER CONNECT TO EXISTING
DIA	DIAMETER
DWG	DRAWING
EC	ELECTRICAL CONTRACTOR
ETR	EXISTING TO REMAIN
EWC	ELECTRIC WATER COOLER
EX	EXISTING
EXIST	EXISTING
FACP	FIRE ALARM CONTROL PANEL
FLA	FULL LOAD AMPERES
FRM	FRAME
GFI	GROUND FAULT INTERRUPTING
G	GROUND
GND	GROUND
IDF	INTERMEDIATE DISTRIBUTION FRAME
IMC	INTERMEDIATE METAL CONDUIT
KCMIL KVA	THOUSAND CIRCULAR MILS KILOVOLT-AMPERES
KW	KILOWATT
LRA	LOCKED ROTOR AMPERES
MČA	MINIMUM CIRCUIT AMPACITY
MCB	MAIN CIRCUIT BREAKER
MCP	MOTOR CIRCUIT PROTECTOR
MDF	MAIN DISTRIBUTION FRAME
MDP	MAIN DISTRIBUTION PANEL
MFS	MAXIMUM FUSE SIZE
MH MIN	MOUNTING HEIGHT/MANHOLE MINIMUM
MLO	MAIN LUGS ONLY
MTD	MOUNTED
NEC	NATIONAL ELECTRICAL CODE
NEMA	NATIONAL ELECTRICAL
	MANUFACTURER'S ASSOCIATION
NFSS	NONFUSED SAFETY SWITCH
NIC	NOT IN CONTRACT
NO OC	NUMBER ON CENTER
P	POLE, POLES
Ø	PHASE
PNL	PANEL
PVC	POLYVINYL CHLORIDE
REC	RECEPTACLE
RECEPT	
RGS	RIGID GALVANIZED STEEL
RM	ROOM
RX TTB	REMOVE EXISTING TELEPHONE TERMINAL BOARD
ТҮР	TYPICAL
TTB	TELEPHONE TERMINAL BOARD
UG	UNDERGROUND
UON	UNLESS OTHERWISE NOTED
UPS	UNINTERRUPTABLE POWER SUPPLY
V	VOLT, VOLTS
W	WATTS/WIRE, WIRES
WG	WIREGUARD
WP	WEATHERPROOF
XFMR	TRANSFORMER

ABBREVIATIONS:

AMPERE, AMPERES

А

<u>NOTE:</u>	TECHNOLOGY LEGEND: ALL MOUNTING HEIGHTS AND LOCATIONS OF EQUIPMENT SHALL BE COORDINATED IN THE FIELD BY THE CONTRACTOR PRIOR TO ROUGH-IN.
\	DATA DATA OUTLET: SUBSCRIPT DENOTES QUANTITY. M.H. 18" AFF. SEE DETAILS 4/T4.2
v ⊲C	DATA OUTLET CEILING MOUNTED - REFER TO DETAILS 11,12/T4.2. WIRELESS DATA OUTLET ABOVE CEILING DATA OUTLET WITH 10 FEET OF CAT 6 CABLING COILED ABOVE CEILING FOR CONNECTION TO WIRELESS ACCESS POINT (BY OWNER'S VENDOR) REFER TO DETAIL 11,12/T4.2.
4 ▽	FLOOR BOX WITH DATA OUTLET
•	TELEPHONE OUTLET: M.H. 18" AFF. SEE DETAILS ON DRAWING T4.2.
	WALL MOUNTED 12" WIDE BY 4" DEEP BASKET TYPE CABLE TRAY AND CLEARANCE SPACE.

MOUNTING HEIGHT SHALL BE 3" TO BOTTOM OF TRAY ABOVE LAY-IN CEILING UNLESS

OTHERWISE NOTED. REFER TO ARCHITECTURAL REFLECTED CEILING PLANS FOR CEILING HEIGHTS.

\sum	EQUIPMENT RACK/CABINET.
Η	HANDHOLE/EXTERIOR J-BOX - REFER TO DETAIL T0.2
	PULLBOX: SIZE AS INDICATED
$\vdash (J)$	JUNCTION BOX, WALL MOUNTED
]	CONDUIT, CONDUIT SLEEVE - SIZE AND QUANTITY AS INDICATED.
Ĵ	JUNCTION BOX
	<u>SECURITY</u>
S	SECURITY SYSTEM SIREN - CEILING MOUNTED.
DC	DOOR CONTACTS
⊲#	CEILING/FIXED MOUNTED CCTV CAMERA. SEE DETAILS & SCHEDUI
 #	WALL MOUNTED CCTV CAMERA. SEE DETAILS AND SCHEDULE ON
#	

MD

	<u>SECURITY</u>
S	SECURITY SYSTEM SIREN - CEILING MOUNTED.
DC	DOOR CONTACTS
⊲#	CEILING/FIXED MOUNTED CCTV CAMERA. SEE DETAILS & SCHEDULE ON DRAWING T4.4.
⊲#	WALL MOUNTED CCTV CAMERA. SEE DETAILS AND SCHEDULE ON DRAWING T4.4.
⊲#	CORNER WALL MOUNTED CCTV CAMERA. SEE DETAILS AND SCHEDULE ON DRAWING T4.4.
PS	CCTV CAMERA POWER SUPPLY
κ	SECURITY SYSTEM KEYPAD; MOUNT AT 4'-0" AFF.
CR	CARD READER
IC	VIDEO DOOR STATION
	VIDEO ENTRY MASTER DOOR CONTROL STATION
	CARD READER - REFER TO ACCESS CONTROL SYSTEM CARD READER DETAIL - SHEET T-504. FOR ADDITIONAL INFORMATION.
	MOTION DETECTOR



MISCELLANEOUS:

DENOTES REFERENCE TO DRAWING NOTE DENOTES REFERENCE TO REVISIONS TO DRAWING

CONVENTIONS:


DETAIL NUMBER

1

E#.#


#/E#.#


DRAWING NUMBER WHERE DETAIL IS LOCATED DETAIL REFERENCE: DETAIL NUMBER/DRAWING NUMBER

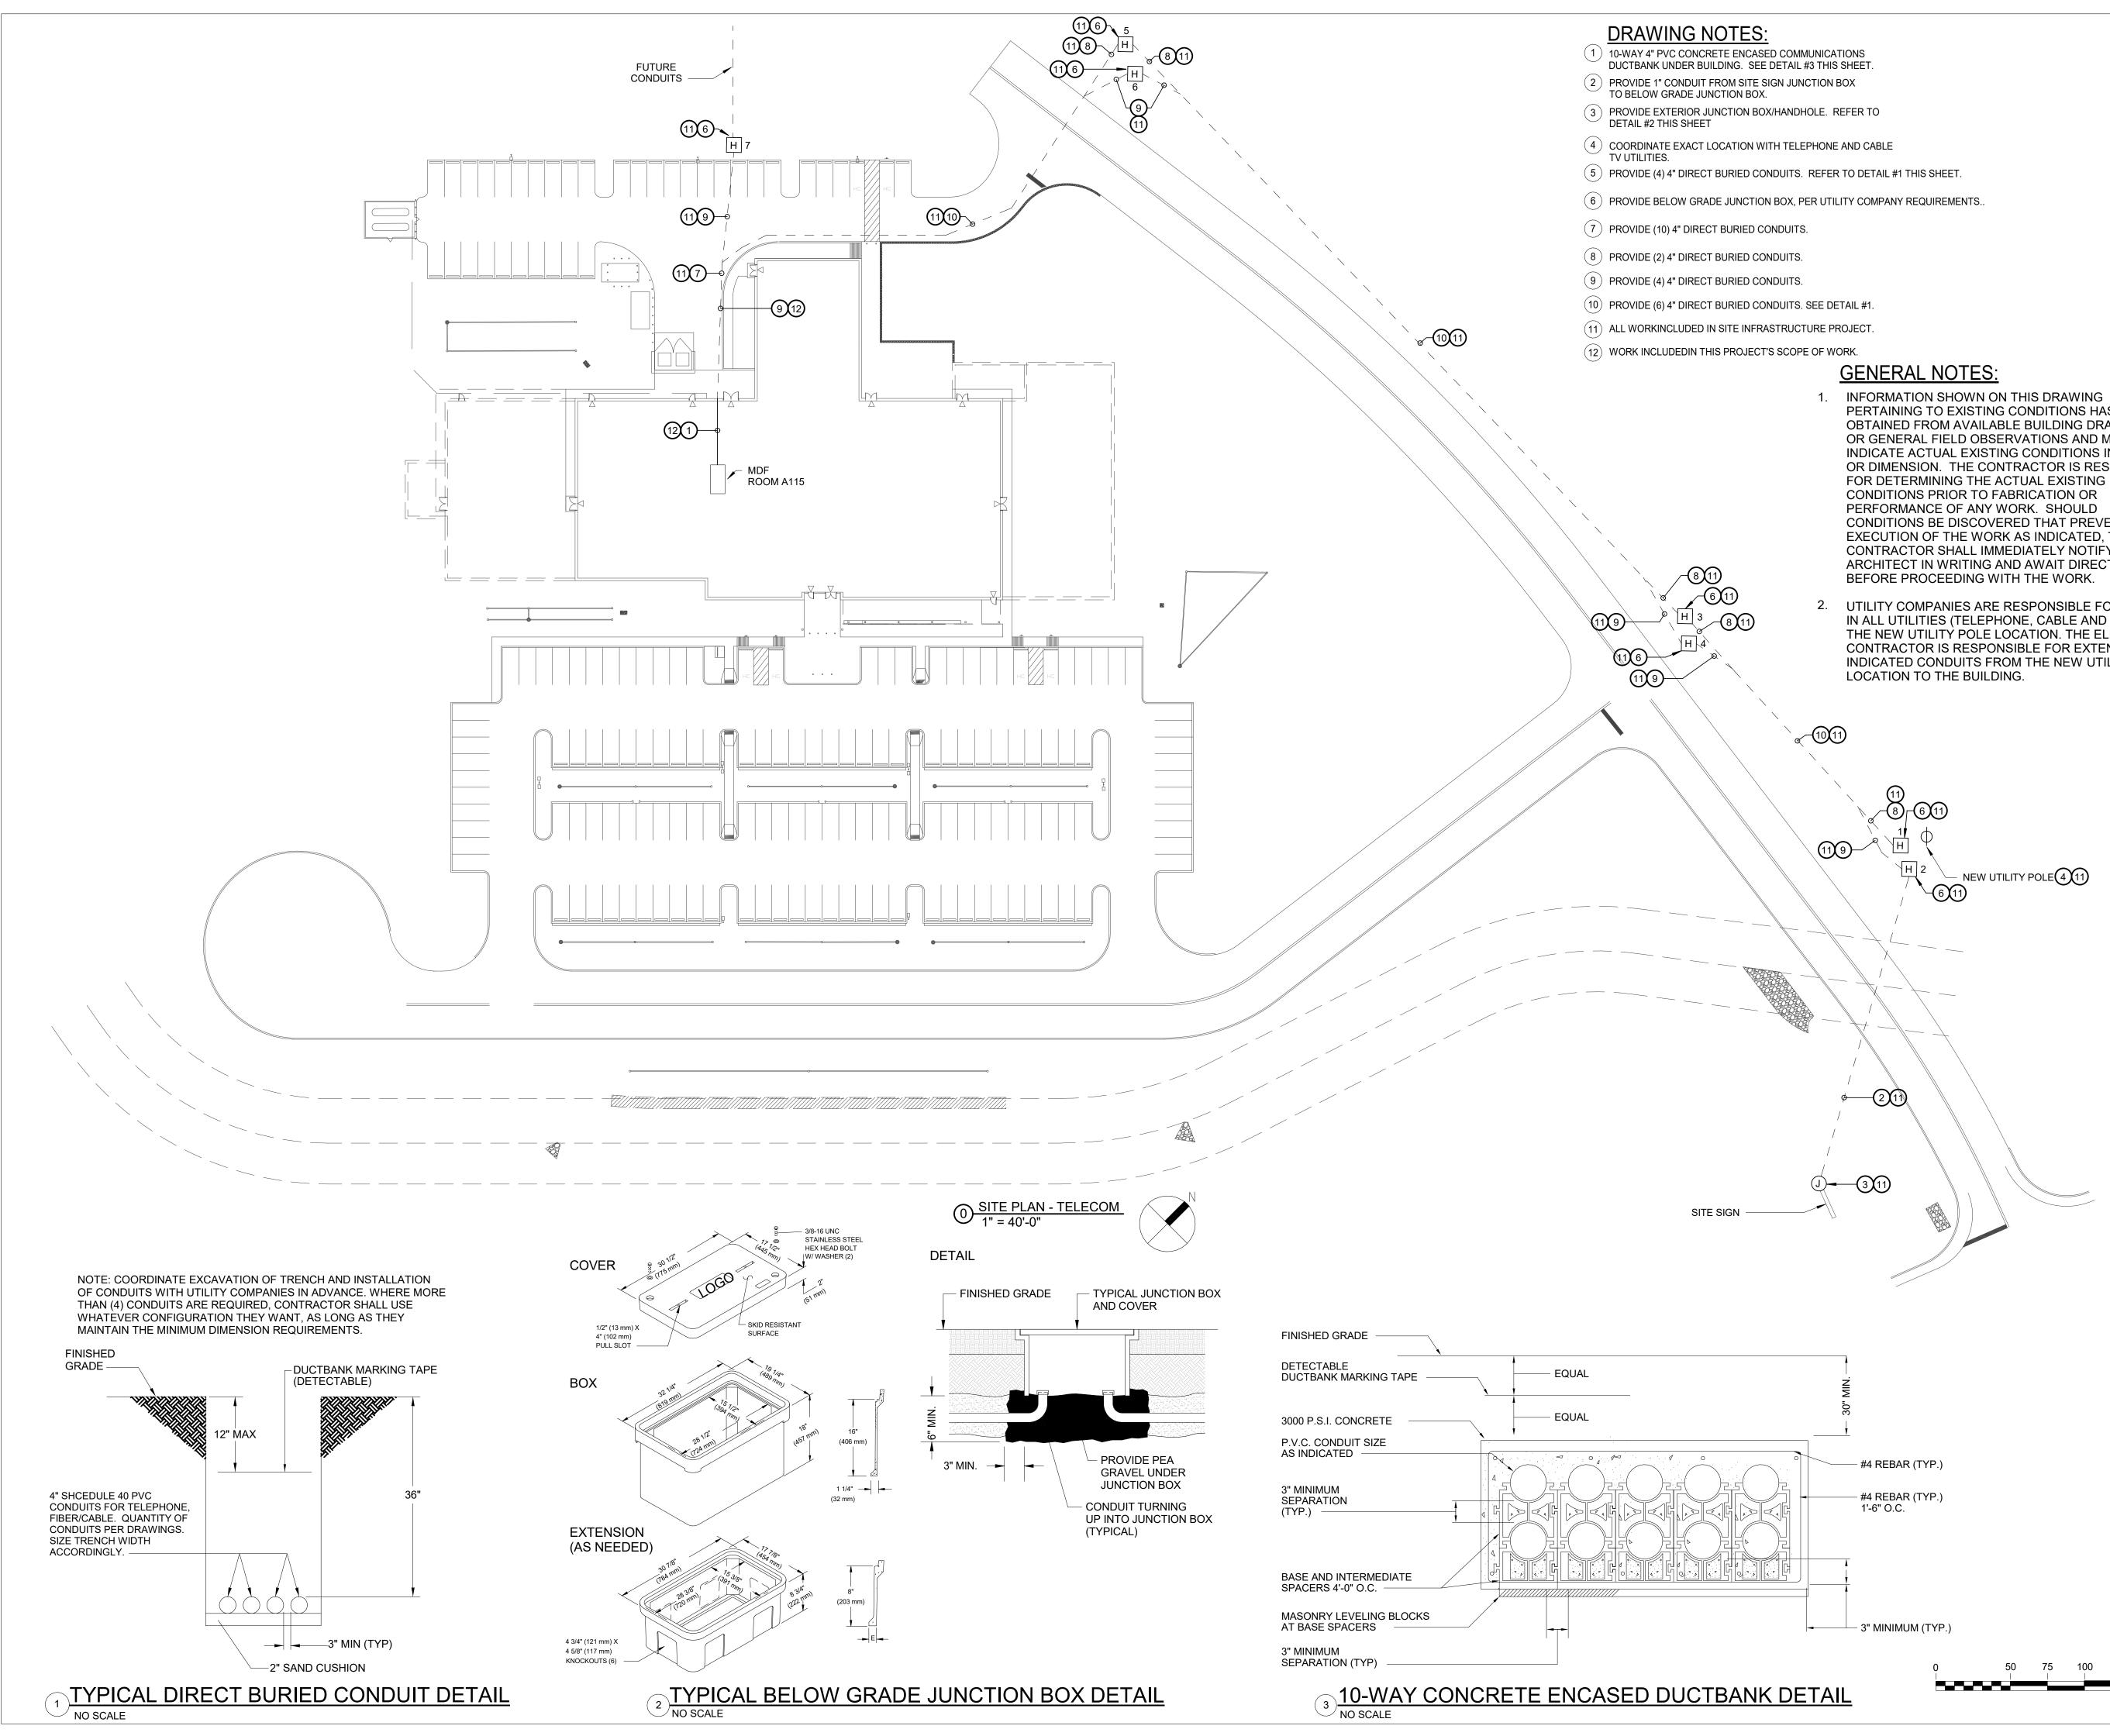




- PERTAINING TO EXISTING CONDITIONS HAS BEEN OBTAINED FROM AVAILABLE BUILDING DRAWINGS OR GENERAL FIELD OBSERVATIONS AND MY NOT INDICATE ACTUAL EXISTING CONDITIONS IN DETAIL OR DIMENSION. THE CONTRACTOR IS RESPONSIBLE CONDITIONS BE DISCOVERED THAT PREVENT EXECUTION OF THE WORK AS INDICATED, THE CONTRACTOR SHALL IMMEDIATELY NOTIFY THE ARCHITECT IN WRITING AND AWAIT DIRECTION
- UTILITY COMPANIES ARE RESPONSIBLE FOR BRINING IN ALL UTILITIES (TELEPHONE, CABLE AND DATA) TO THE NEW UTILITY POLE LOCATION. THE ELECTRICAL CONTRACTOR IS RESPONSIBLE FOR EXTENDING THE INDICATED CONDUITS FROM THE NEW UTILITY POLE

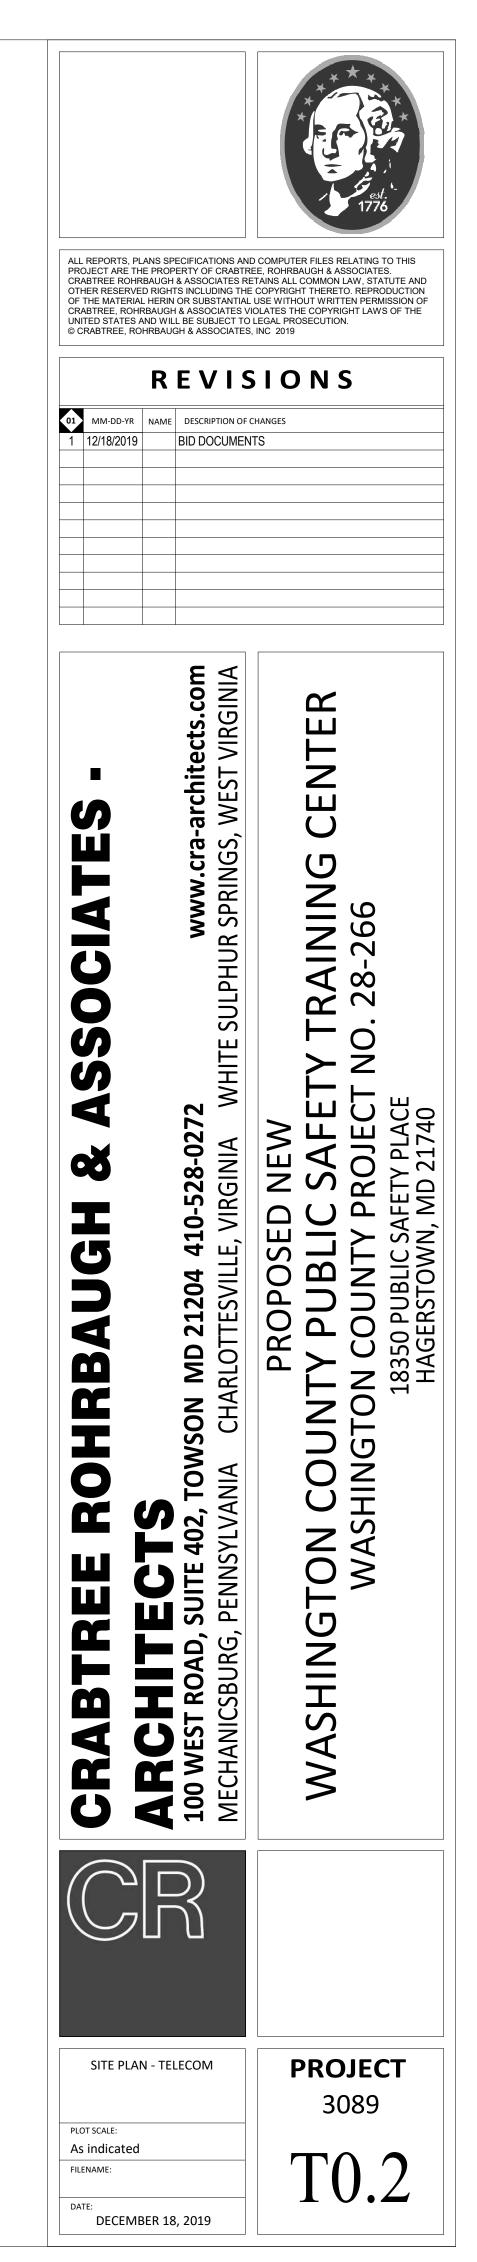


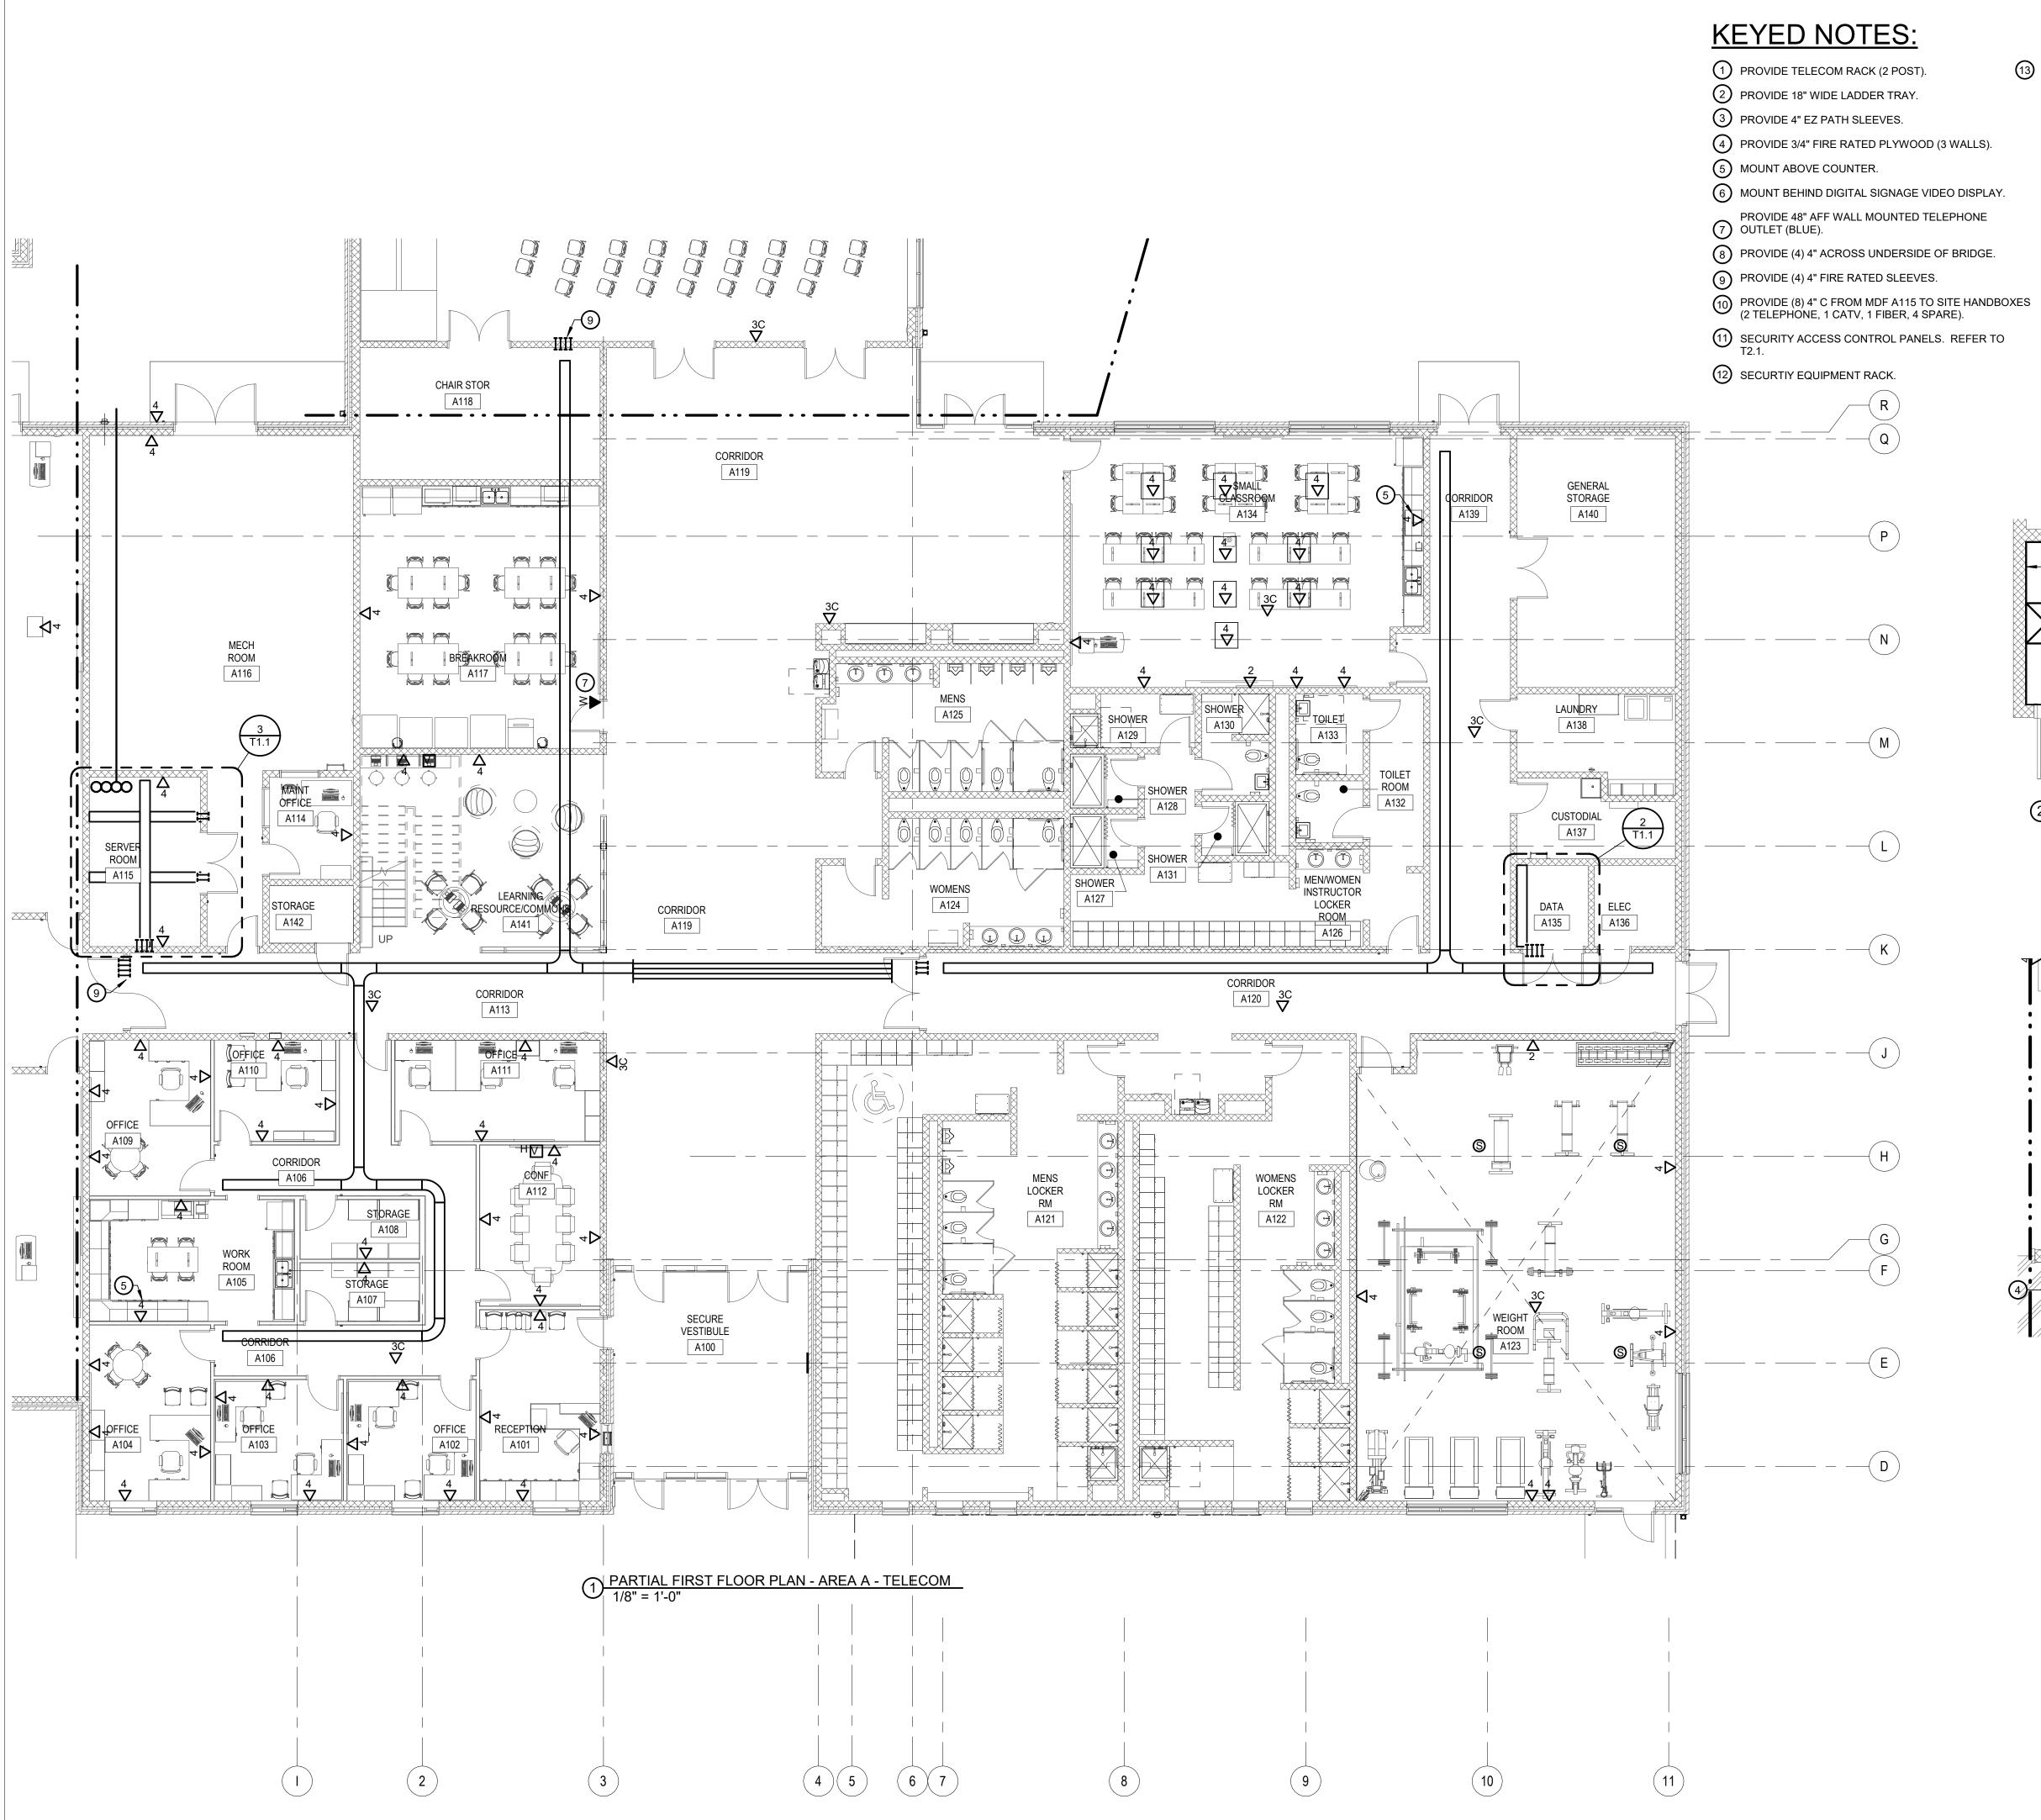


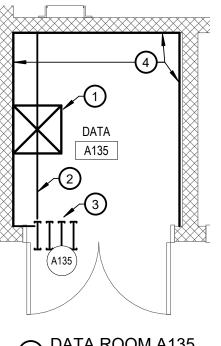



(13) MOUNT AT 10'-0" AFF BELOW ACOUSTIC WALL PANELS.

2 DATA ROOM A135 1/4" = 1'-0"

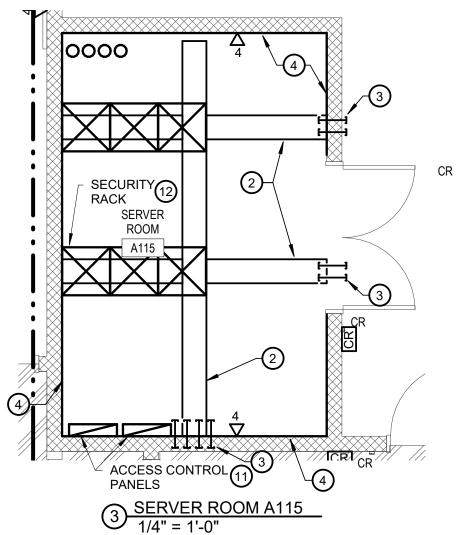

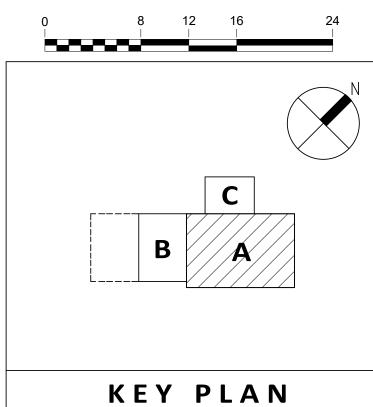

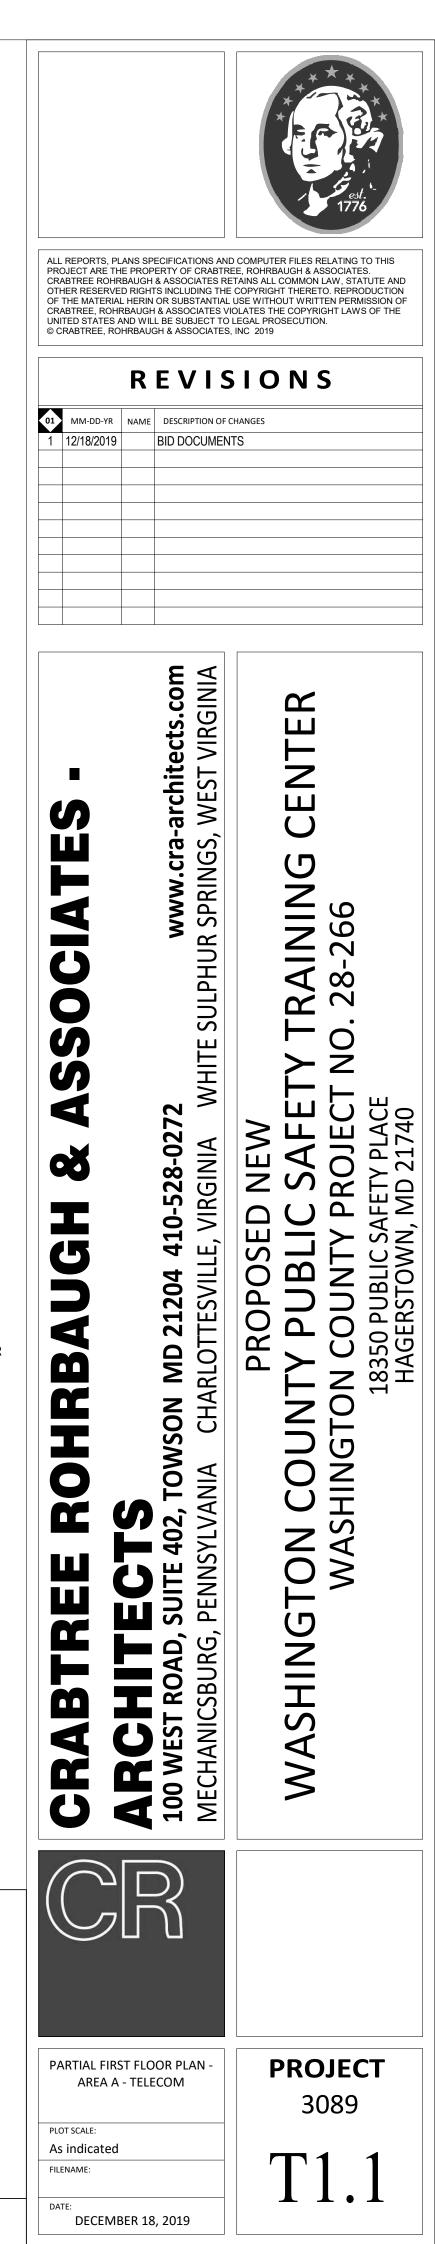


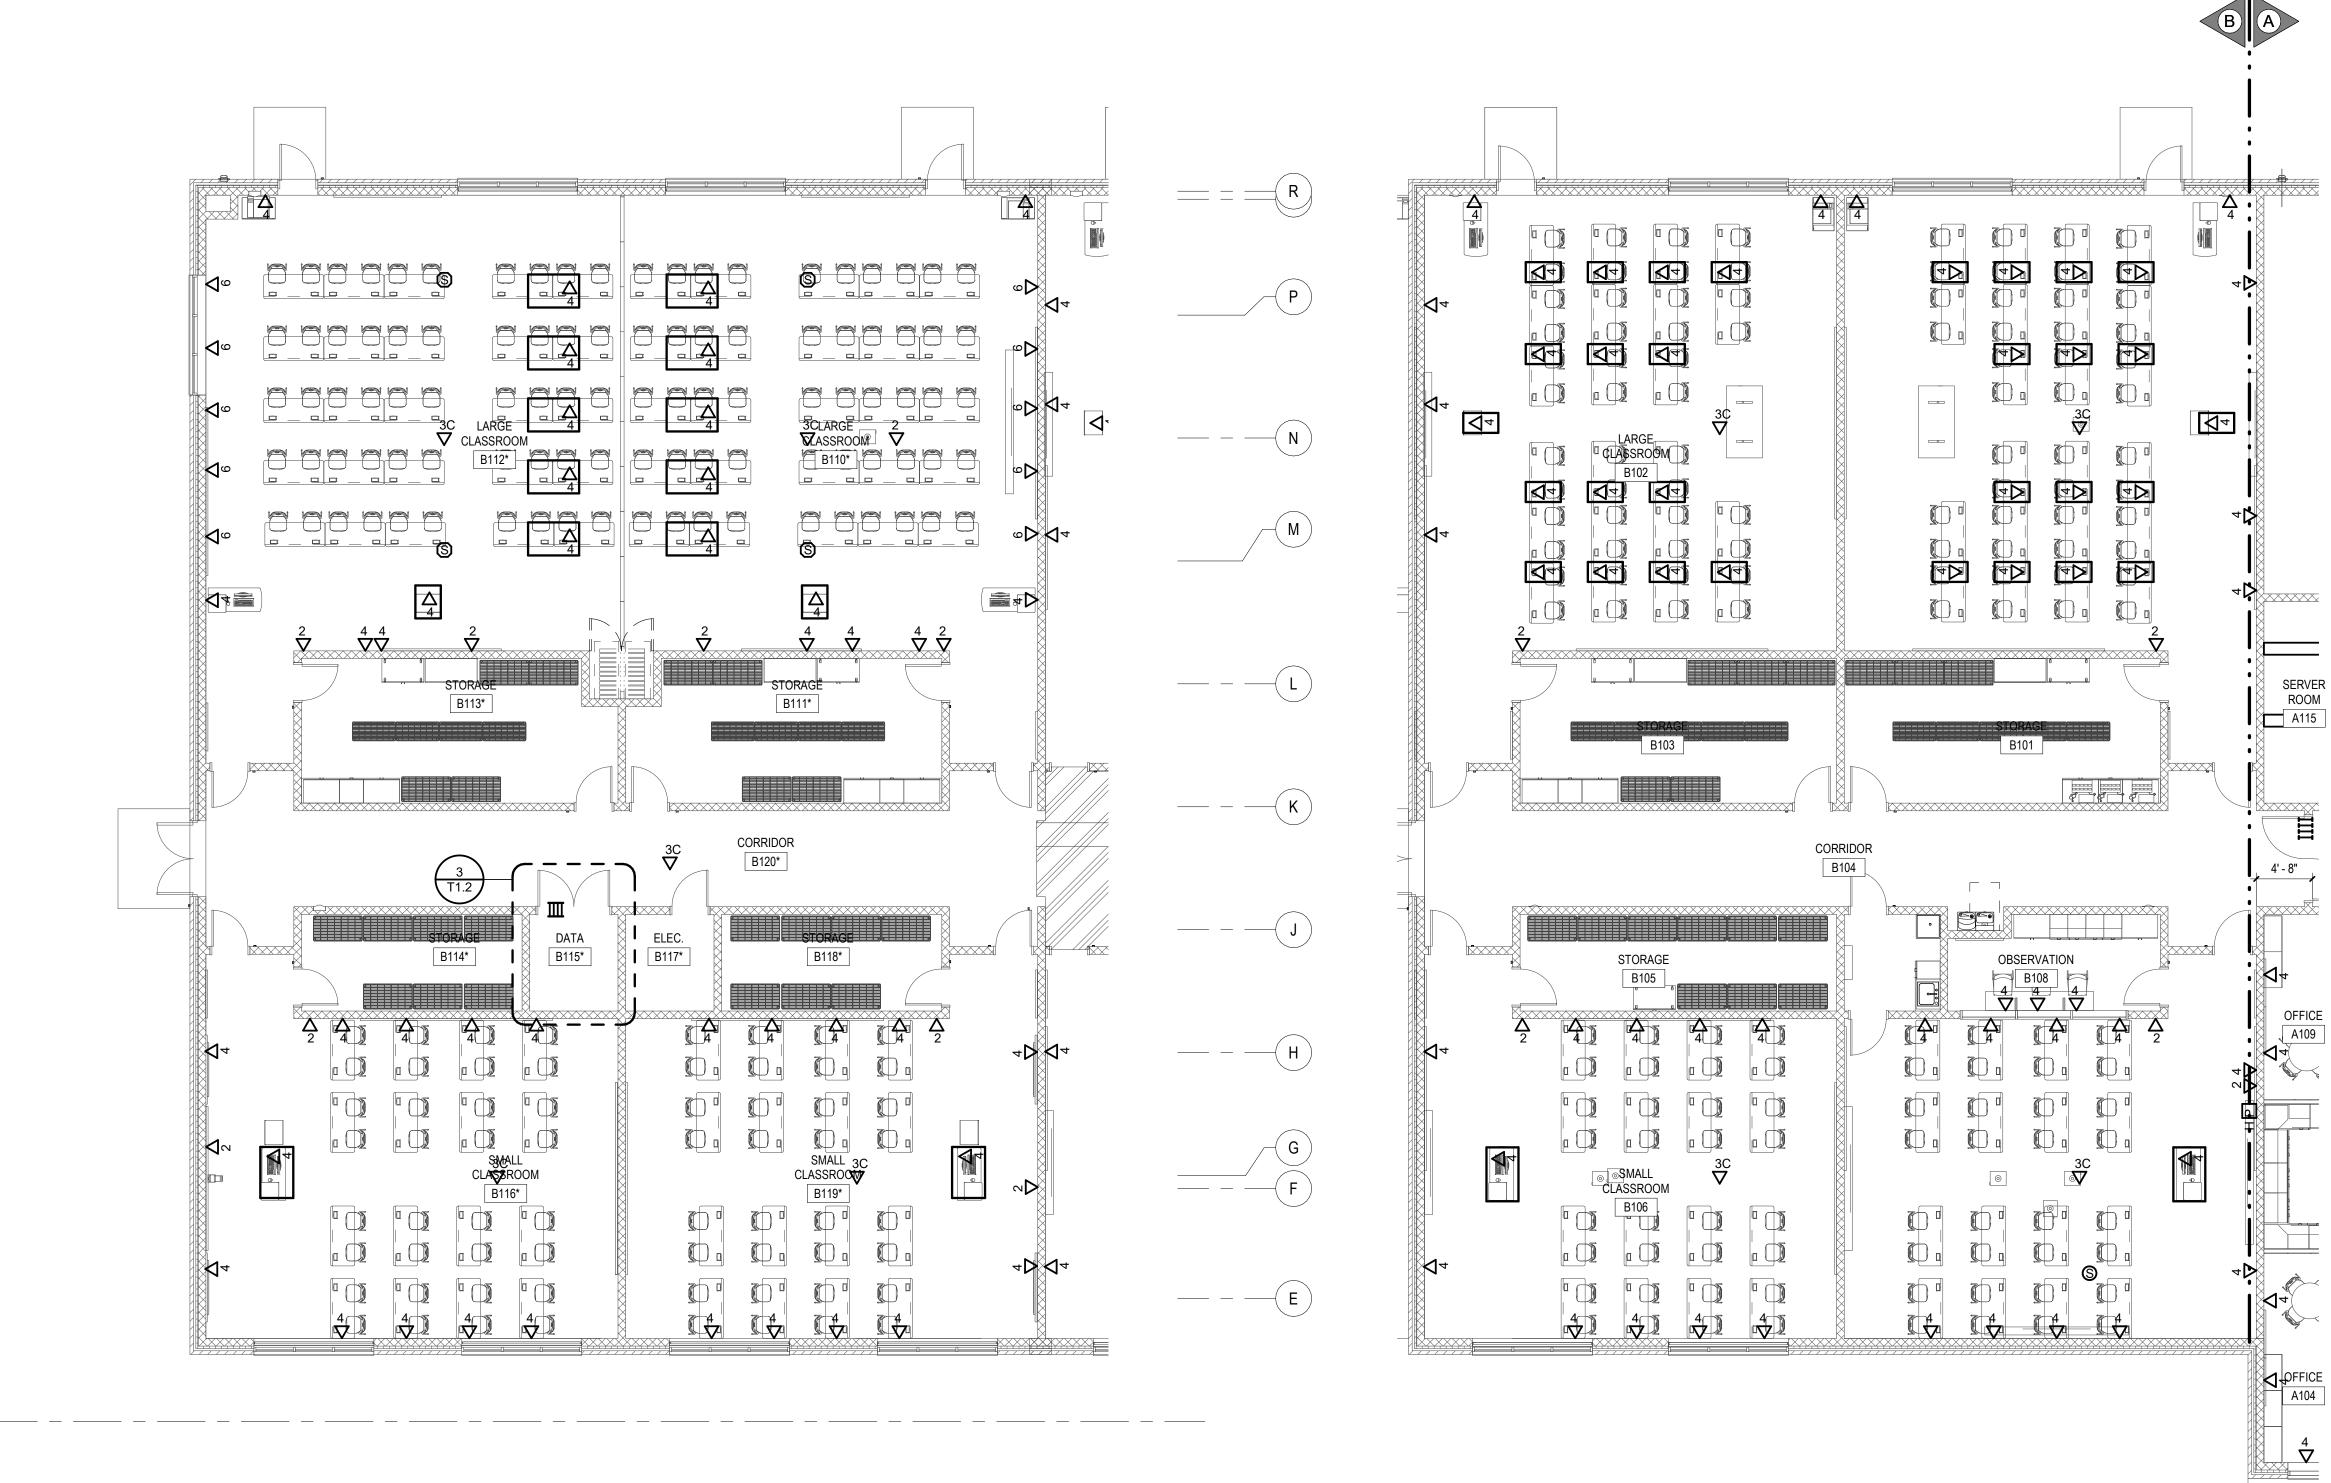


2 PARTIAL FIRST FLOOR PLAN - AREA B ALT - TELECOM 1/8" = 1'-0"

PARTIAL FIRST FLOOR PLAN - AREA B - TELECOM
1/8" = 1'-0"

3' - 4"

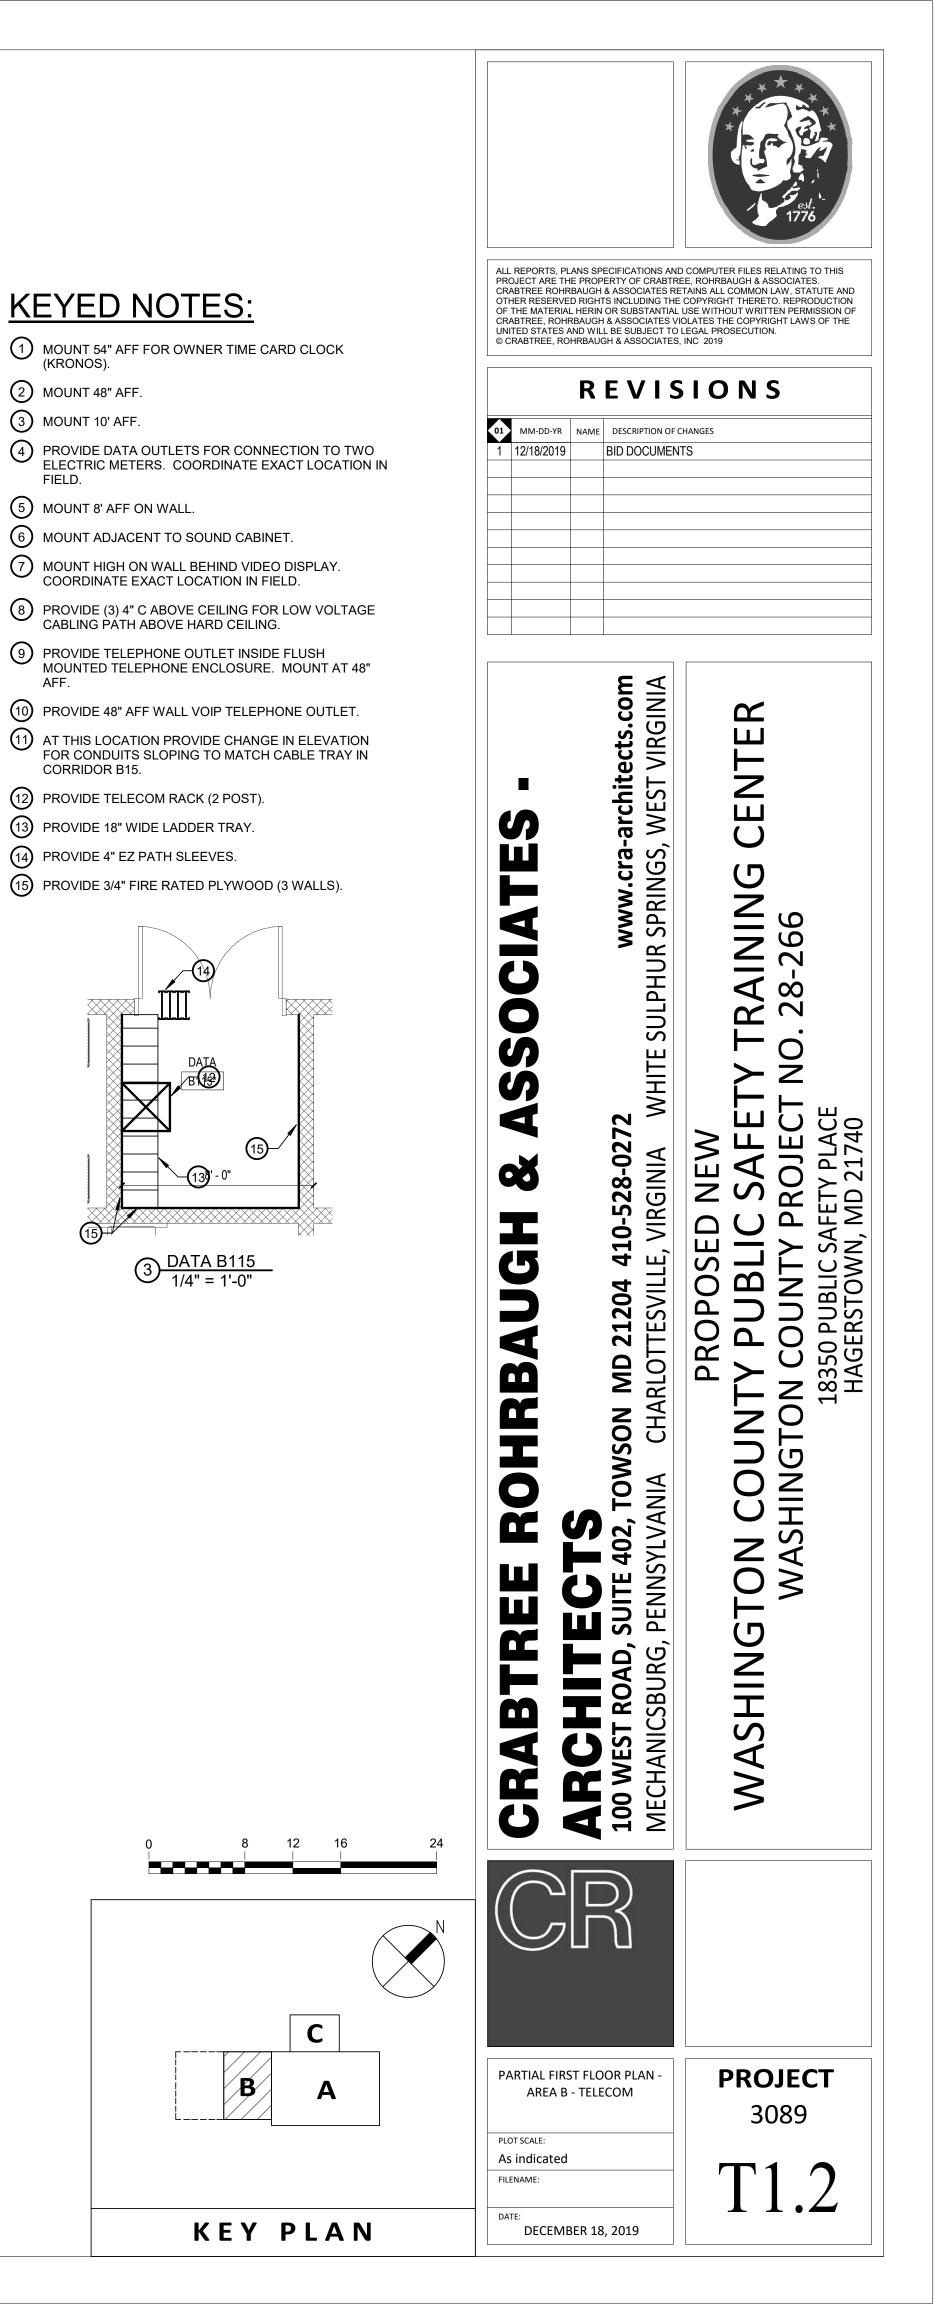

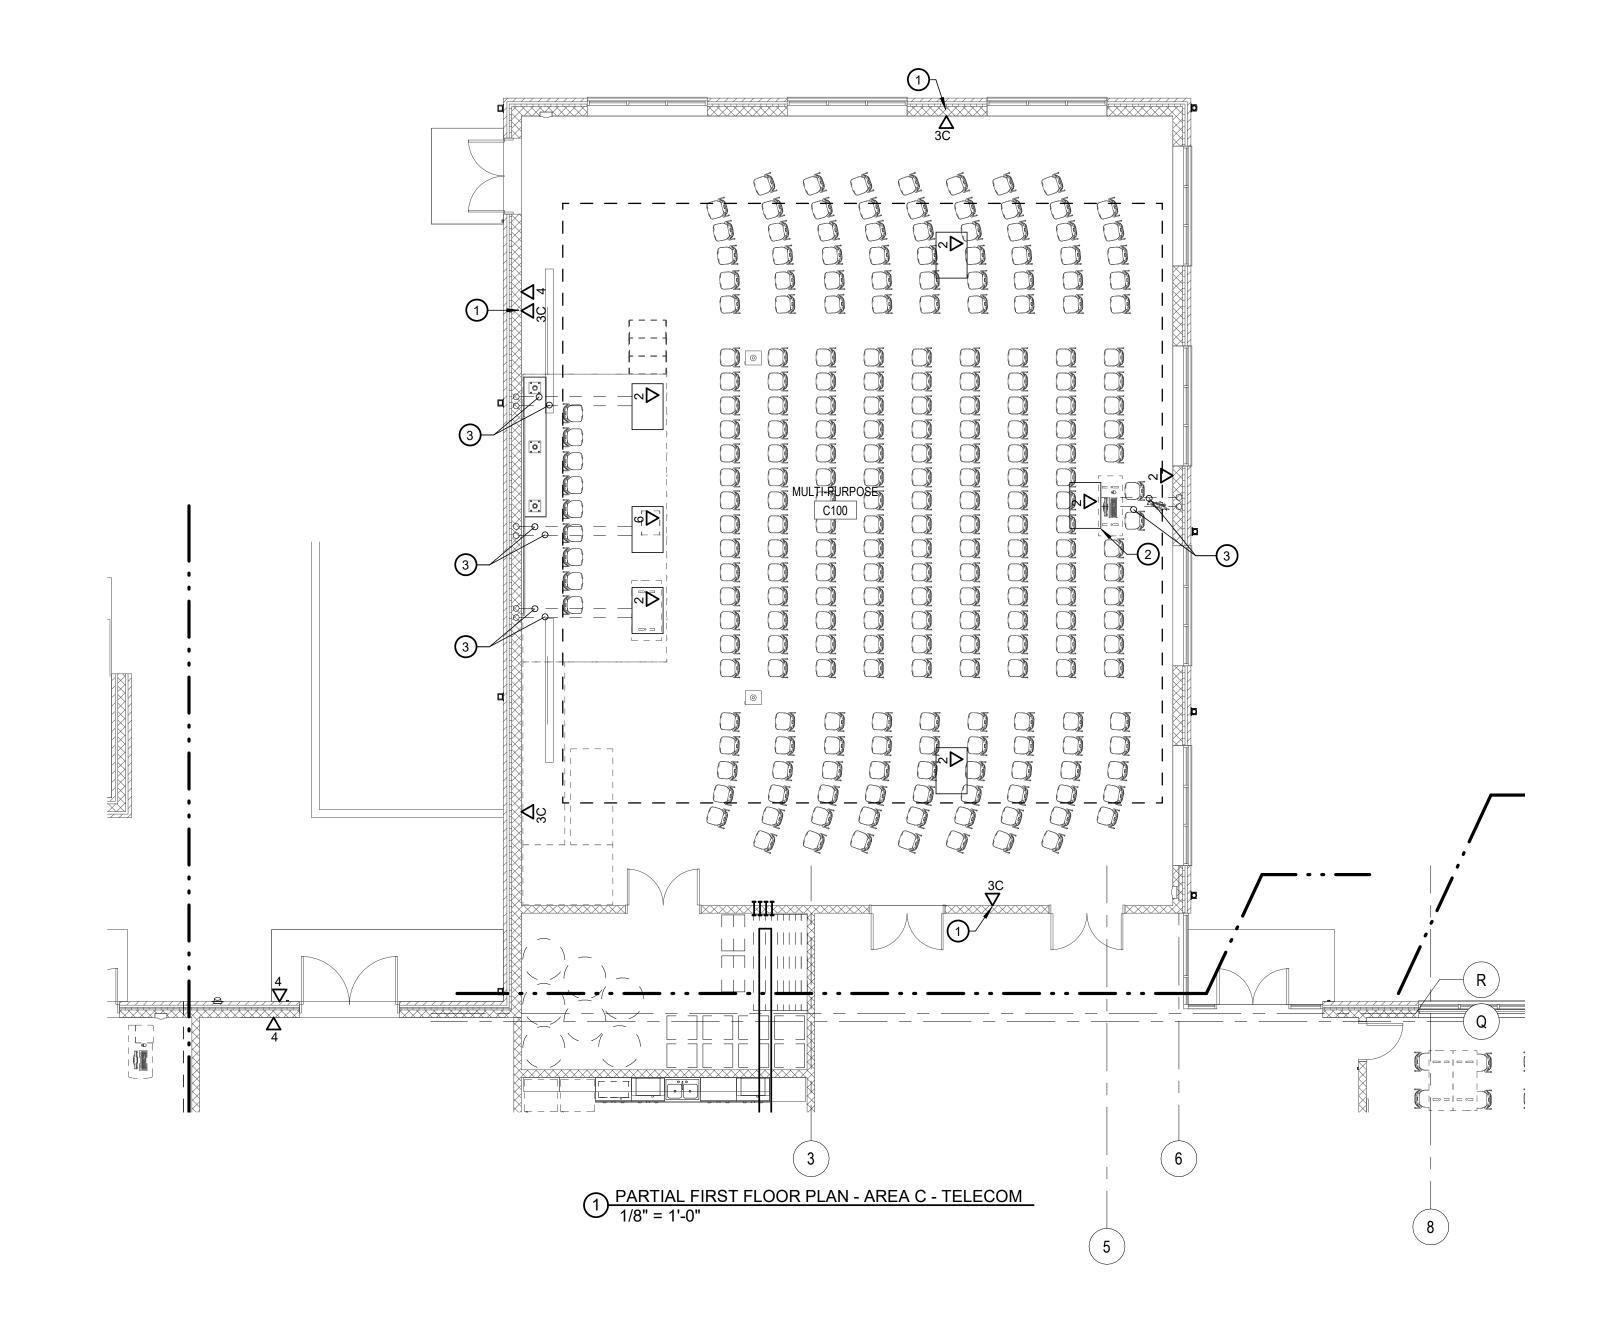

GENERAL NOTES:


WHERE CABLING CANNONT BE CONCEALED FROM VIEW, PROVIDE PAINTED CONDUITS FOR CABLING RUNNING IN EXPOSED CEILING AREAS INCLUDING MULTIPURPOSE ROOM C100. DRA (1) MOI (2) MOI SLA (3) PRO ACC

DRAWING NOTES:


1 MOUNT 10'-0" AFF.


2 MOUNT IN FLUSH FLOOR BOX IN CONCRETE FLOOR SLAB.


PROVIDE (2) 1 1/4" C FOR TELECOM CABLES FROM ACCESSIBLE CEILING SPACE TO FLOOR BOX.

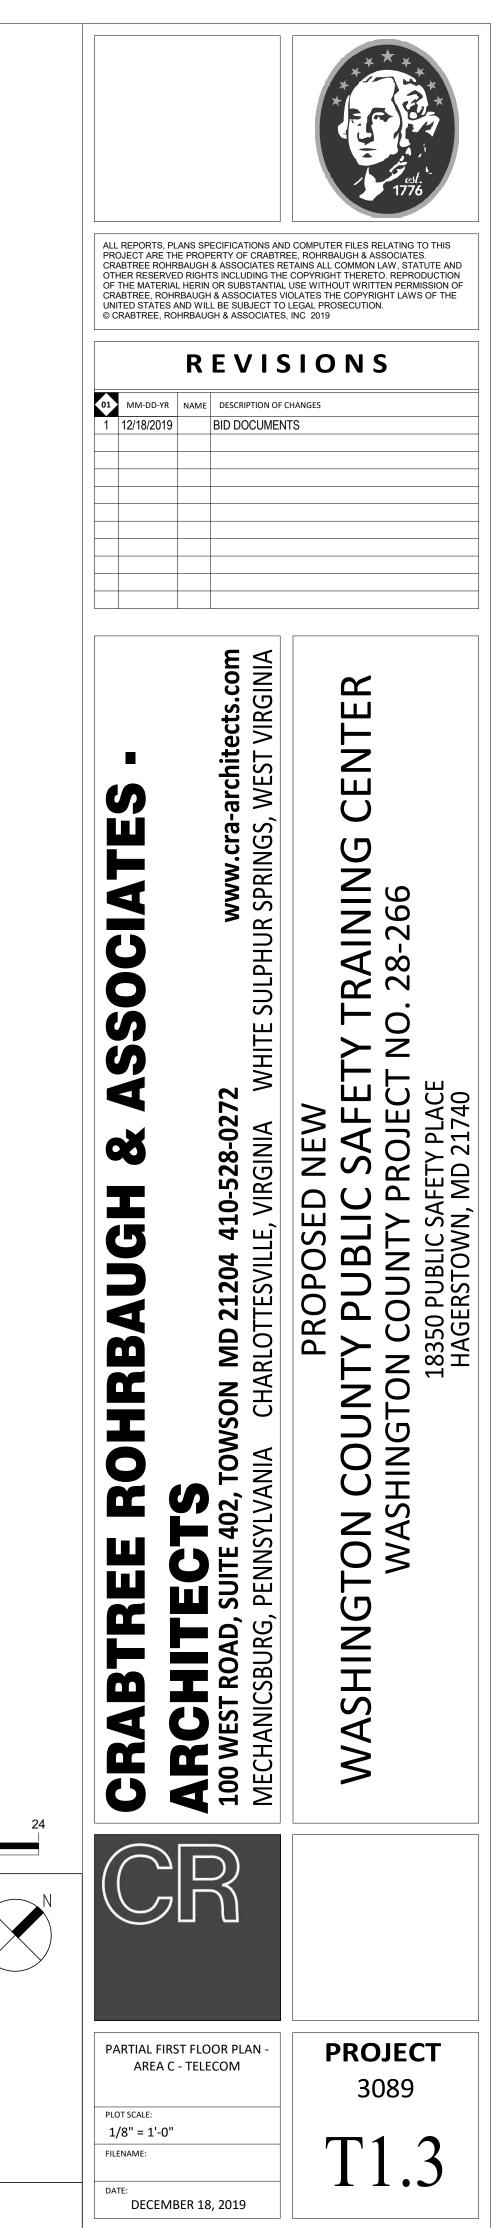


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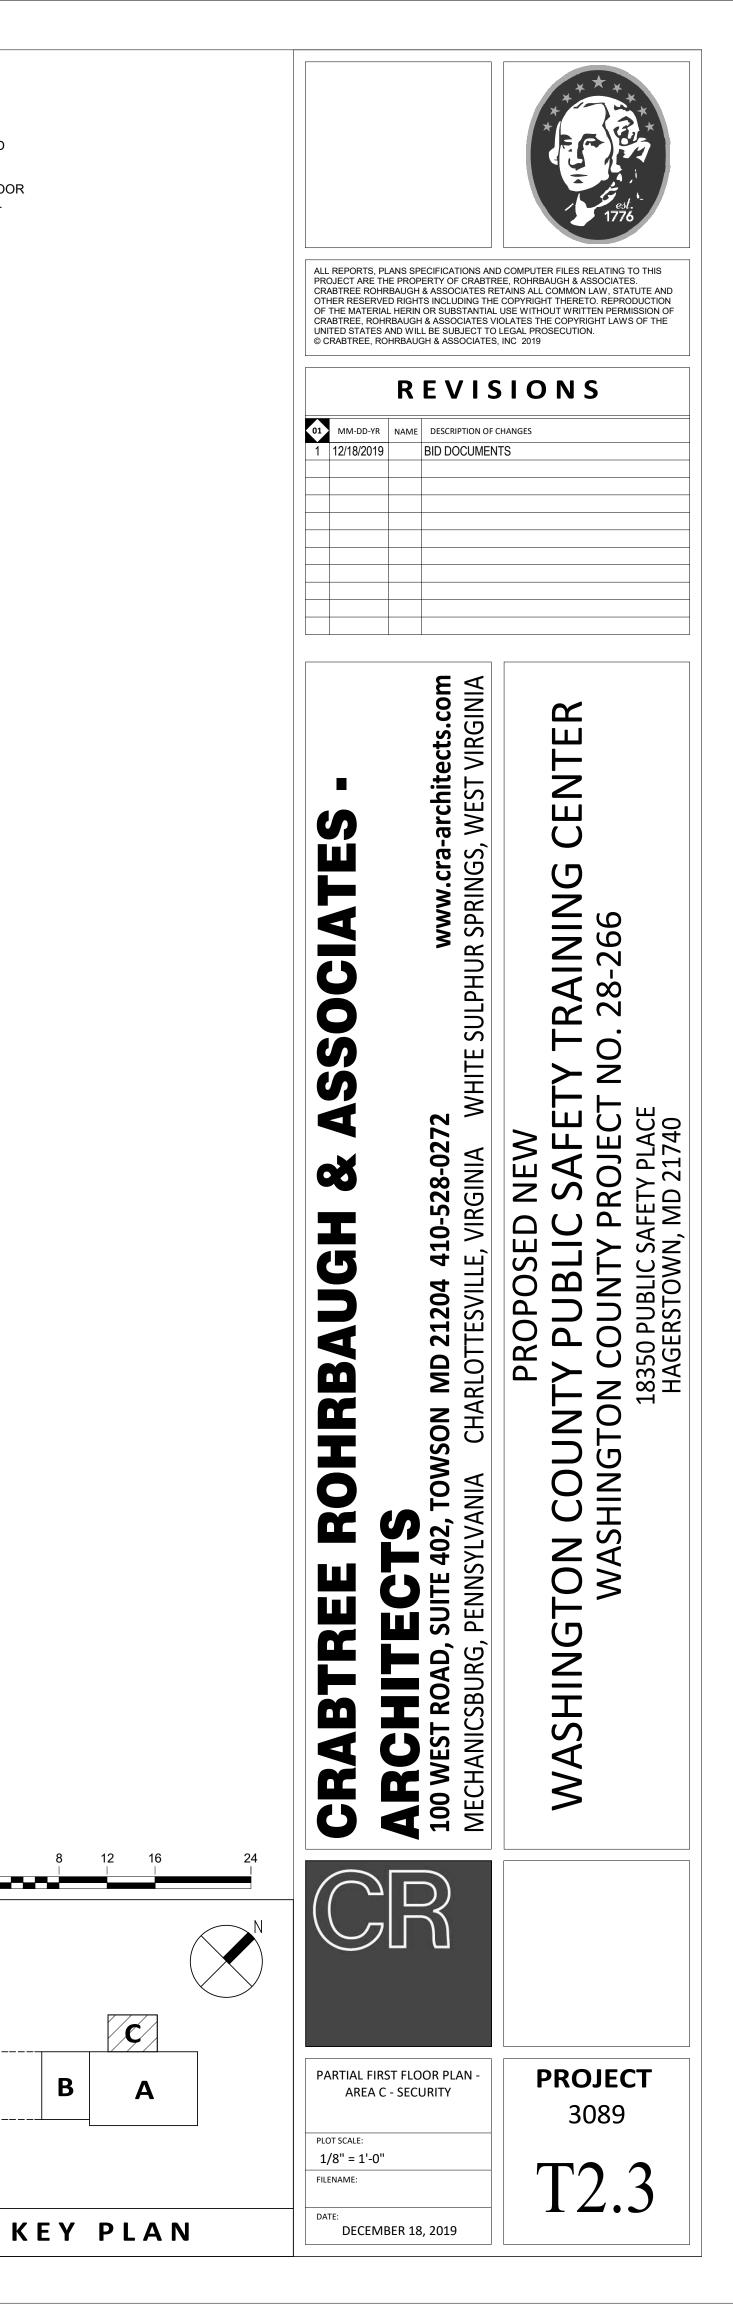
GENERAL NOTES:

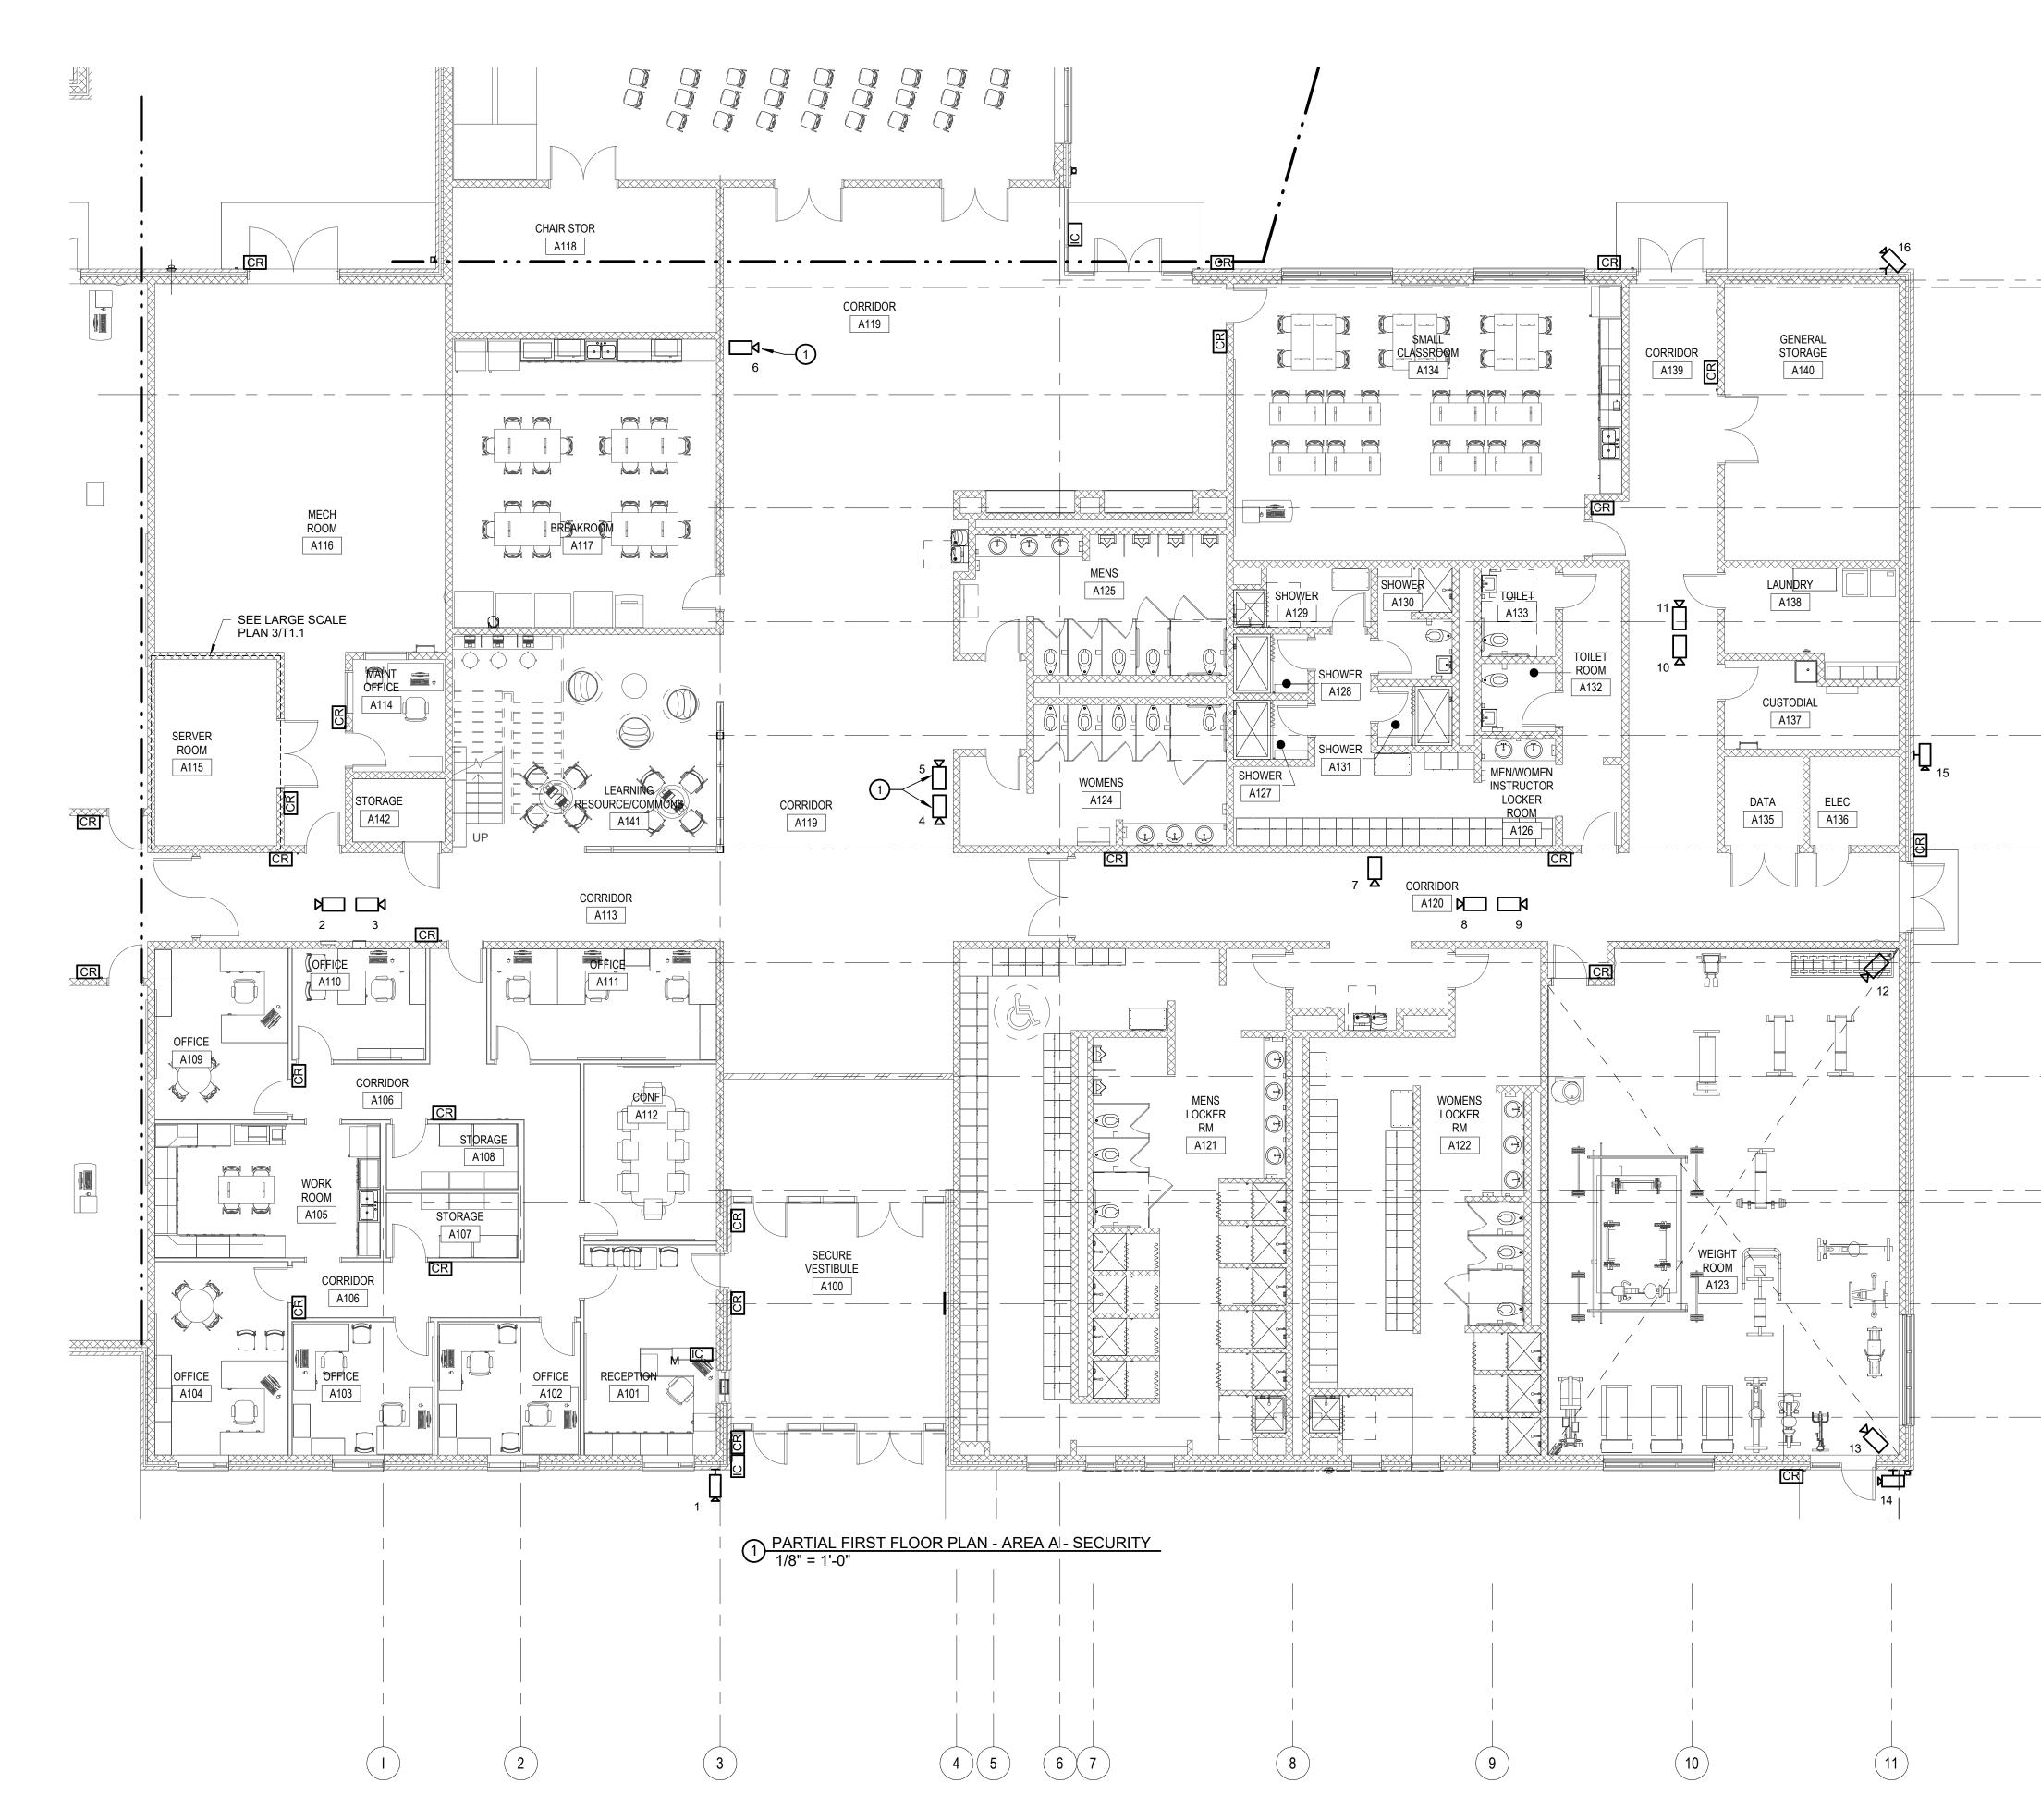WHERE CABLING CANNONT BE CONCEALED FROM VIEW, PROVIDE PAINTED CONDUITS FOR CABLING RUNNING IN EXPOSED CEILING AREAS INCLUDING MULTIPURPOSE ROOM C100.

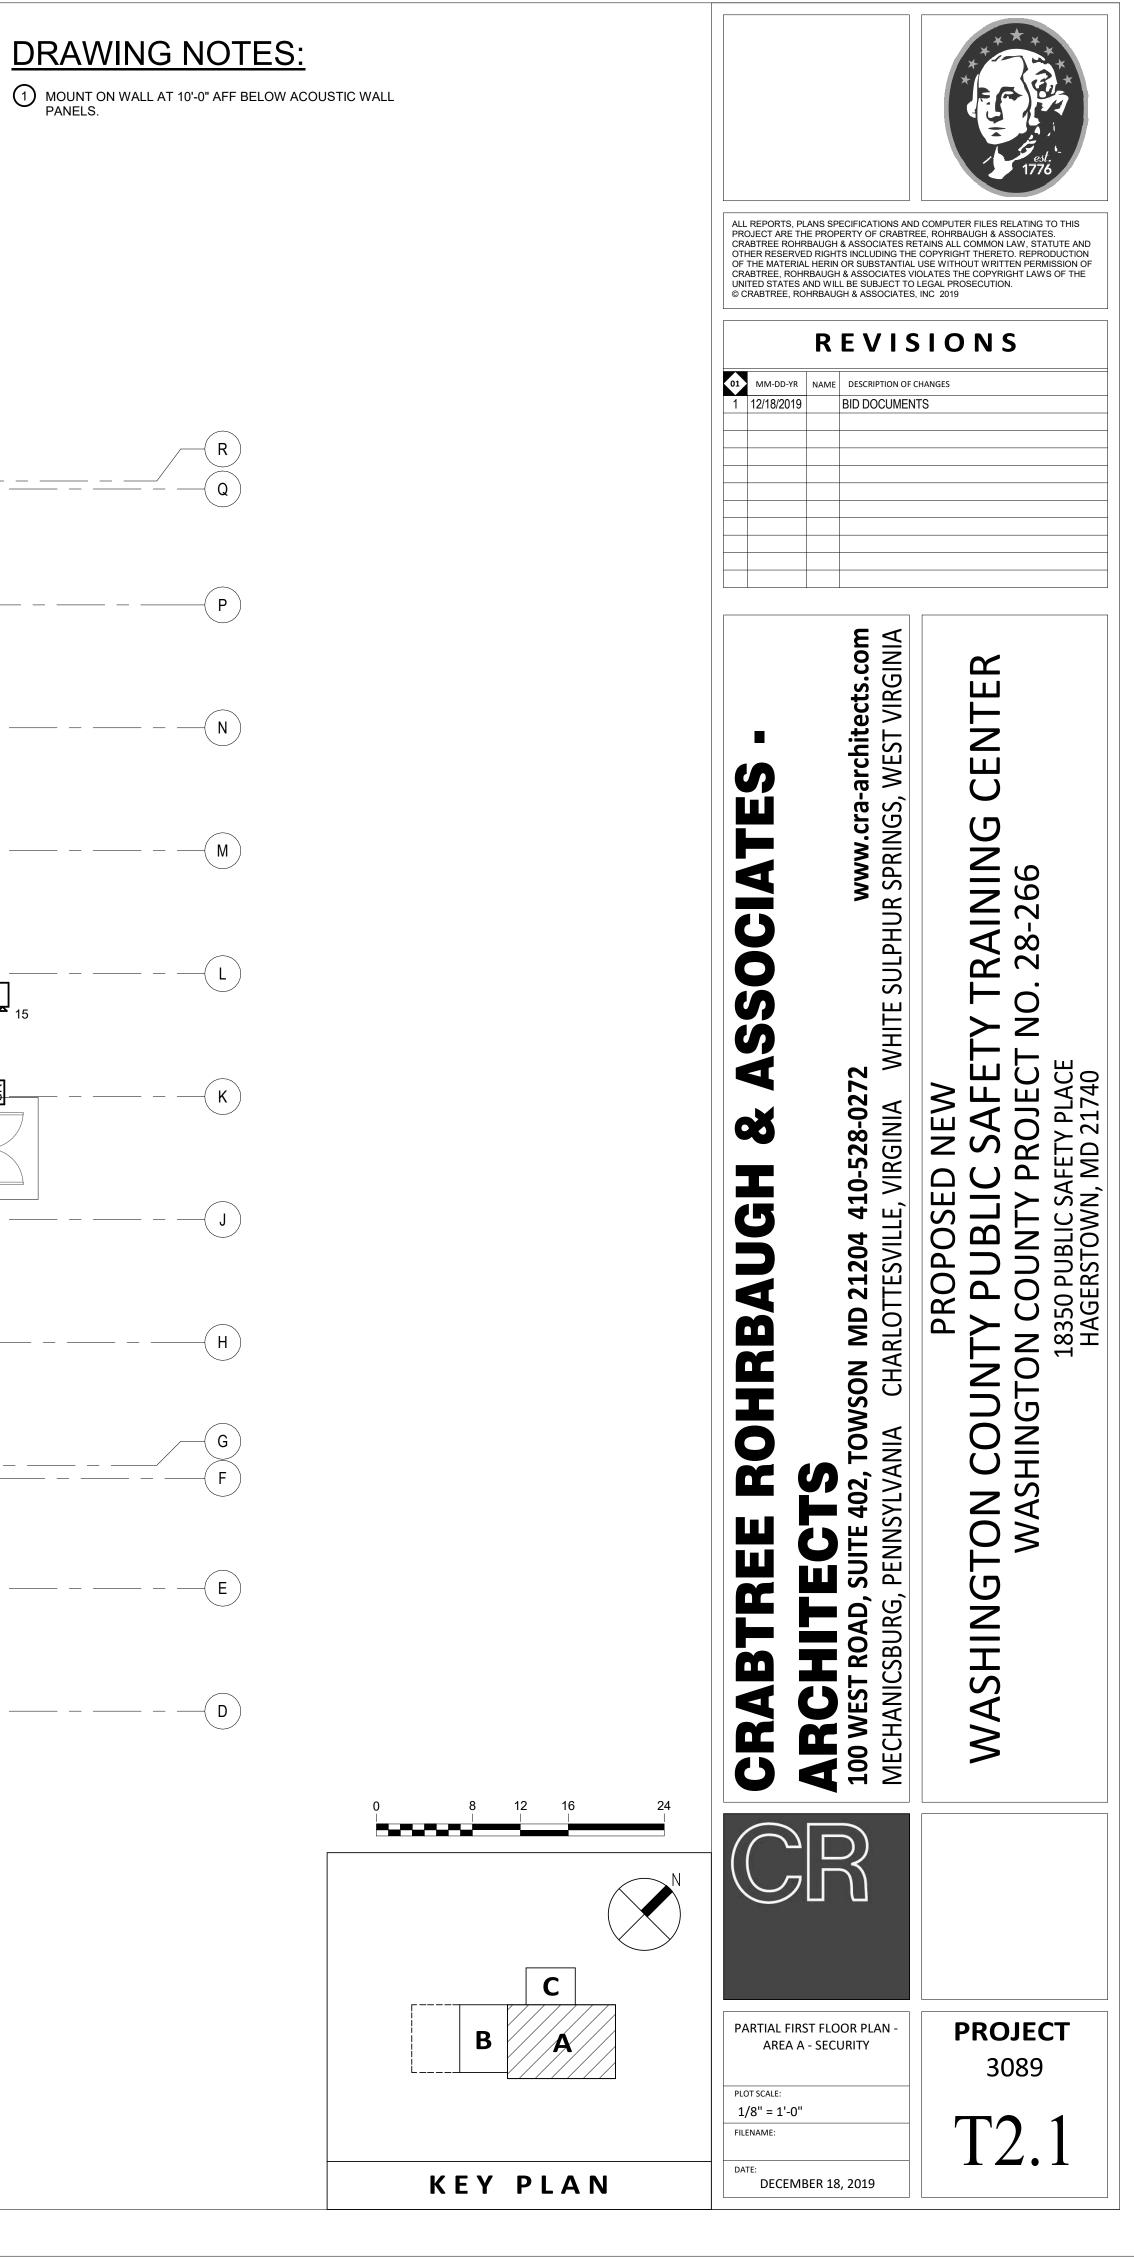KEYED NOTES:

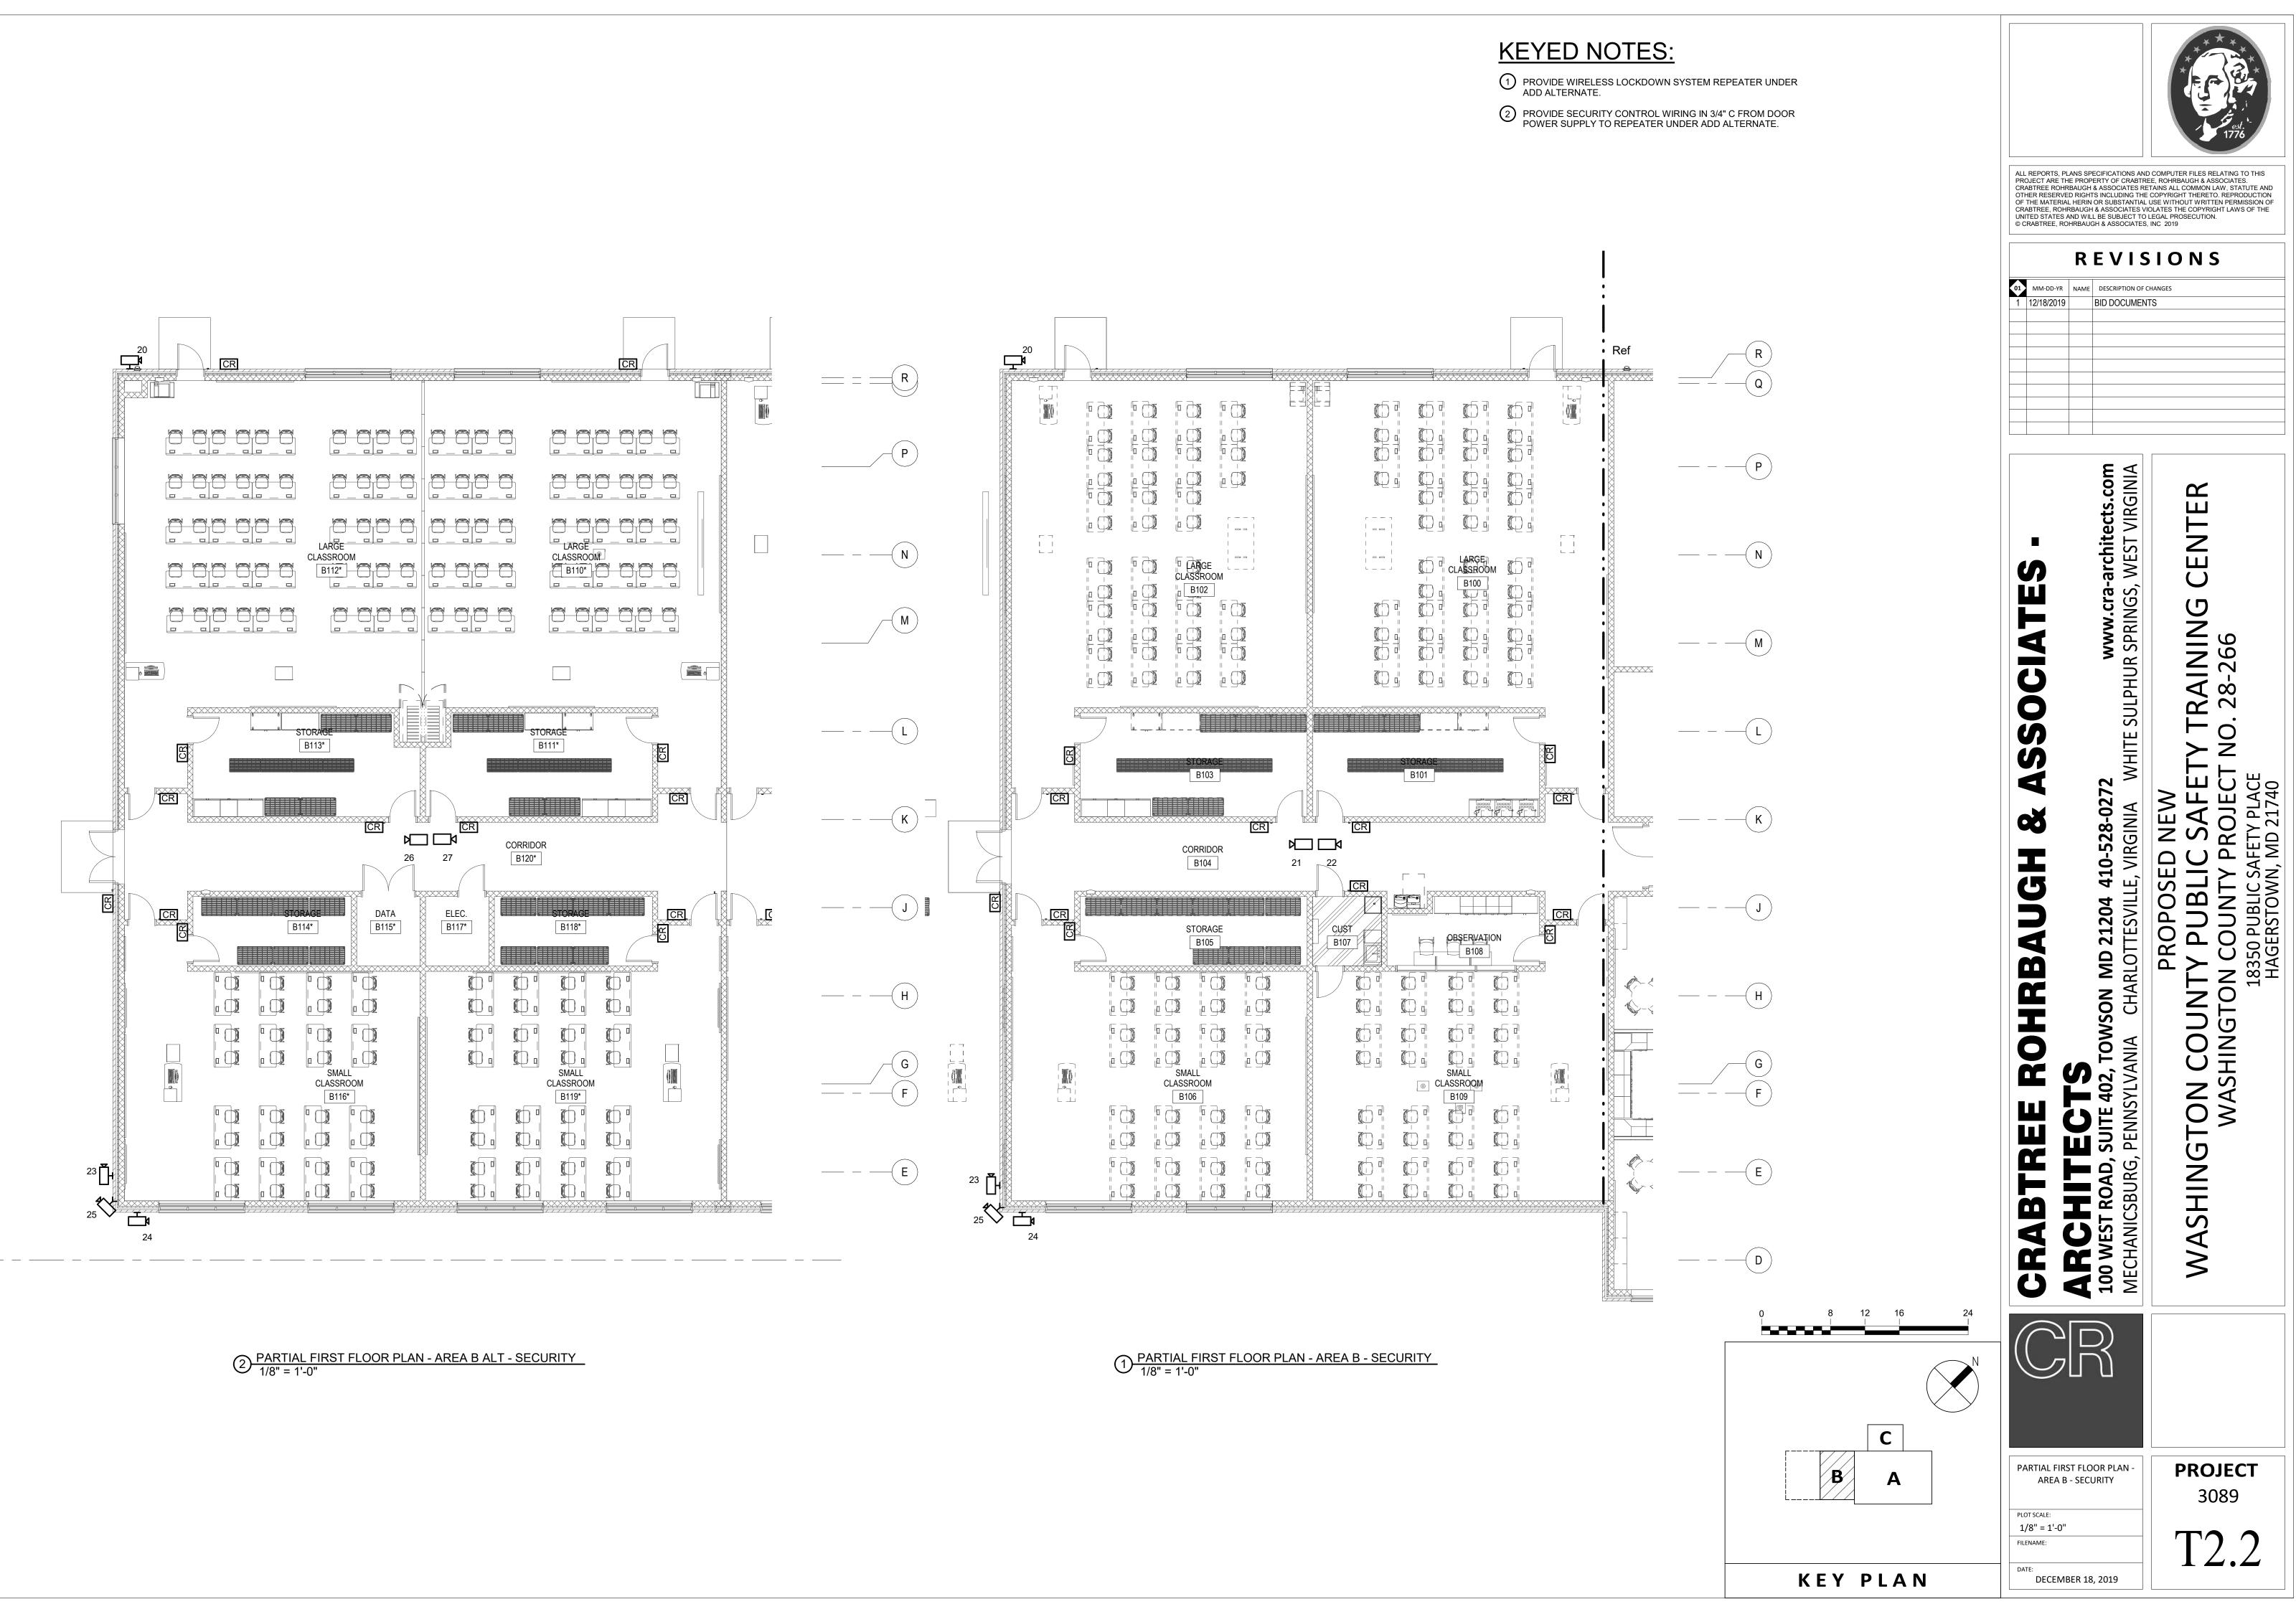1 PROVIDE WIRELESS LOCKDOWN SYSTEM GATEWAY AND REPEATER UNDER ADD ALTERNATE.

2 PROVIDE SECURITY CONTROL WIRING IN 3/4" C FROM DOOR POWER SUPPLY TO REPEATER UNDER ADD ALTERNATE.

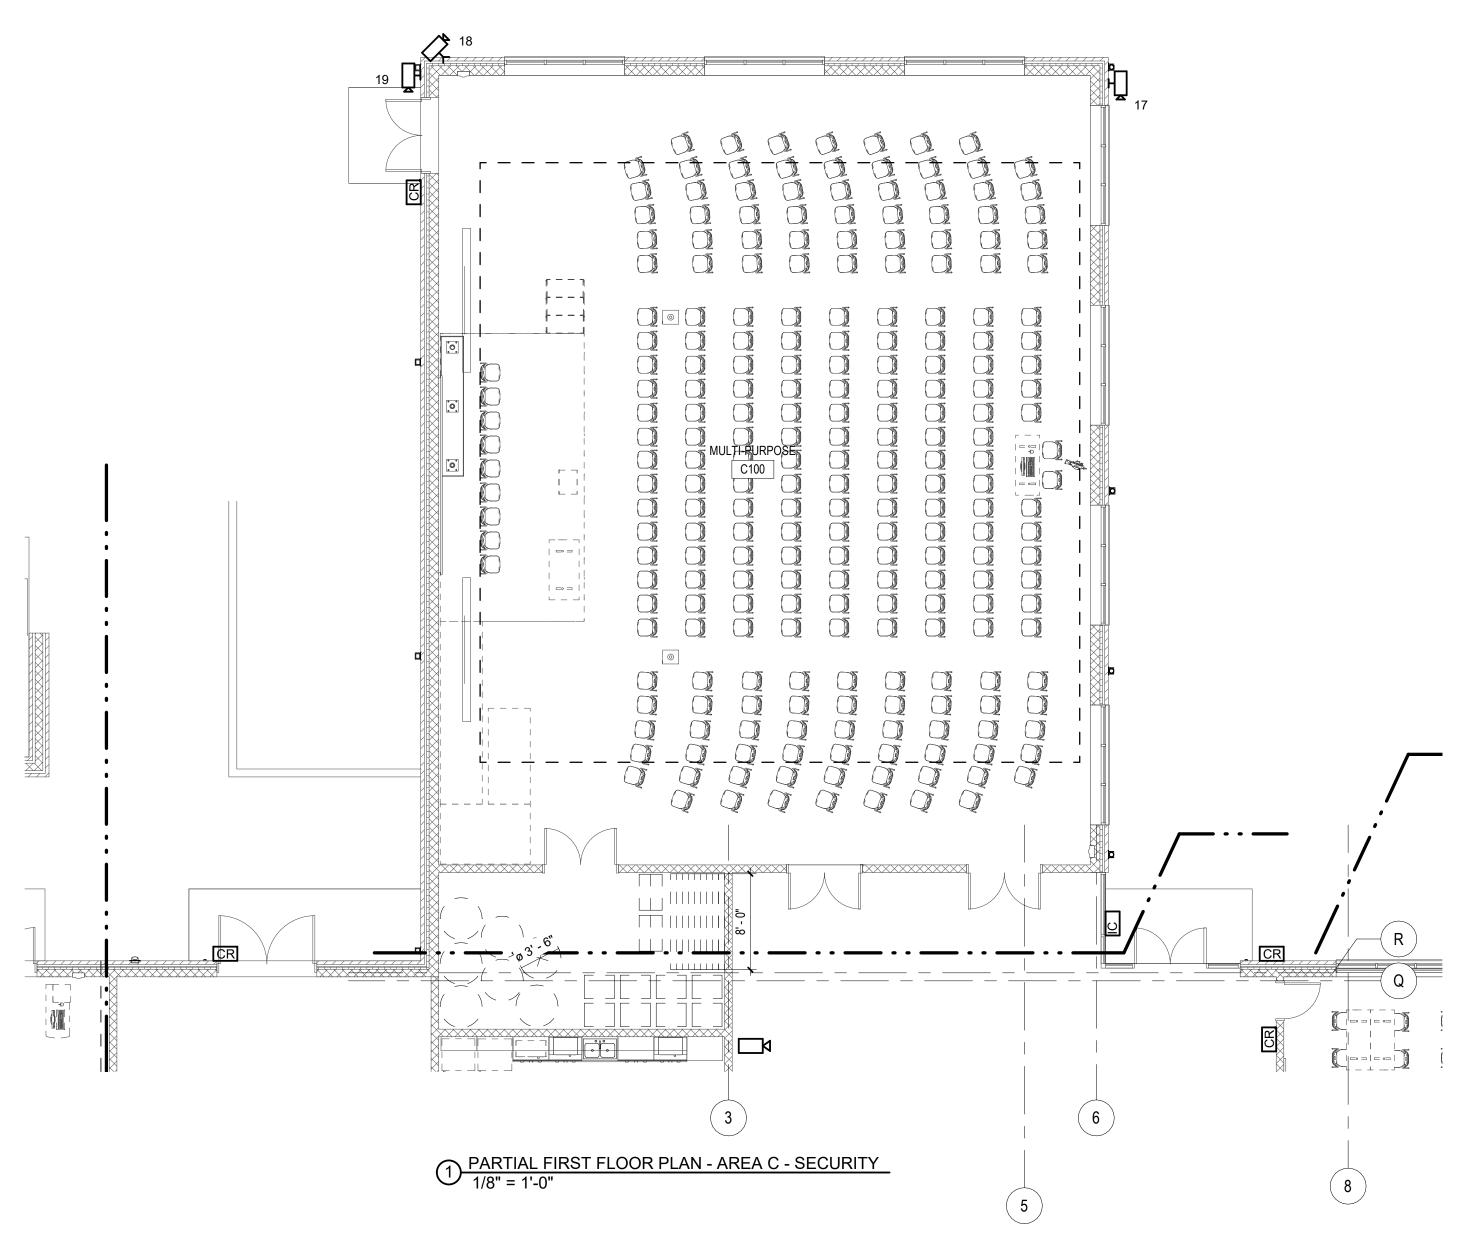


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Α

В



REF.	CABLE	DESCRIPTION	CONDUCTORS	SHIELDING
A	*25293B	1 TWISTED, SHIELDED PAIR.	#18 AWG STRANDED	FOIL W/BARE DRAIN WIRE.
В	*25359B	1 TWISTED SHIELDED PAIR + 1 TWISTED PAIR.	#20 AWG STRANDED	FOIL W/BARE DRAIN WIRE.
С	*25510	2 PAIR INDIVIDUALLY SHIELDED.	#22 AWG STRANDED TINNED.	COMMON DRAIN WIRE
D	*25225	2 TWISTED CONDUCTORS	#16 AWG	NONE
F	*D253652	3 TWISTED SHIELDED PAIR	#22 AWG	OVERWALL
G		CLOCK CIRCUIT	#14 AWG	NONE
I	*25302	(2) 3 CONDUCTORS	#20 AWG	OVERALL
М	*25292B	1 TWISTED, SHIELDED PAIR.	#20 AWG STRANDED	FOIL W/BARE DRAIN WIRE.
S	*25226B	1 TWISTED PAIR	#14 AWG STRANDED	NONE
т	*25294B	1 TWISTED, SHIELDED PAIR.	#16 AWG	FOIL W/BARE DRAIN WIRE.

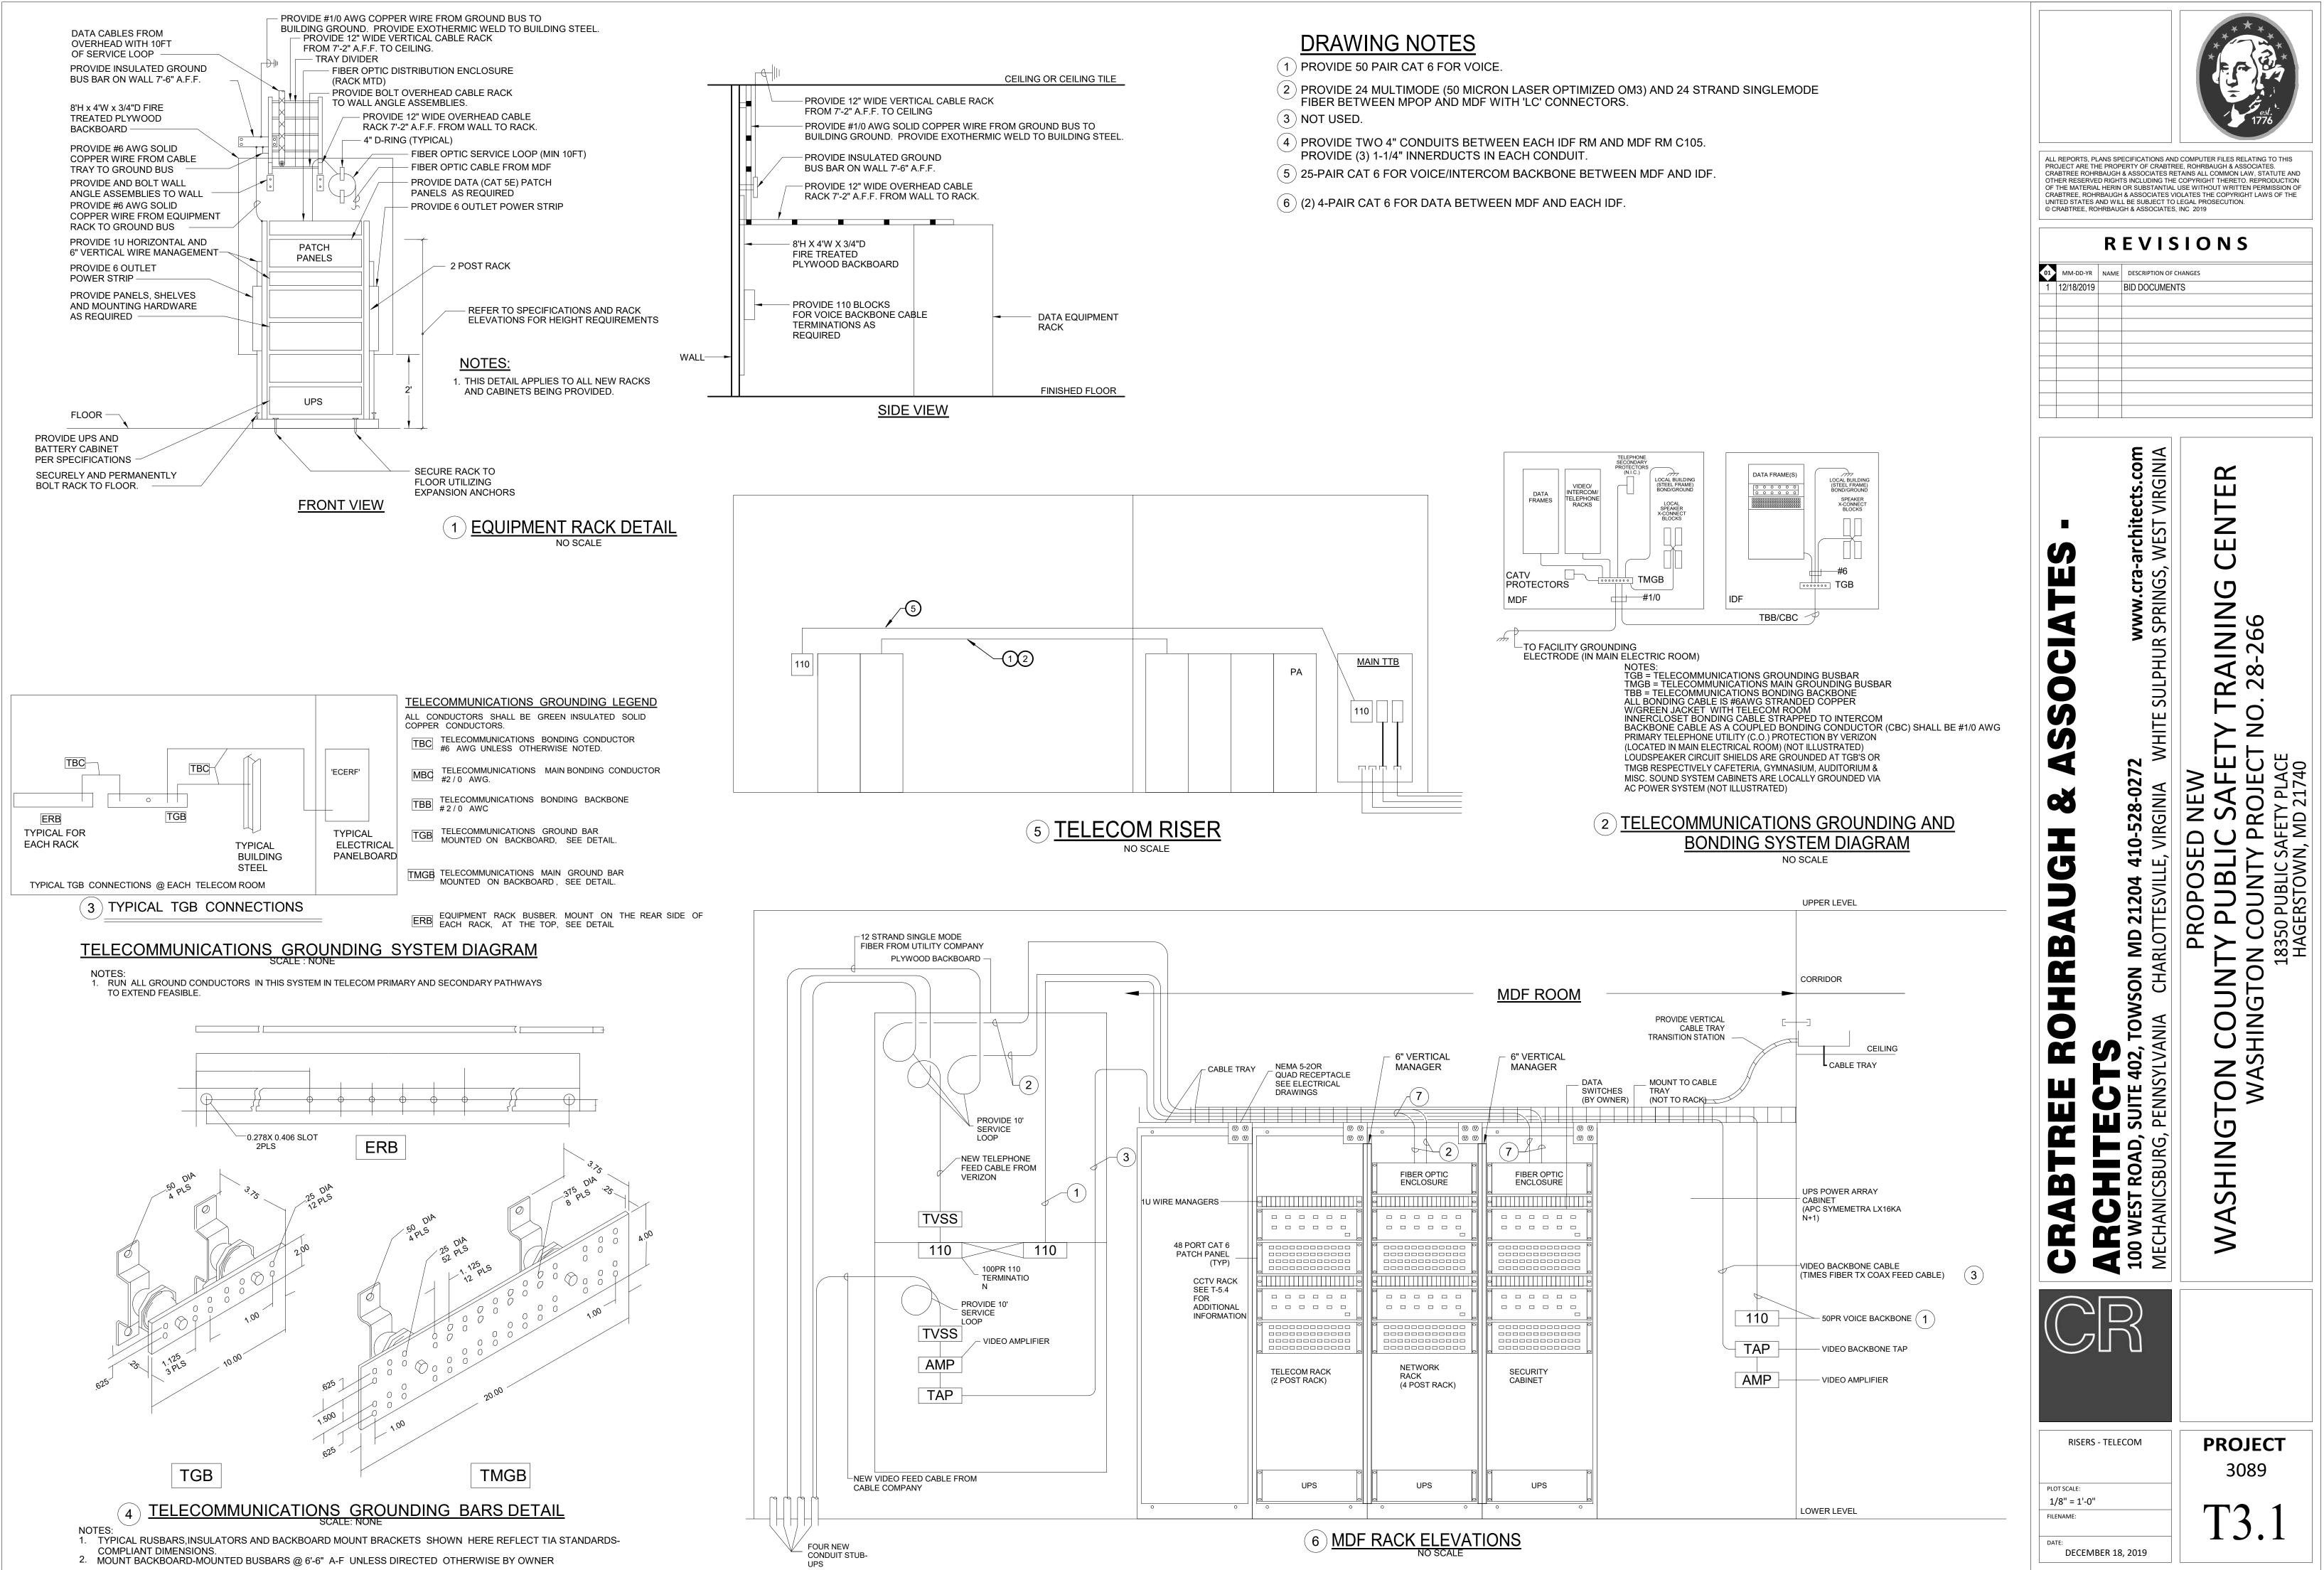
NOTES:


1. USE ONLY THE CABLE LISTED OR EQUAL, APPROVED BY EQUAL


2. * - WEST PENN CABLE


3. DO NOT RUN MICROPHONE AND SPEAKER CABLES IN THE SAME CONDUIT.




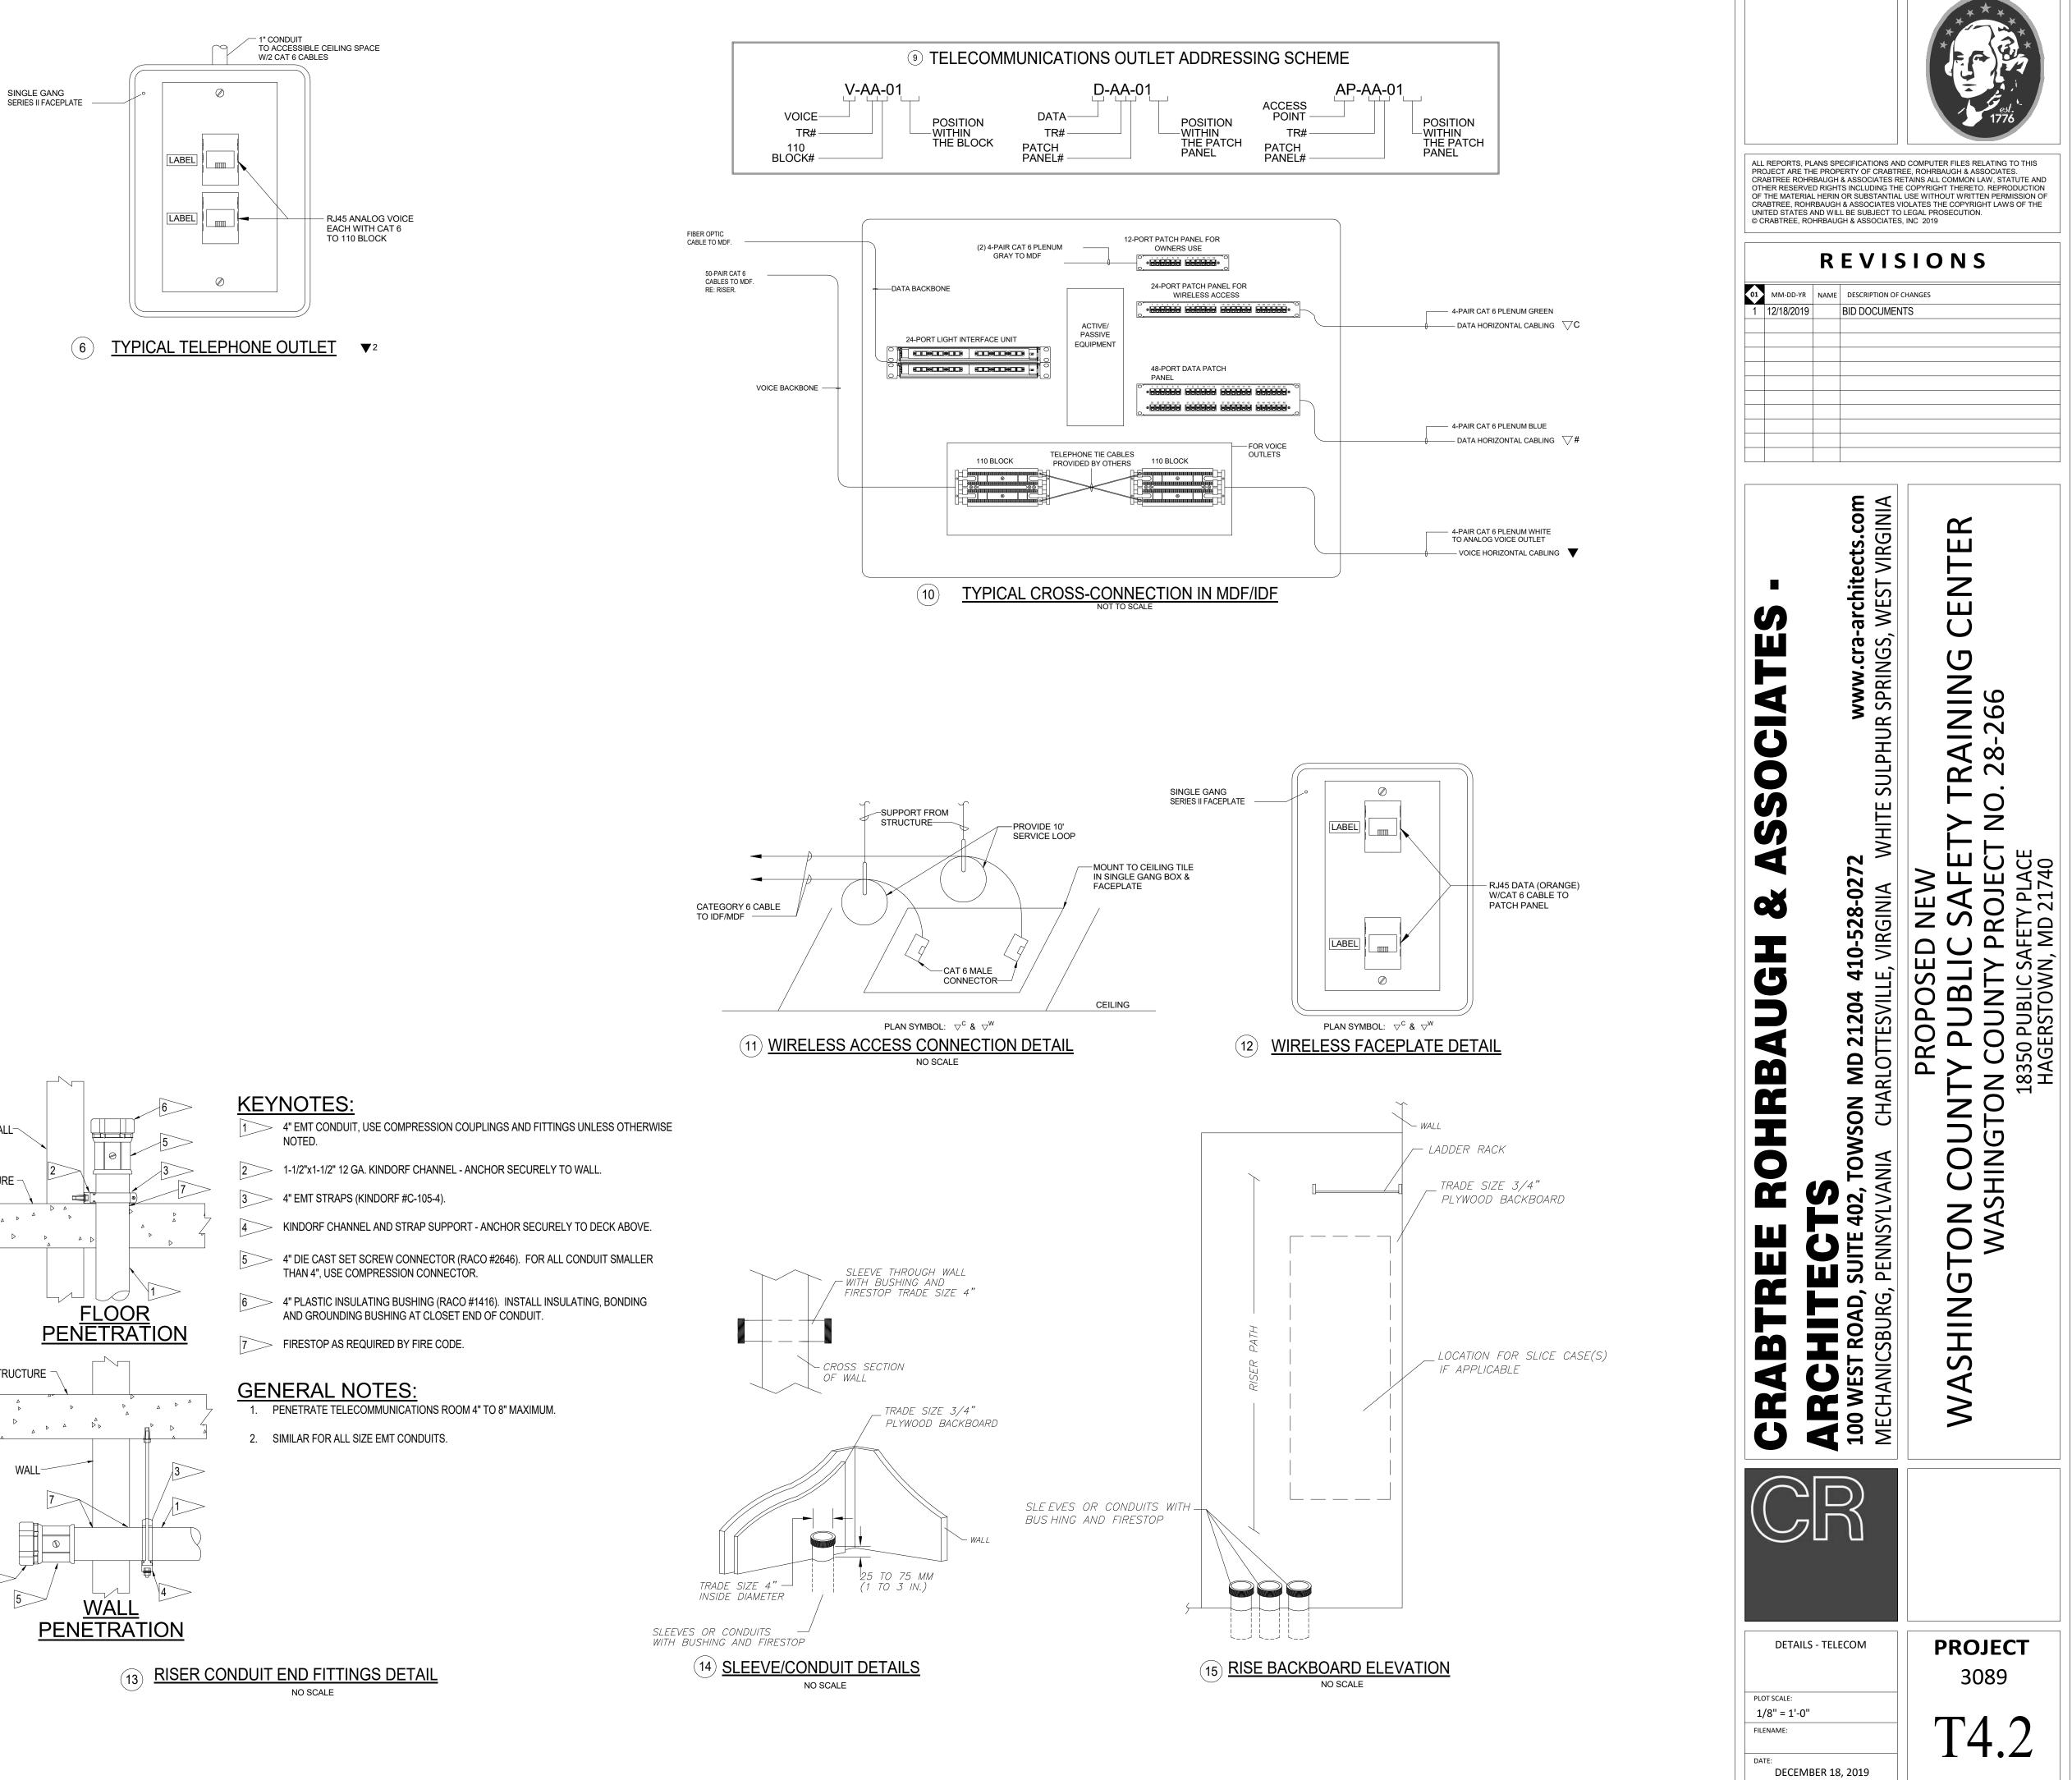


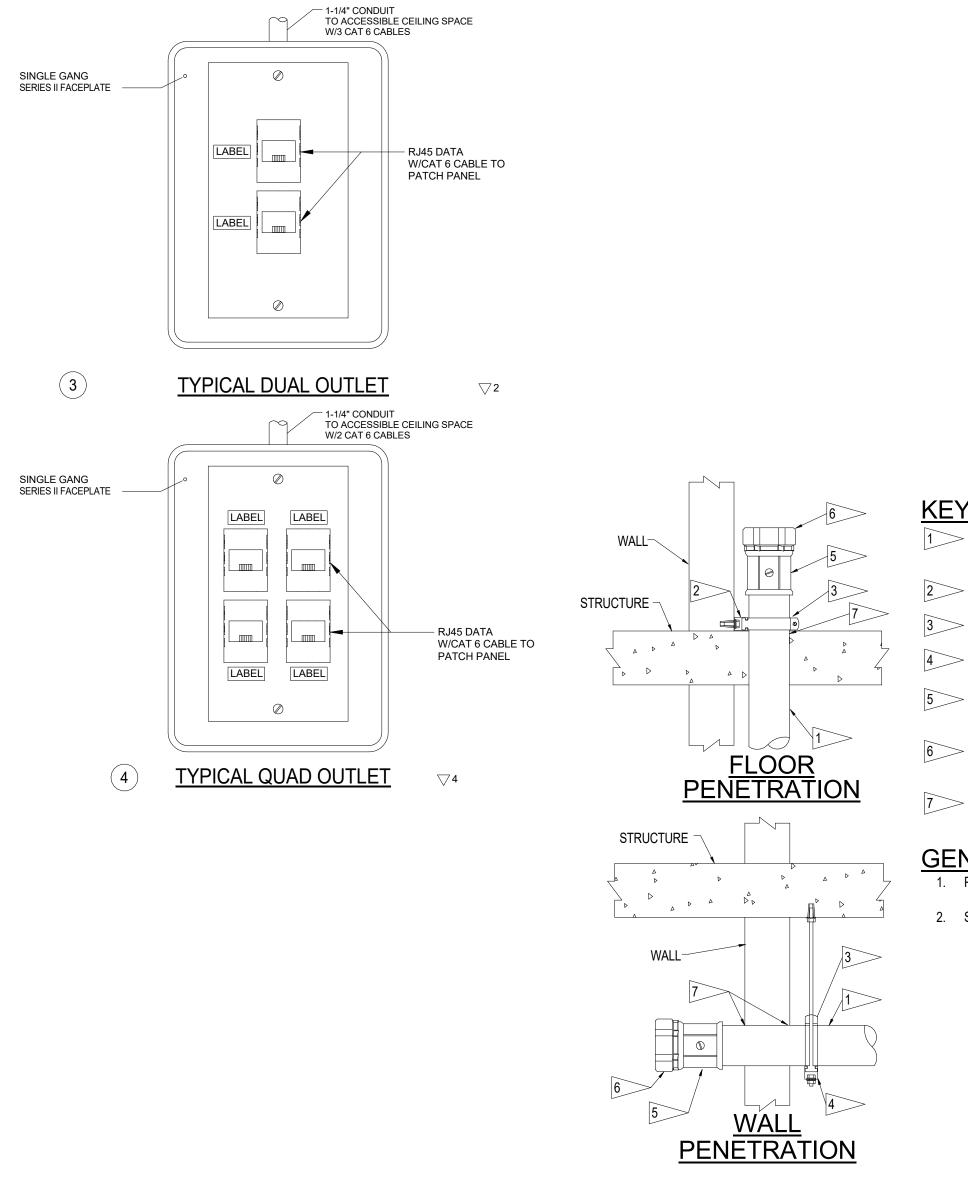

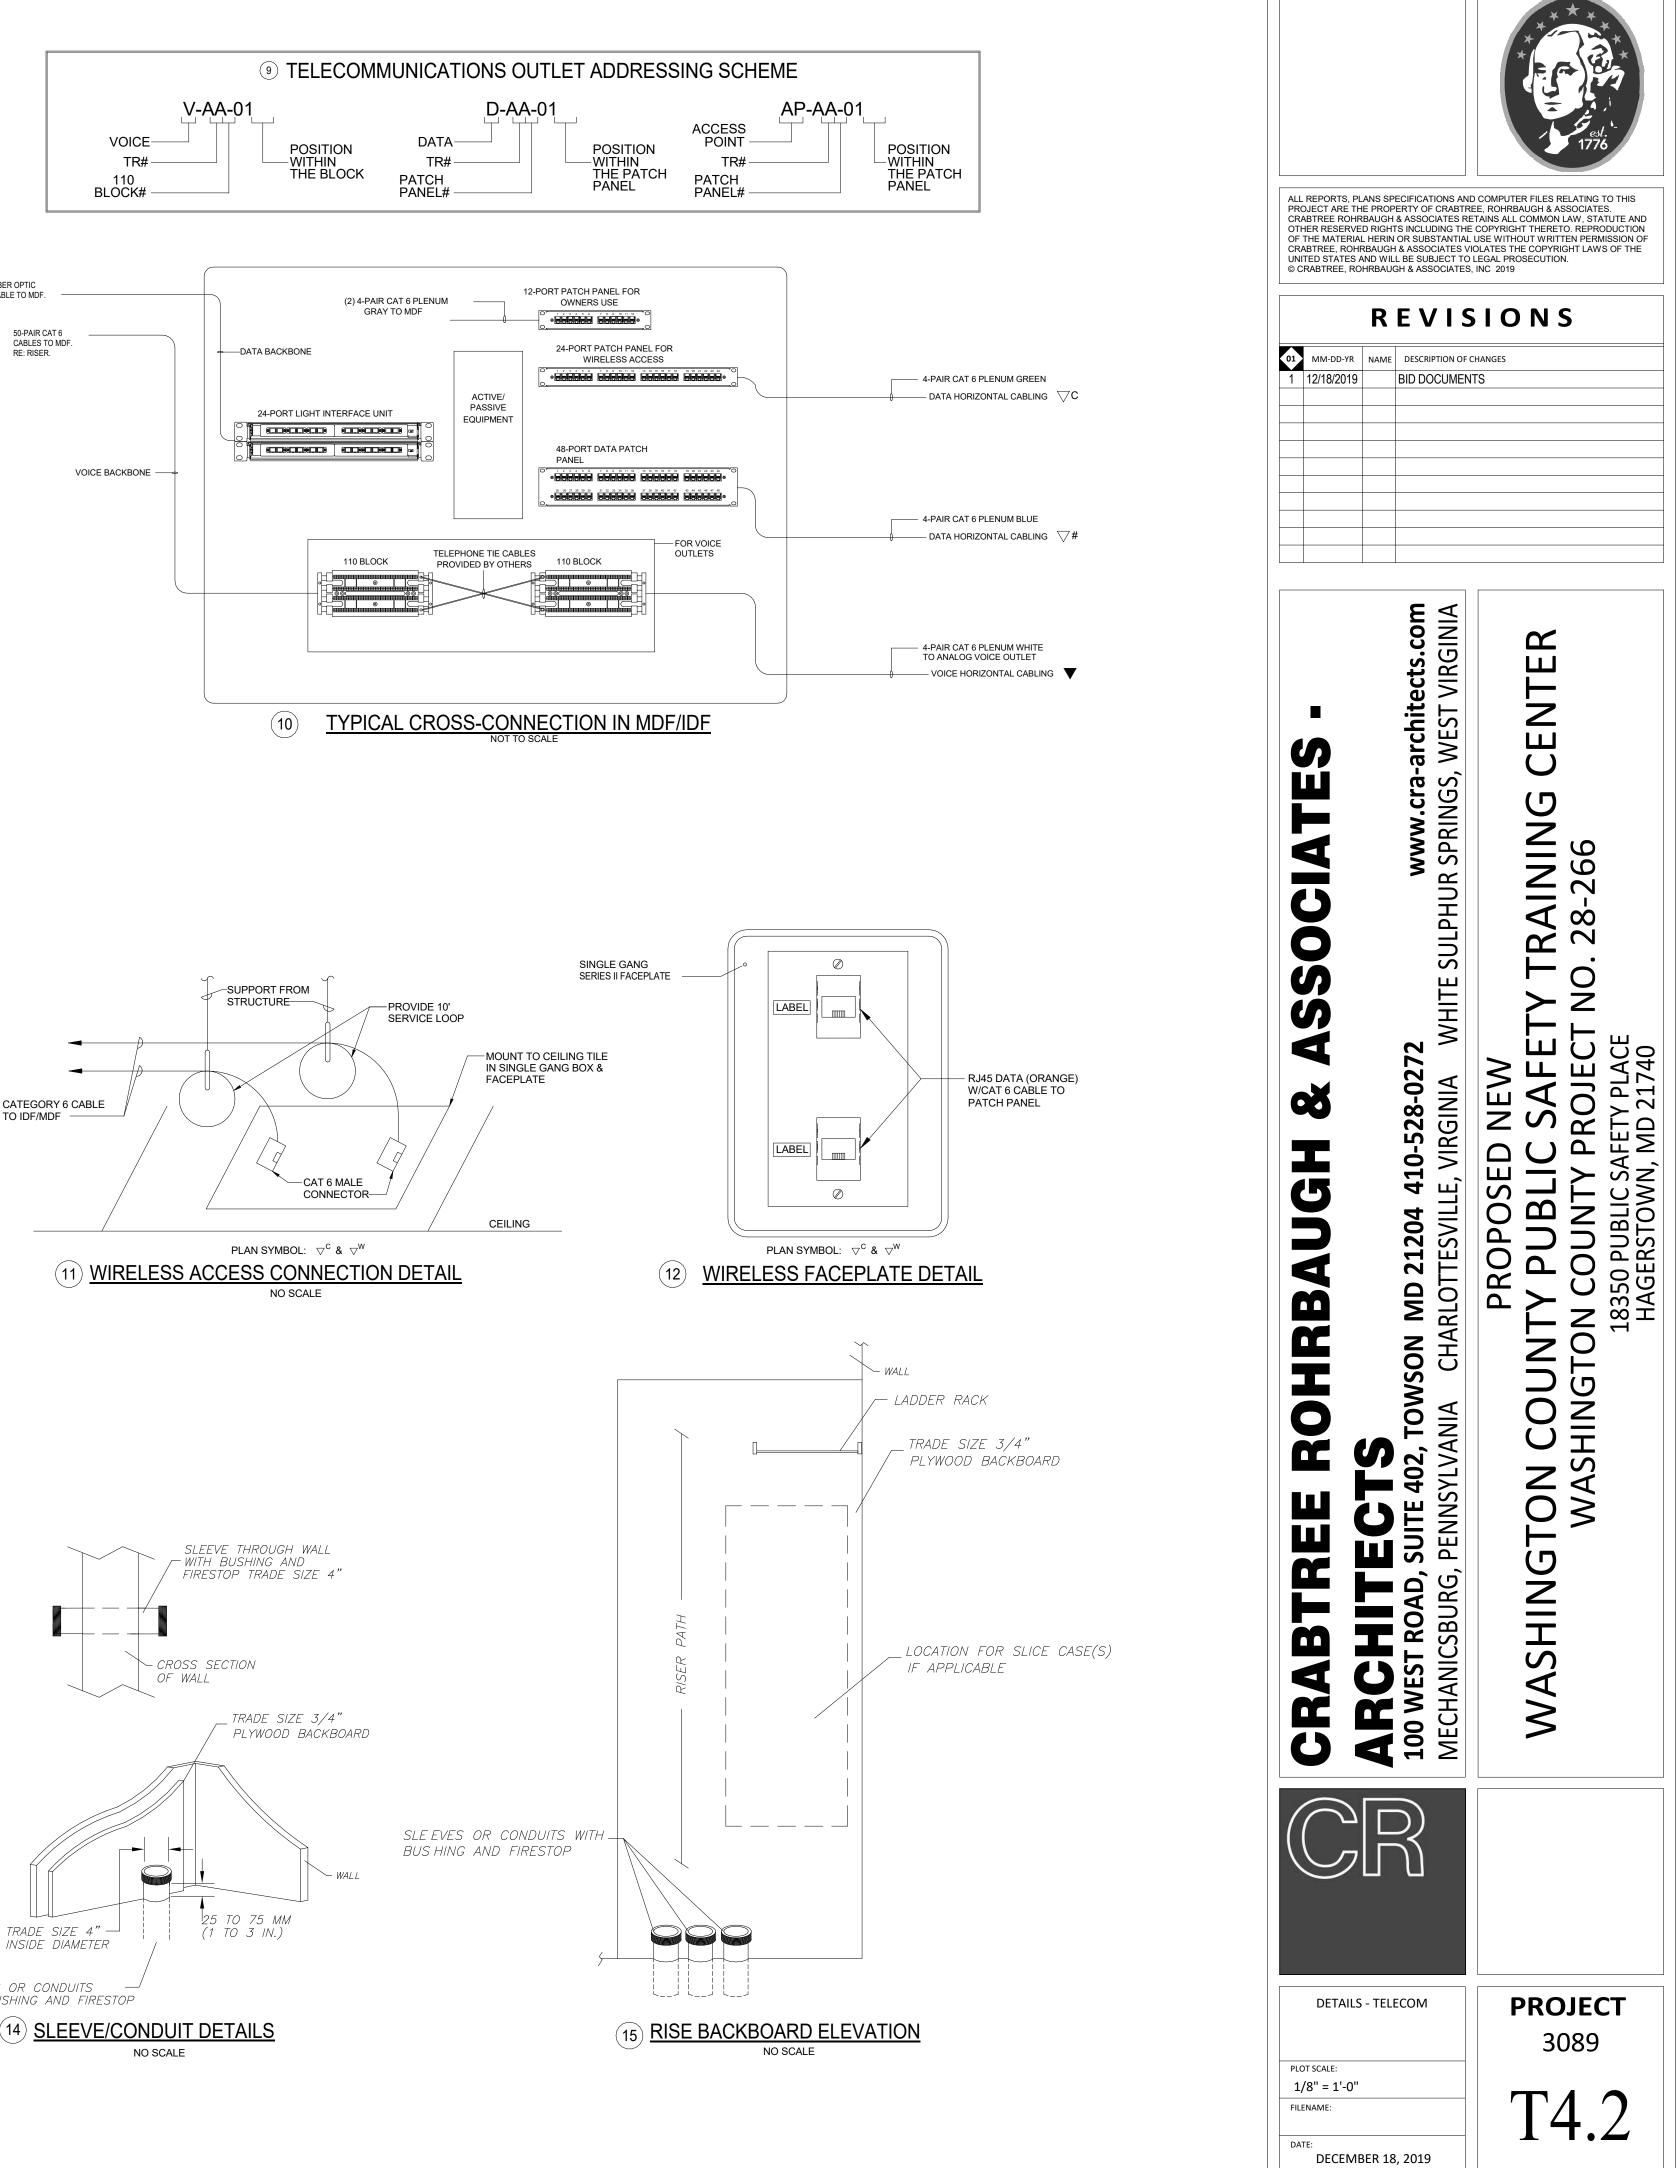

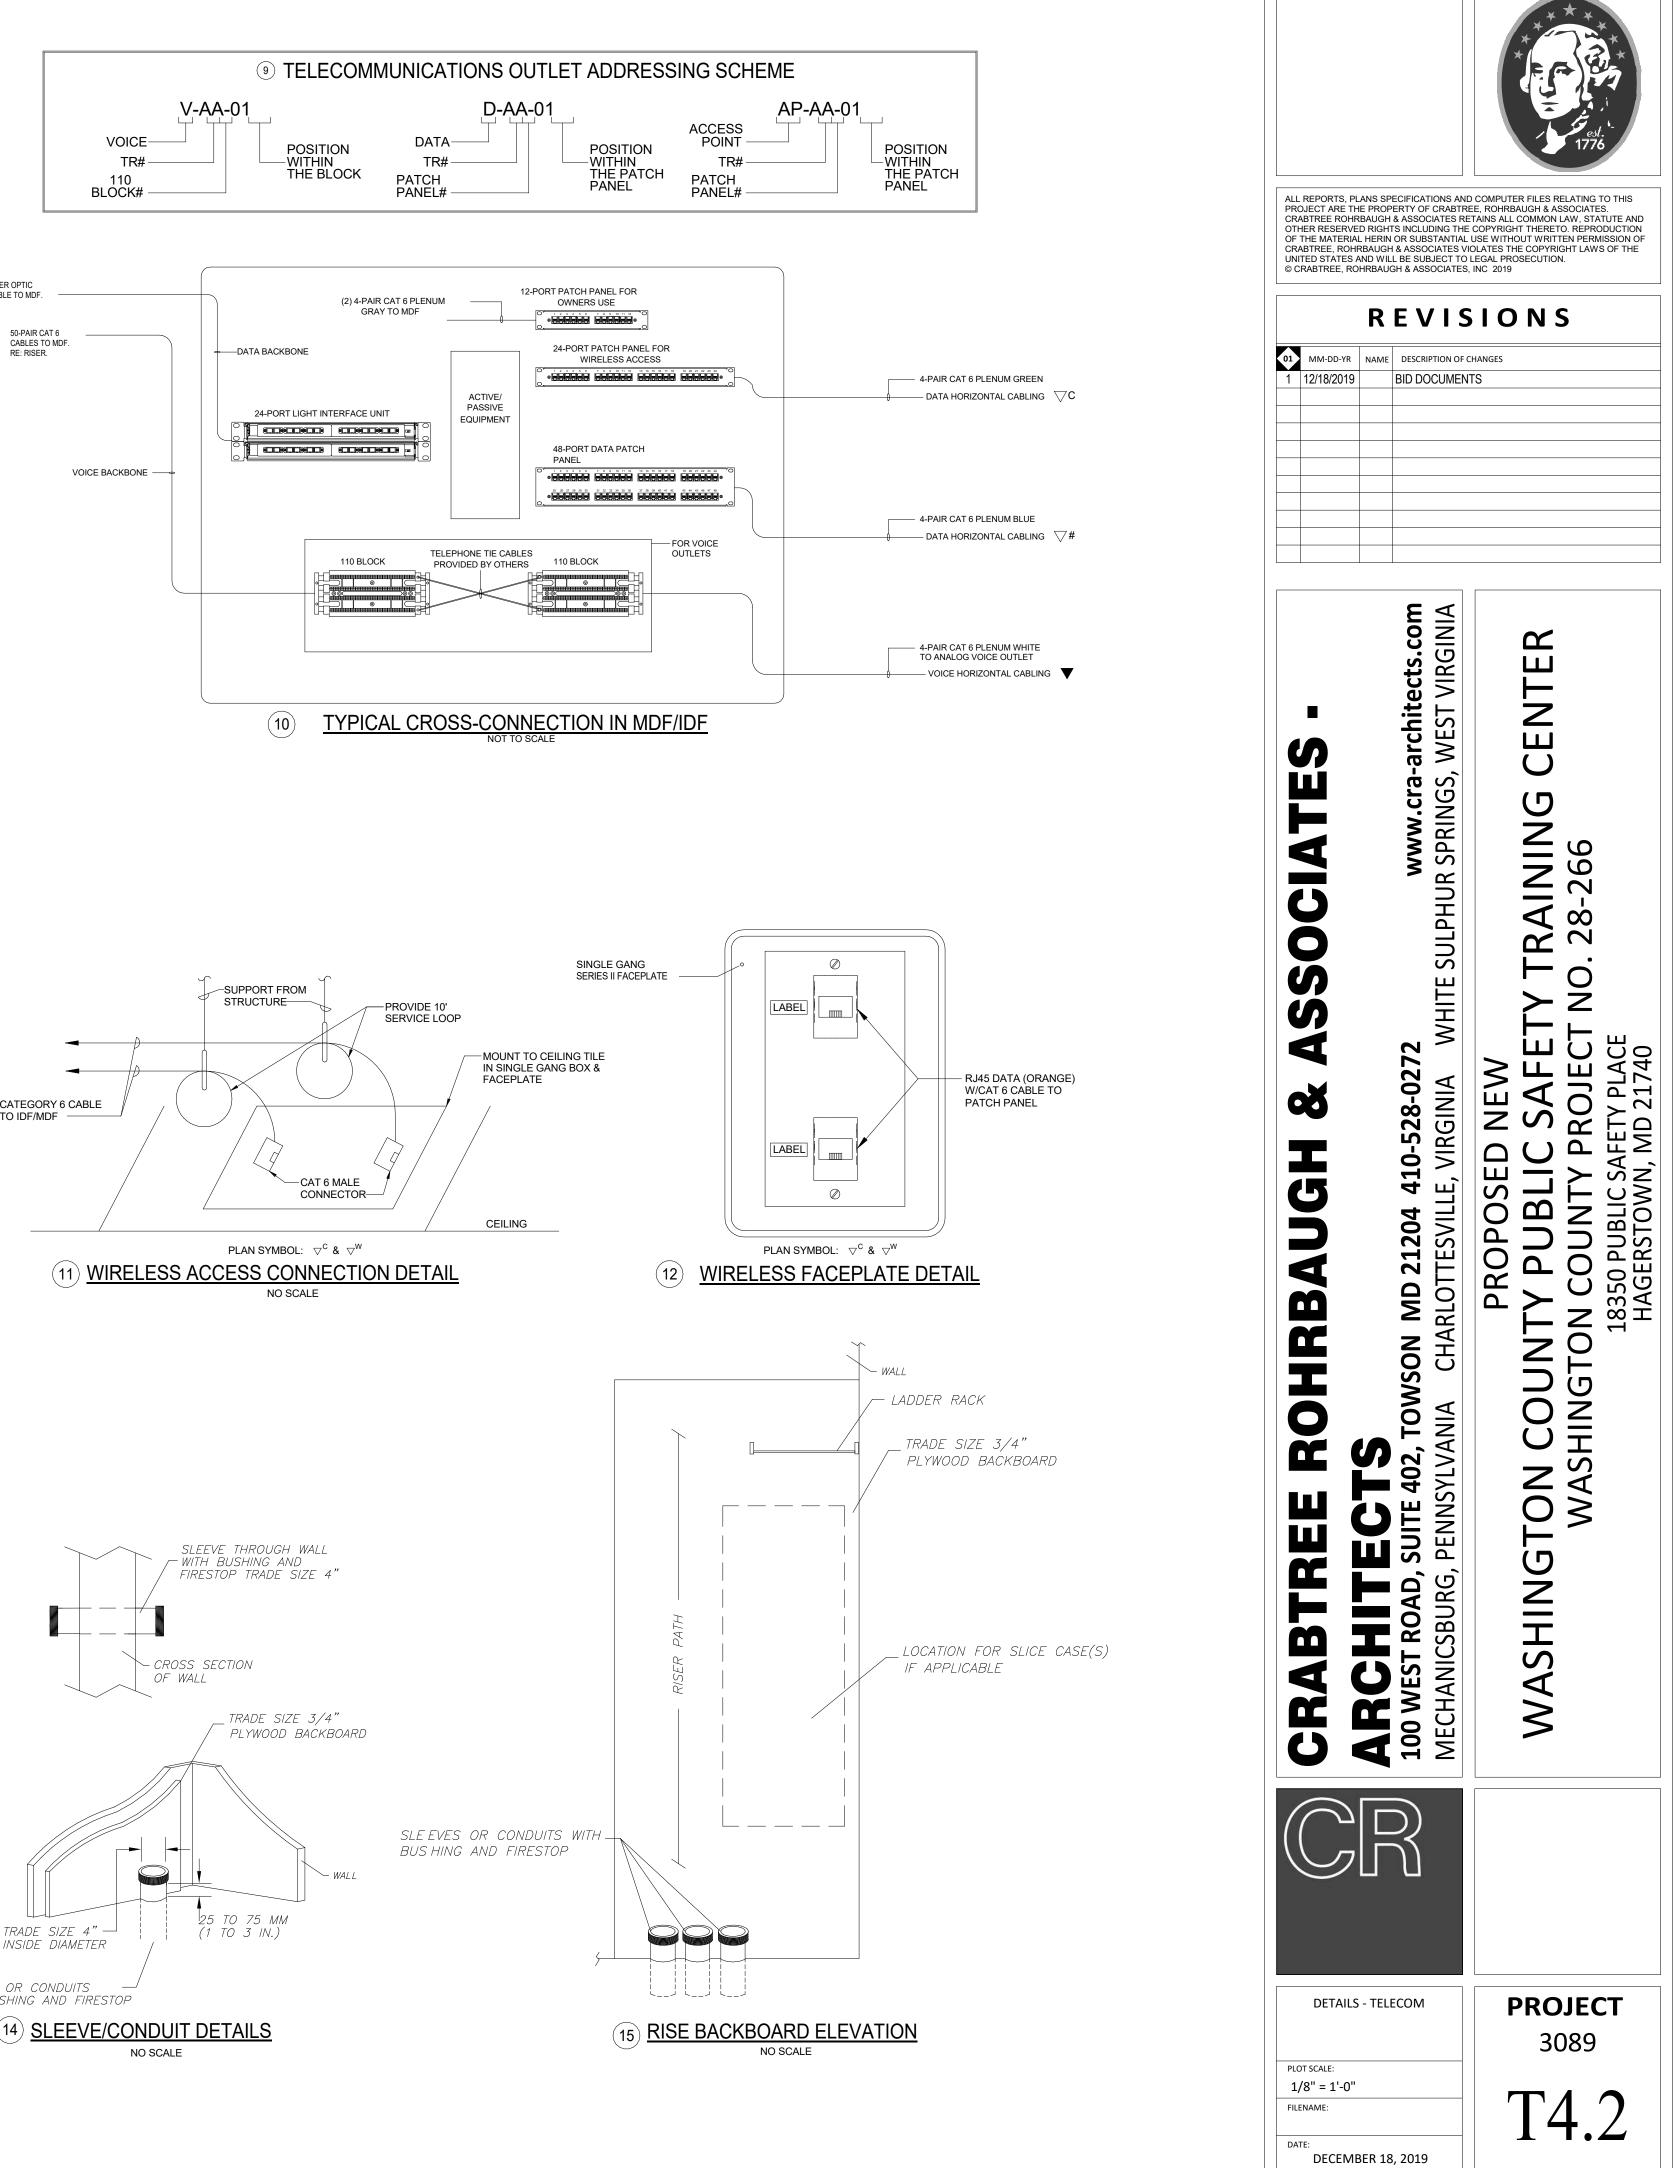

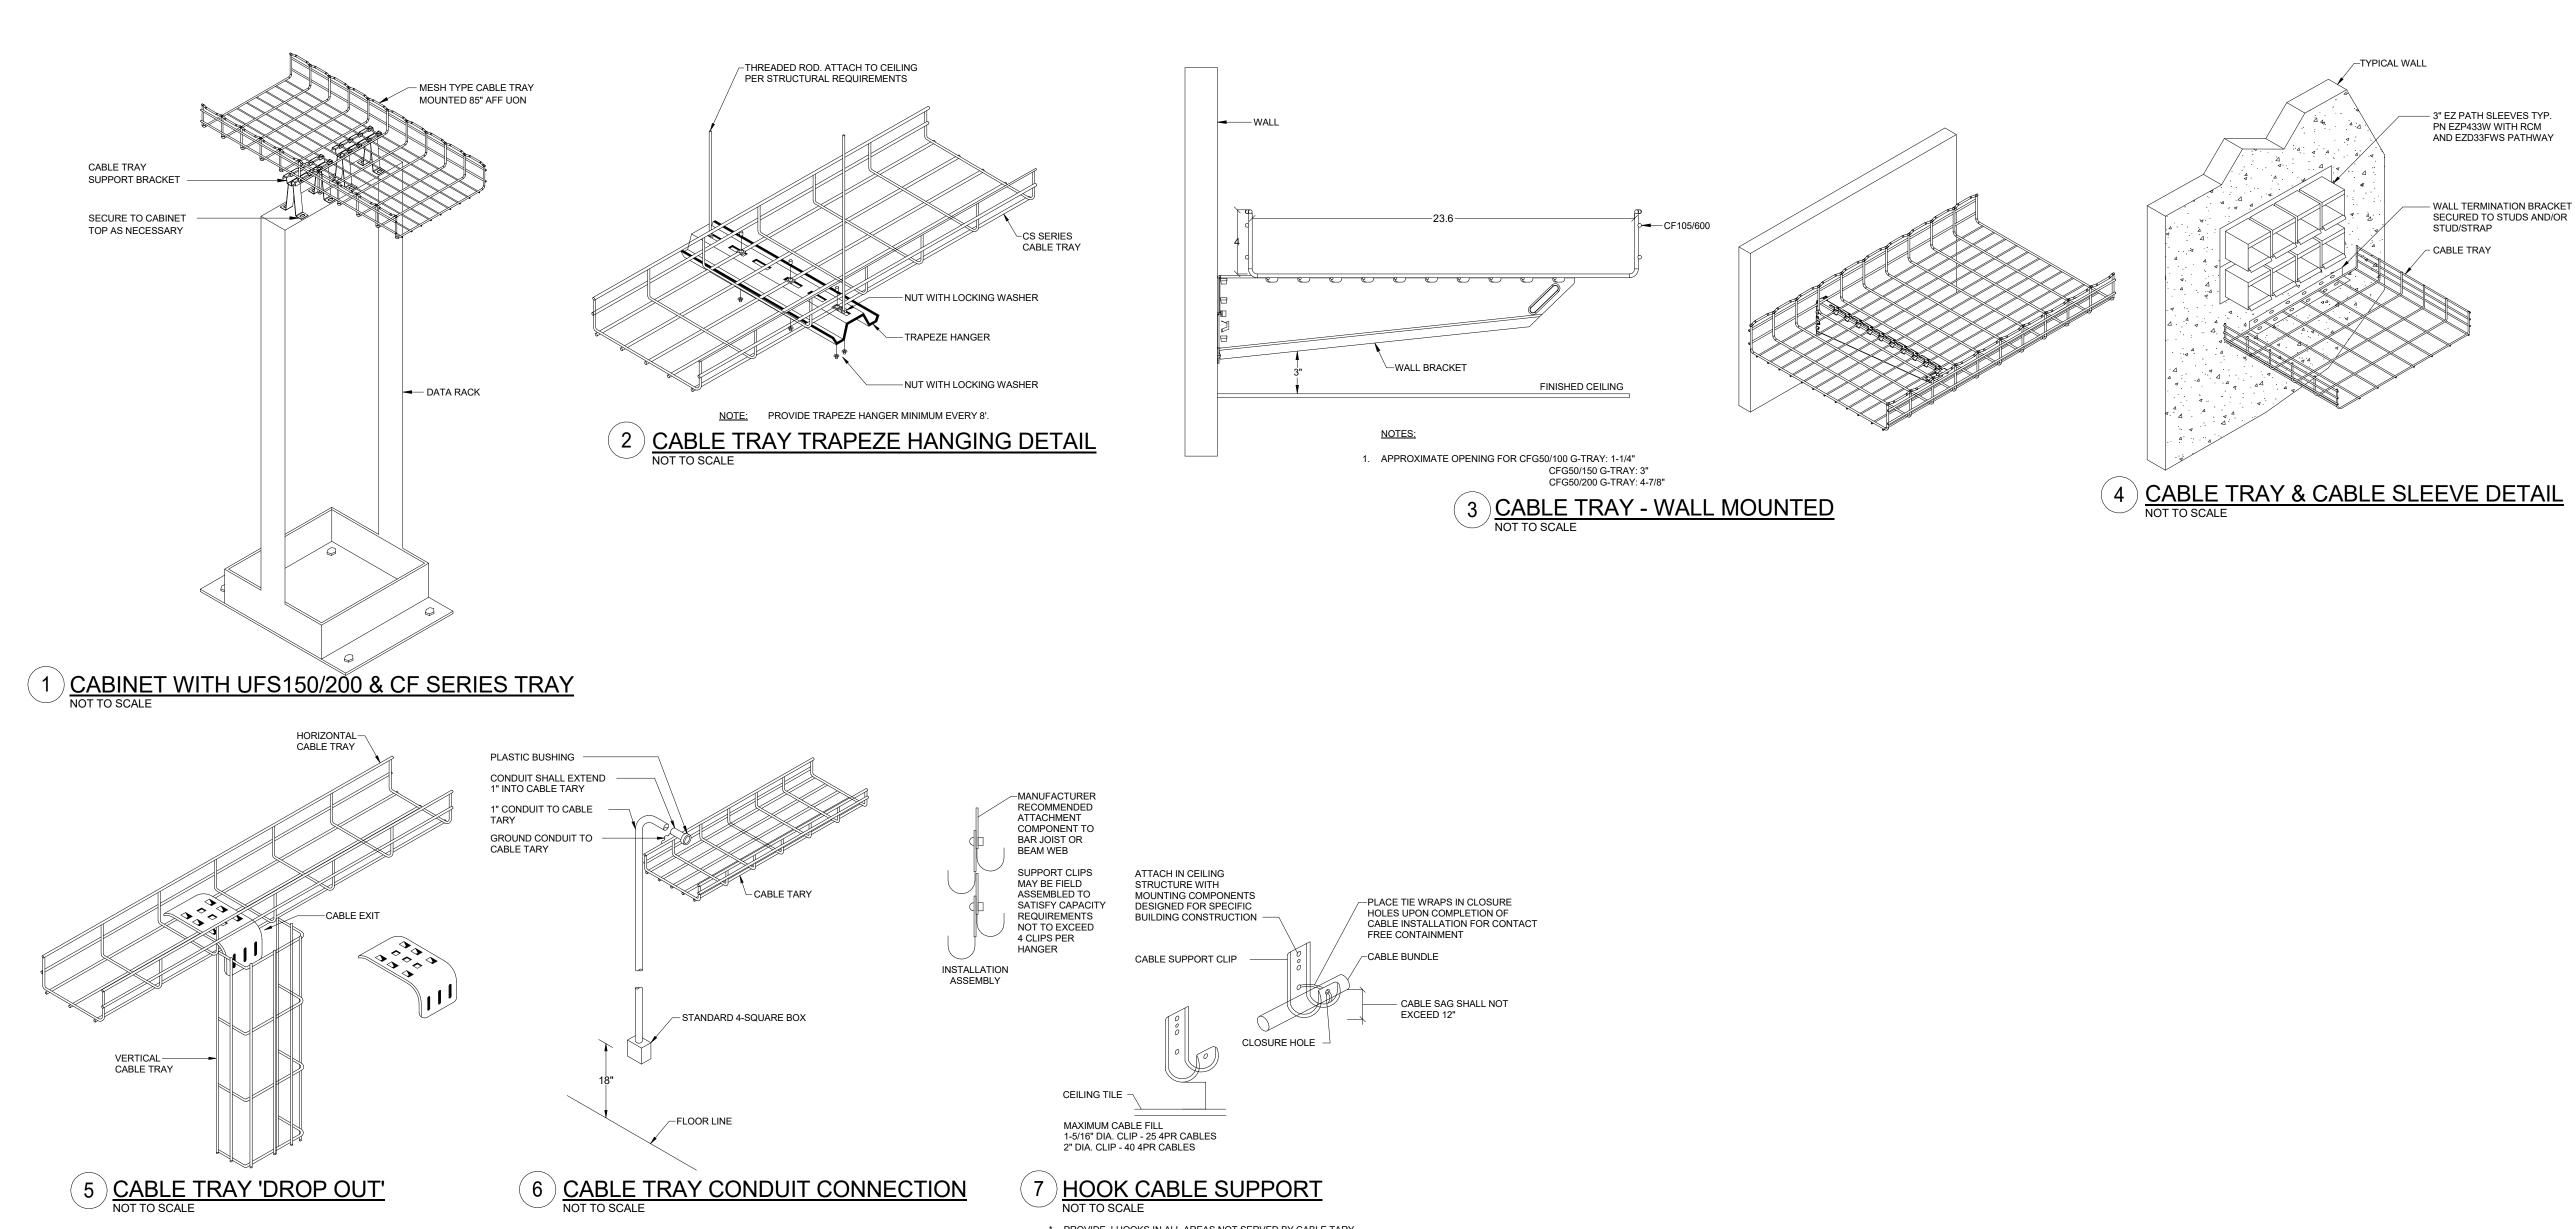

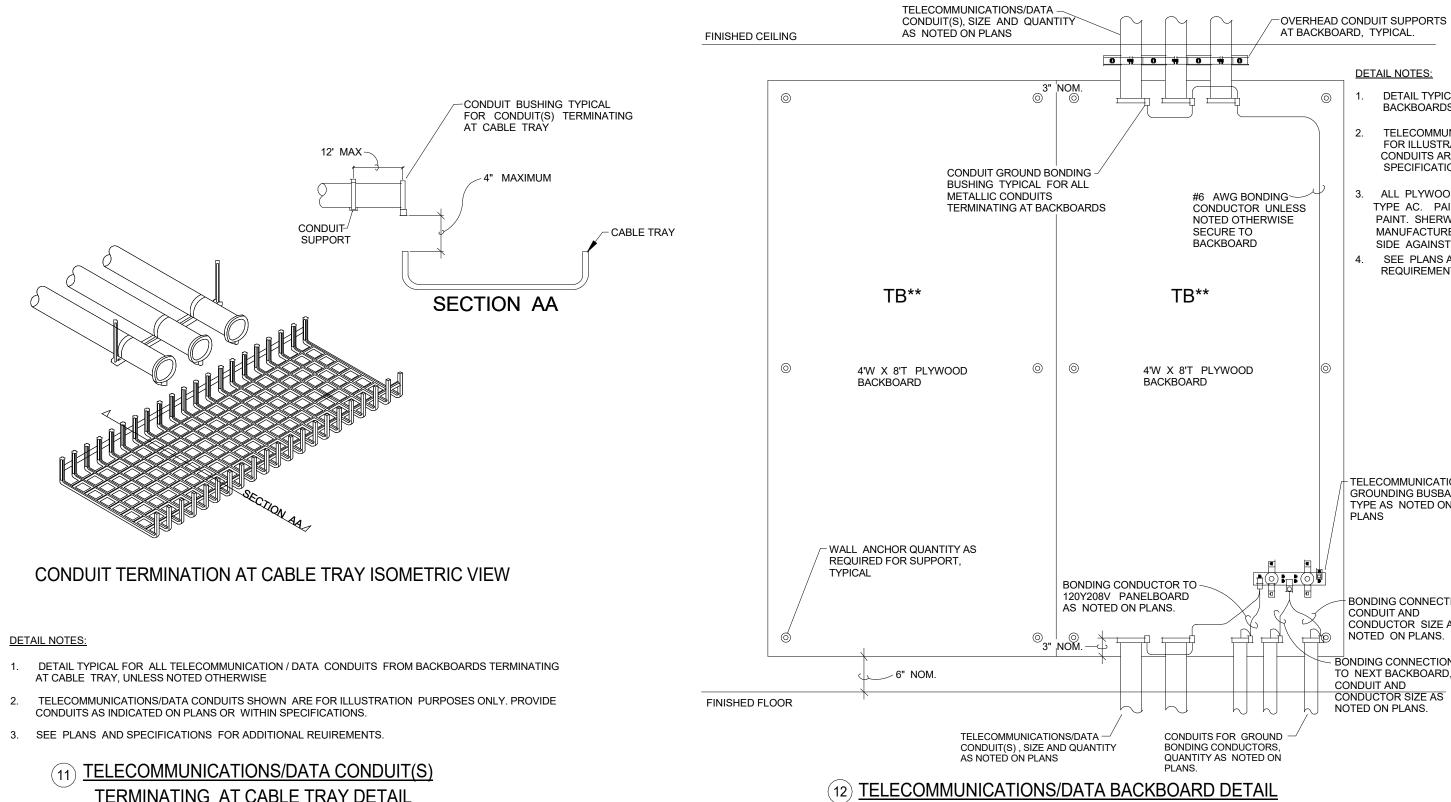

DETAIL NOTES:

* PROVIDE J-HOOKS IN ALL AREAS NOT SERVED BY CABLE TARY.

TERMINATING AT CABLE TRAY DETAIL

DETAIL NOTES:


- DETAIL TYPICAL FOR ALL TELECOMMUNICATIONS/ DATA BACKBOARDS. UNLESS NOTED OTHERWISE.
- TELECOMMUNICATIONS/DATA SHOWN ARE FOR ILLUSTRATIONS PURPOSE ONLY. PROVIDE CONDUITS ARE INDICATED ON PLANS AND WITHIN SPECIFICATIONS.
- ALL PLYWOOD BACKBOARDS SHALL BE $\frac{3}{4}$ " THICK TYPE AC. PAINT ALL 6 SIDES WITH FIRE RETARDANT PAINT. SHERWIN WILLIAMS "FLAME-CONTROL". PER MANUFACTURER'S RECOMMENDATIONS. MOUNT "C" SIDE AGAINST WALL.
- 4. SEE PLANS AND SPECIFICATIONS FOR ADDITIONAL REQUIREMENTS.


TELECOMMUNICATIONS GROUNDING BUSBAR, TYPE AS NOTED ON PLANS

BONDING CONNECTION, CONDUIT AND CONDUCTOR SIZE AS NOTED ON PLANS.

BONDING CONNECTION, TO NEXT BACKBOARD, CONDUIT AND CONDUCTOR SIZE AS NOTED ON PLANS.

SCALE: NONE

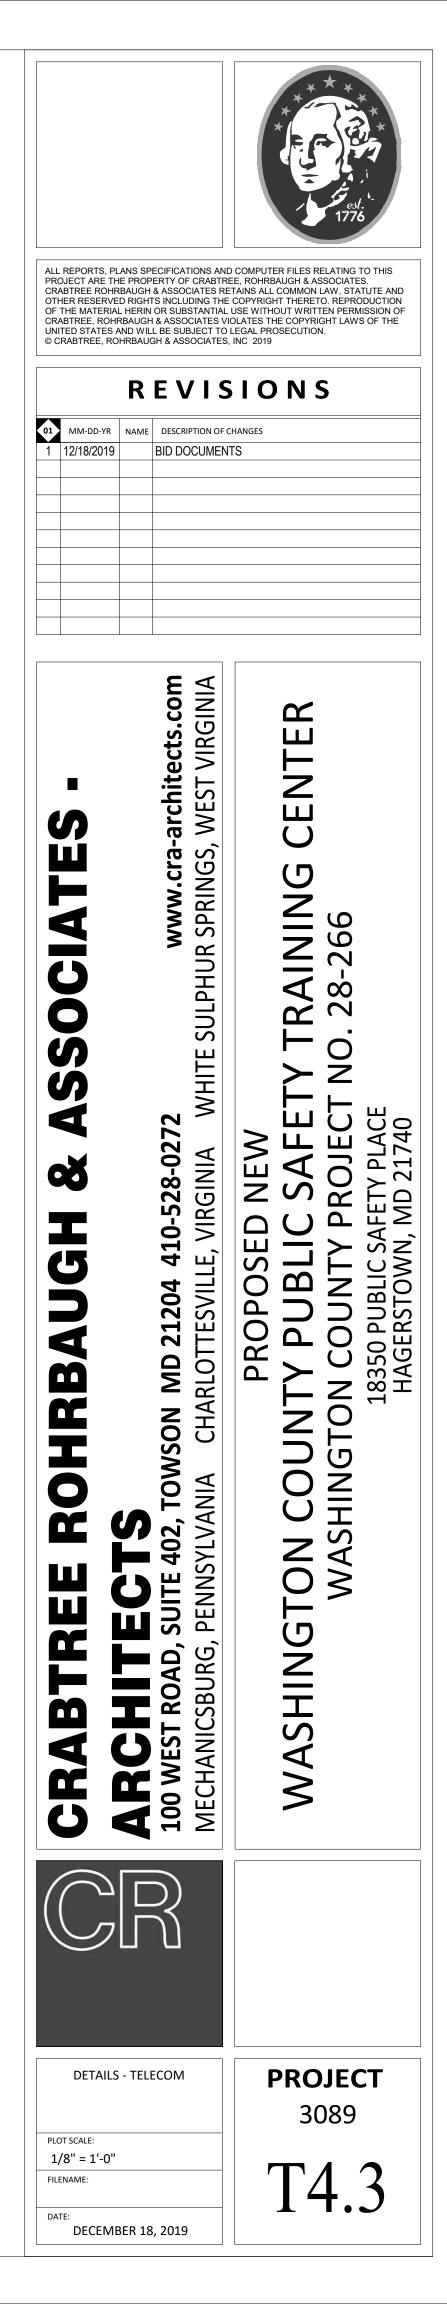

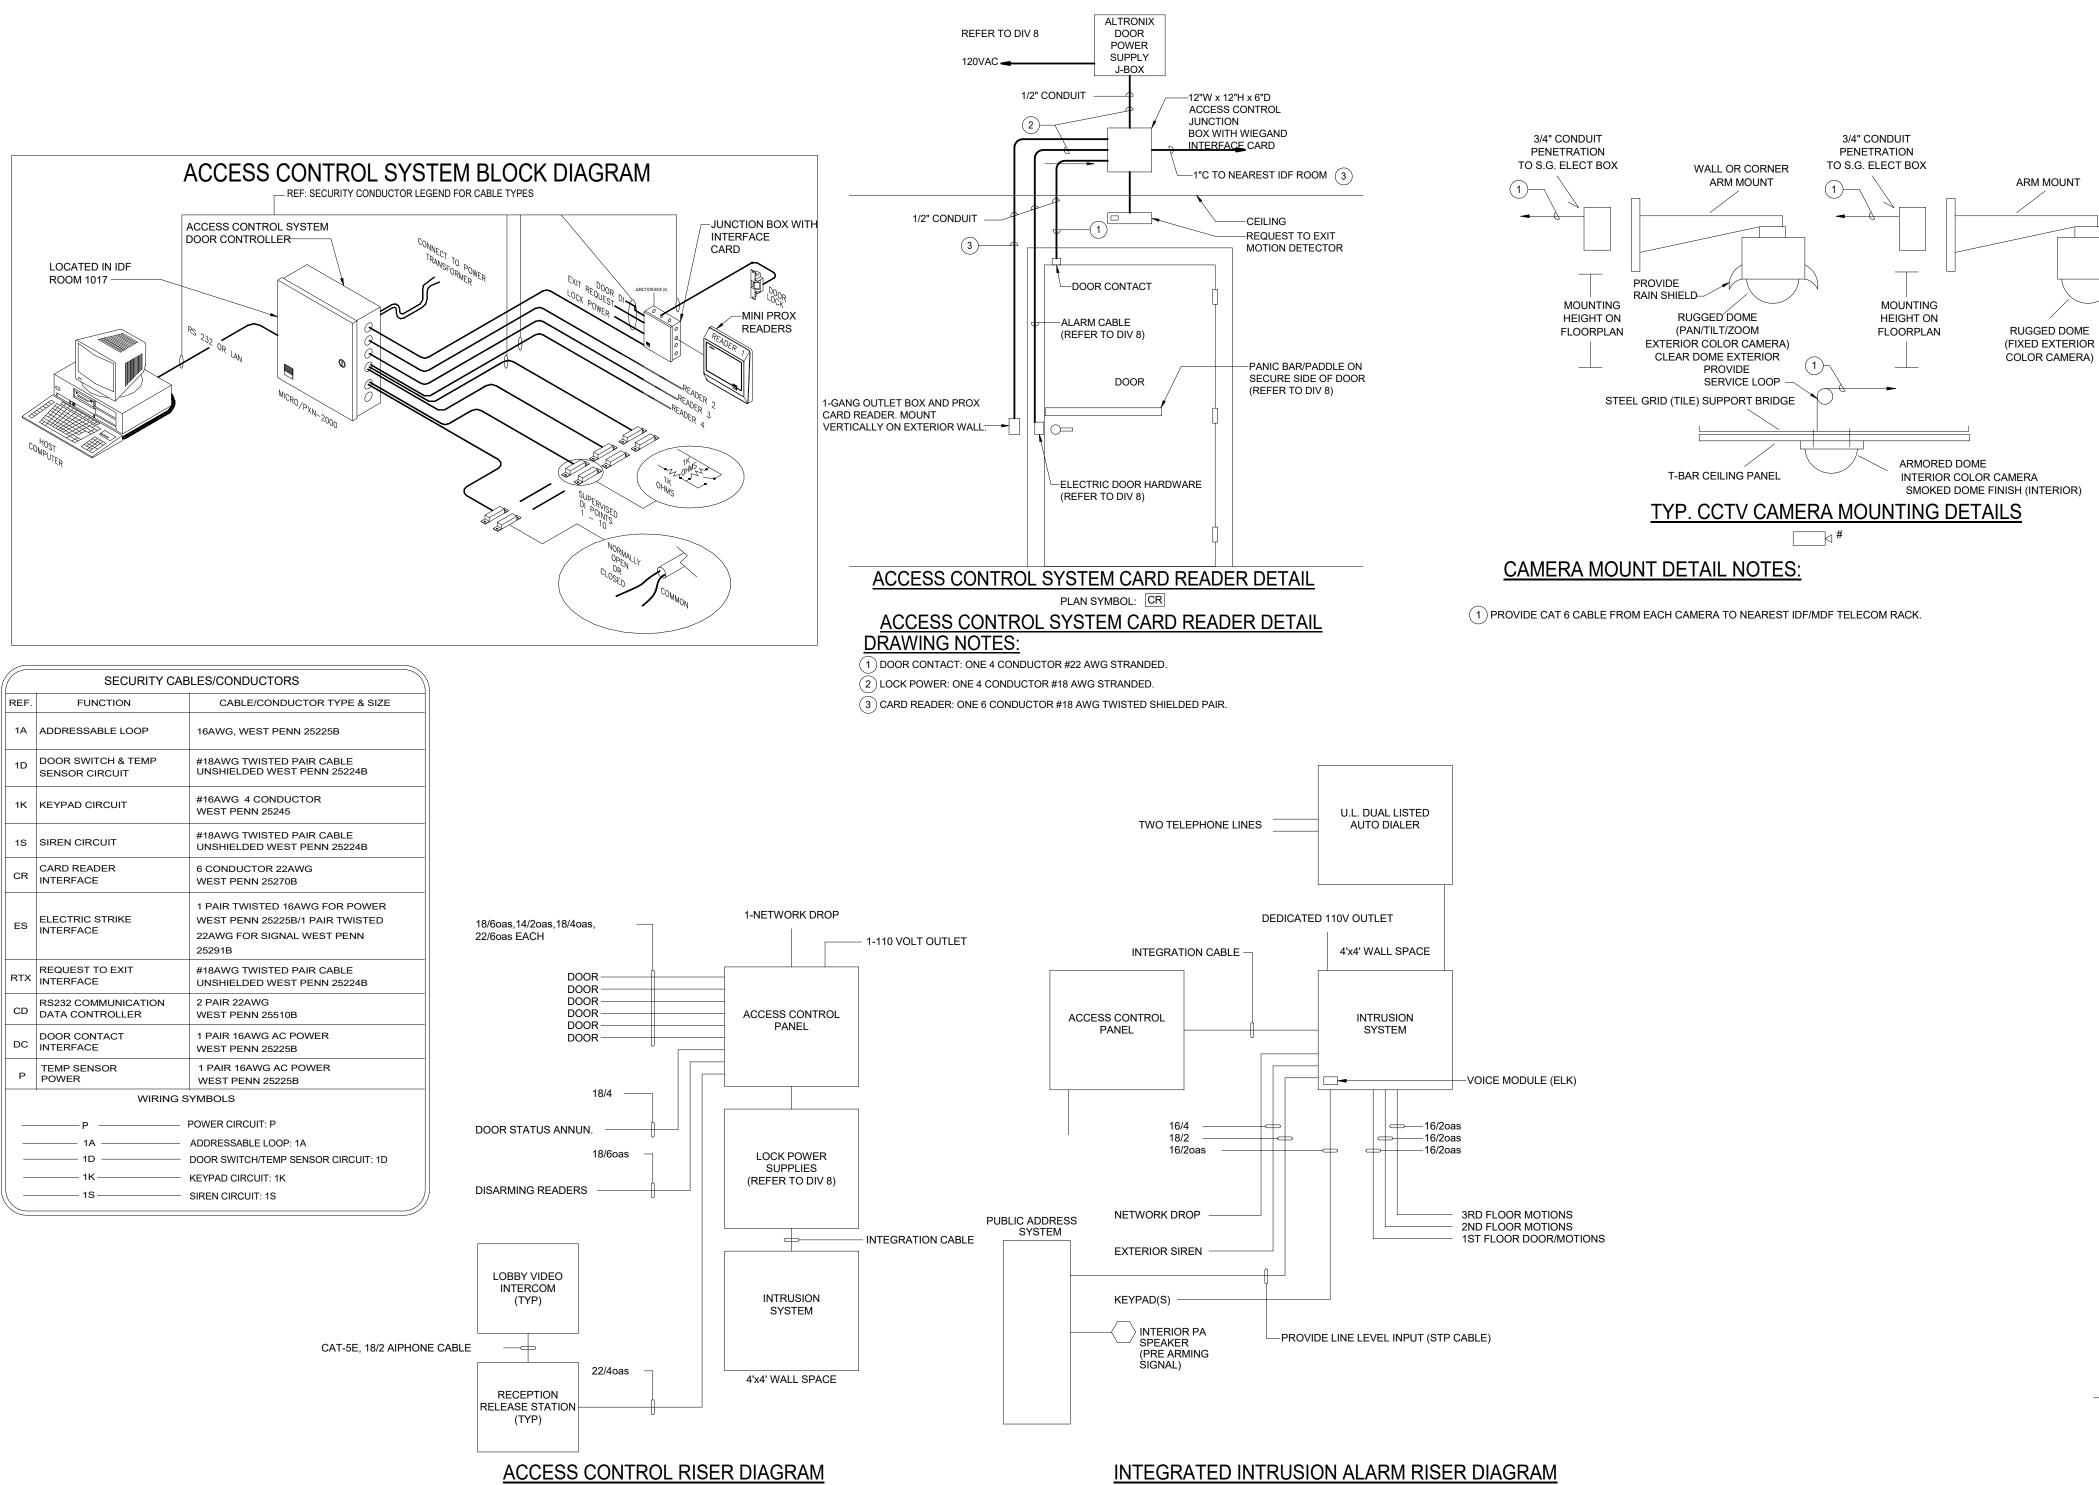

ACCESS CONTROL RISER DIAGRAM

NO SCALE

NO SCALE

